Stamp & initial

119 West First Street Cle Elum, WA 98922

Telephone · (509) 674-2262 Fax · (509) 674-4097

www.cityofcleelum.com



CONDITIONAL USE PERMIT APPLICATION

"Conditional use" means a use that would not be acceptable without restrictions throughout a zoning district and is not permitted by right within a zoning district but which may be permitted subject to meeting certain conditions contained in this title or as may be determined during the review process. See <u>CEMC 17.80</u> for more information.

OFFICAL USE ONLY			
Permit #:	CUP-20 -		
Staff Person:			
Fee Total:			
Associated Permits:			

Applicant				
Name: SAC Wireless on behalf of Vertical Bridge Development, LLC and T-Mobile West LLC				
Mailing Address: 8880 Cal Center Drive, Suite	130, Sacramento CA 95826			
Email: paulo.lopez@sacw.com	Phone Number: (916) 306-7082			
Property Owner	Same as applicant \Box			
Name: City of Cle Elum				
Mailing Address: 119 West First Street, Cle Elu	m, WA 98922			
Email: cityofcleelum.com	Phone Number: (509) 674-2262			
Property Information				
Project Name: Vertical Bridge US-WA-5105 Cl	e Elum / T-Mobile SE09034J Cle Elum DT-VB			
Address: Near E 5th Street & N Pennsylvania A	venue, Cle Elum, WA 98922			
Assessor's Parcel No.: 20-15-26050-2401; 20-15-26050-2403	Zoning: Residential			
Description of project:				
See attached.				

Ар	plic	ation Criteria ¹		
1.	Legal description of the subject property supplied by Kittitas County, a title company or survey licensed in the state of Washington.			
2.	sca inc	to hard copies and one electronic copy (PDF) of a site plan drawn to a minimum le of one inch equals two hundred feet on a sheet no larger than twenty-four hes by thirty-six inches and including one reduced size copy no larger than legal e. The site plan shall contain the following information.		
	a.	The subject property boundaries.		
	b.	Dimensions and size.		
	c.	Location, dimensions and height of all existing and proposed structures.		
	d.	Location of building accesses.		
	e.	Proposed setbacks. <u>CEMC 17</u>		
	f.	Proposed phasing.		
	g.	Proposed landscaping. <u>CEMC 17.64</u> .		
	h.	Location and dimensions of vehicle and pedestrian access points and circulation routes. <u>CEMC 17.56</u>		
	i.	The location of all proposed on-site parking including provisions for handicap parking.		
	j.	Any easements.		
	k.	The location of any proposed outdoor lights.		
	1. Any other proposed site improvements.			
3.		he applicant is not the legal owner a signed authorization from the legal owner is uired. ²		
4.	ope cor	itten narrative description of uses, types of structures proposed, hours of eration, abutting properties, proposed access, and frequency of deliveries, astruction schedule, and how the proposed use complies with the criteria ablished by <u>CEMC 17.80.050</u> .		
5.	Payment of a fee that is consistent with the City of Cle Elum's fee schedule.			
1.		pplication will not be processed and deemed incomplete if not all required criteria is not attached to application on the day bmission. The Planner may chooses to wave some of the required criteria. If any of the required criteria is provided in		

The application will not be processed and defined meanpite in not an required criteria is not attached to application on the d of submission. The Planner may chooses to wave some of the required criteria. If any of the required criteria is provided in another permit please cite that permit.
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^{2.} The owner can sign in allotted space provided under the authorization section of the application or send the City Planner a letter/email with authorization.

De	Decision Criteria			
1.	The proposed use will be designed and operated in a manner which is compatible with the character, appearance, and operation of existing or proposed development in the vicinity of the subject property			
2.	The hours and manner of operation of the proposed use are not inconsistent with adjacent or nearby uses			
3.	The proposed use is compatible with the physical characteristics of the subject property and neighboring properties			
4.	The location, nature and intensity of outdoor lighting is such that it is consistent with the surrounding neighborhood and does not cast light or glare on adjoining properties			
5.	The proposed use is such that it is pedestrian and vehicular traffic associated with the use will not be hazardous or conflict with existing and anticipated traffic in the neighborhood			
6.	The proposed use is capable of being served by public facilities and services, and will not adversely the level of service to surrounding areas			
7.	The proposed use is not detrimental to the public health, safety, or welfare			
8.	The proposed use is consistent with the goals and policies of the comprehensive plan;			
9.	The subject site can accommodate the proposed use considering the size, shape, topography and drainage.			
Au	thorization			
Const.				

The undersigned herby certifies, under penalty of perjury, that this application has been made with the consent of the lawful property owner(s) and that all information submitted with this application is complete and correct. Furthermore, false statements, errors, and/or omissions may be sufficient for denial of request. The applicant further agrees to reimburse the city for all expenses associated with reviewing the application. This application gives consent to the City to enter the properties listed above for the purposes of inspecting and verifying information presented in this application.

Applicant Signature: Paulo Loper on behalf of Vertical Bridge Development,	Date: 4/19/2019
Owner Signature:	Date: 5/20/2019

Vertical Bridge US-WA-5105 Cle Elum / T-Mobile SE09034J Cle Elum DT-VB CUP-2019-002; SDR-2019-002; VAR-2019-002

Site and Design Review Application Criteria

1. Written narrative description of-uses, types of structures proposed, hours of operation, abutting properties, proposed access, frequency of deliveries, and construction schedule, including any proposed phasing of development. *[See application narrative below]*

An unmanned 153-foot wireless communications facility is proposed on City of Cle Elum property, within a proposed approximately 0.09-acre (4000 square foot) overall lease area for associated T-Mobile and future carriers ground equipment. The proposed tower and compound are to be located Near E 5th Street & N Pennsylvania Avenue in Cle Elum, Kittitas County, Washington on a sparsely wooded hillside with multiple rock outcroppings. Site soils exhibit relatively low infiltration potential. The ground topography is lightly sloping with existing grades across the project site ranging from approximately 0 to 30 percent, with approximately 16 feet of elevation change across the planned lease area. The project site consists primarily of forested area and is currently undeveloped, except for an existing gravel road which provides access from E 5th St, to the west of the site and N Montgomery Ave to the east. Vertical Bridge is the tower company; T-Mobile is the anchor tenant. The proposed tower coordinates are 47°11′51.88″ N, 120°55′59.77″ W.

Construction of the 153' cellular tower and associated equipment shelter, generator, fuel tank, power utilities, and accesses are proposed within a 0.06-acre (2,418 square foot) portion of the lease area on the east side of the property. The project will disturb approximately 0.09 acres and proposes approximately 0.06 acres of new impervious surfaces near the northeast portion of parcels 20-15-26050-2401 and 20-15-26050-2403. Planned retaining wall with drainage system and a maximum height of 11 feet installed around the 1600 square foot T-Mobile lease area and the 800 square foot proposed other carrier equipment lease area. Import materials will be used for backfilling behind the retaining wall. Vertical Bridge will install separate gates for each carrier along the northside of the lease area for access during construction and for maintenance operations. The T-Mobile lease area accessed via an 8-foot tall chain link fence with 10-foot wide gate. Utilities will run underground along access road with power and transport along the same trench.

The existing access road will be graded from the edge of the asphalt to the tower with an acceptable base, crushed surfacing maintained by the tower company. Construction activities include clearing and grading and the construction of crushed rock site pad, retaining walls, and 153' tower with associated equipment shelter, fuel tank, and power utilities. Vehicular traffic mostly during construction of site lasting approximately 45-60 days. Light duty truck for maintenance operations each 3-4 weeks after site goes On-Air. The site may be accessed 24/7 via a shared access tamper-proof gate using an access code in case of an emergency.

- 2. Two hard copies and one electronic copy (PDF) of an existing conditions plan drawn to a minimum scale of one inch equals two hundred feet on a sheet no larger than twenty-four inches by thirty-six inches and including one reduced size copy no larger than legal size. The existing conditions plan shall contain the following features: *[See Survey]*
 - a. The subject property boundaries
 - b. Dimensions and size
 - c. Current structural or landscape setbacks
 - d. Location of existing on-site driveways and access points within one hundred feet of the subject site
 - e. Location and dimension of any on-site structures

Vertical Bridge US-WA-5105 Cle Elum / T-Mobile SE09034J Cle Elum DT-VB CUP-2019-002; SDR-2019-002; VAR-2019-002

- f. Location of utilities
- g. Location of the nearest fire hydrant
- h. Location of existing structures within one hundred feet of the site
- i. Locations and dimensions of adjacent public or private roads and right-of-way or easements
- j. Approximate location of significant natural features including slopes over twenty-five percent, waterbodies, rock outcrops, wetland areas, areas of significant vegetation, the location of trees or groups of trees over six inches in diameter, and the location of any critical areas
- 3. Two hard copies and one electronic copy (PDF) of a site plan drawn to a minimum scale of one inch equals two hundred feet on a sheet no larger than twenty-four inches by thirty-six inches and including one reduced size copy no larger than legal size. The site plan shall contain the following information: *[See Zoning Drawings]*
 - a. The subject property boundaries
 - b. Dimensions and size
 - c. Location
 - d. Dimensions and height of all proposed structures
 - e. Location of building accesses
 - f. Proposed setbacks
 - g. Proposed phasing
 - h. Proposed landscaping
 - i. Location and dimensions of vehicle and pedestrian access points and circulation routes
 - j. The location of all proposed on-site parking including provisions for handicap parking
 - k. Any easements
 - I. The location of any proposed lights, and any other proposed site improvements
- 4. Two hard copies and one electronic copy (PDF) of proposed architectural elevations. *[See Zoning Drawings]*
- 5. Preliminary grading, erosion control and stormwater plan [See SWPP]
- 6. Preliminary utility plan [See Zoning Drawings]
- 7. Any other items that are necessary to review the proposed development [Geotech Report; Drainage Report; Drainage Site Plans; Photo Simulations]
- 8. Payment of a fee that is consistent with the City of Cle Elum's fee schedule [Delivered via UPS on 4/17/2019]

Conditional Use Permit Application Criteria


- 1. Legal description of the subject property supplied by Kittitas County, a title company or survey licensed in the state of Washington. [*See Survey*]
- 2. Two hard copies and one electronic copy (PDF) of a site plan drawn to a minimum scale of one inch equals two hundred feet on a sheet no larger than twenty-four inches by thirty-six inches and including one reduced size copy no larger than legal size. The site plan shall contain the following information. *[See Zoning Drawings]*
 - a. The subject property boundaries.
 - b. Dimensions and size.
 - c. Location, dimensions and height of all existing and proposed structures.
 - d. Location of building accesses.

Vertical Bridge US-WA-5105 Cle Elum / T-Mobile SE09034J Cle Elum DT-VB CUP-2019-002; SDR-2019-002; VAR-2019-002

- e. Proposed setbacks. CEMC 17
- f. Proposed phasing.
- g. Proposed landscaping. CEMC 17.64.
- h. Location and dimensions of vehicle and pedestrian access points and circulation routes. CEMC 17.56
- i. The location of all proposed on-site parking including provisions for handicap parking.
- j. Any easements.
- k. The location of any proposed outdoor lights.
- I. Any other proposed site improvements.
- 3. If the applicant is not the legal owner a signed authorization from the legal owner is required. *[City of Cle Elum is property owner and will sign application]*
- 4. Written narrative description of uses, types of structures proposed, hours of operation, abutting properties, proposed access, and frequency of deliveries, construction schedule, and how the proposed use complies with the criteria established by CEMC 17.80.050. [See application narrative above and answers to questions on combined Site Design Review and Conditional Use Permit Draft Staff Report]
- 5. Payment of a fee that is consistent with the City of Cle Elum's fee schedule. [Delivered Via UPS on 4/17/2019]

Variance Application Requirements

- 1. Site plan indicating location of property boundaries, proposed improvements, existing access locations and dimensions, site improvements, adjacent public streets and driveway, the specific location of the variance and any features of the property that are present that cause the need for the variance. *[See Zoning Drawings]*
- 2. A map indicating the subject property and boundaries. [See Survey]
- 3. If the applicant is not the legal owner a signed authorization from the legal owner is required. [City of Cle Elum is property owner and will sign application]
- 4. Written narrative describing the project, and how the proposed variance complies with the decision criteria listed below. *[See application narrative above and answers to questions on Draft Variance Staff Report]*
- 5. Payment of a fee that is consistent with the City of Cle Elum's fee schedule. [Delivered Via UPS on 4/17/2019]

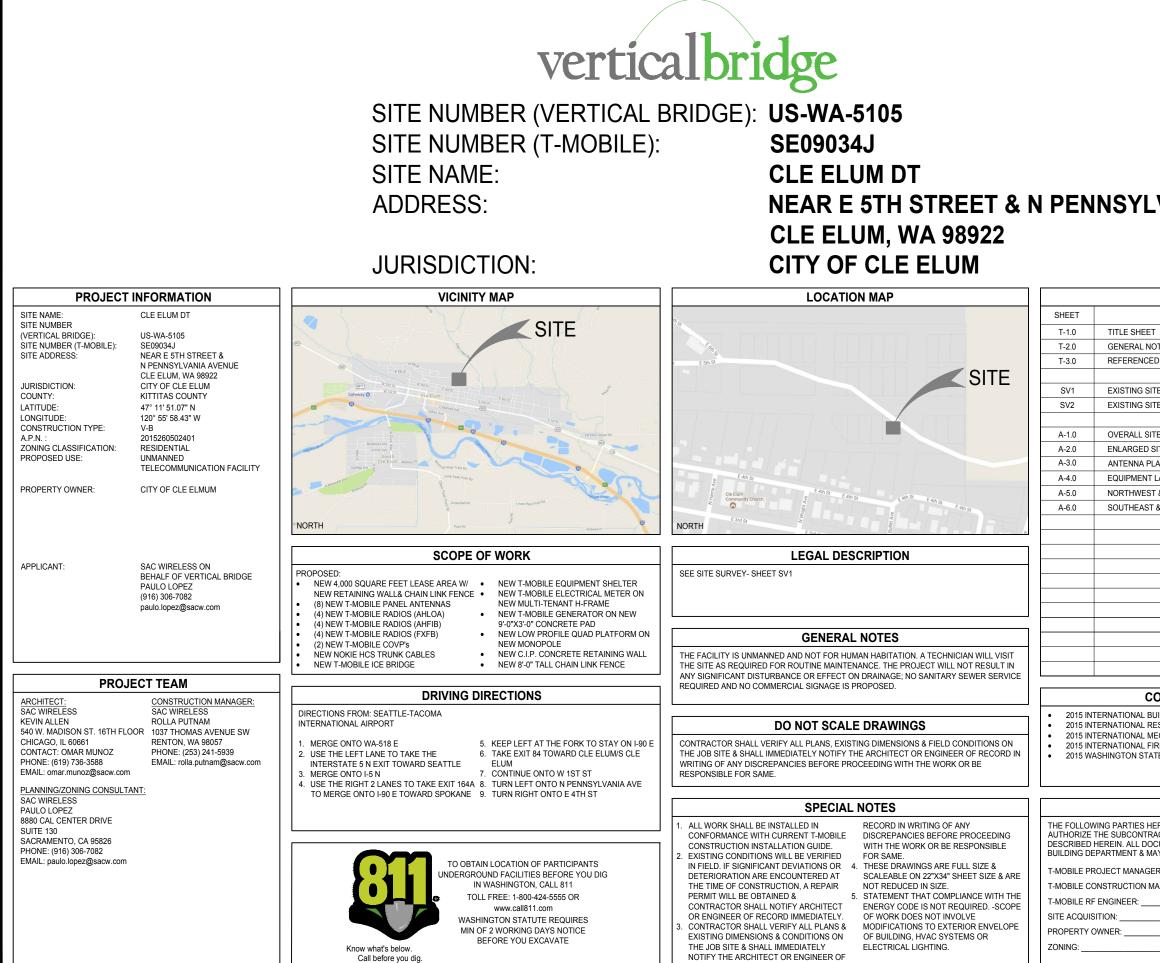

Q:\\$TELE\\$T-MOBILE PROJECTS\SEATTLE SITES\SE09034J (NSB)NSB PROJECTNSB_ZD'S\TMO_L1900_SE09034J_ZD.DWG - 2019-05-31 - SRoll

	VERTICAL BRIDGE HOLDINGS, LLC 750 PARK OF COMMERCE DRIVE, SUITE 200 BOCA RATON, FL 33487
VANIA AVENUE	10509 VISTA SORRENTO PKWY #206 SAN DIEGO, CA 92121 T-MOBILE COM
DESCRIPTION	REVISIONS
T	0 02/01/19 PZD SR
OTES ED DOCUMENTS, ABBREVIATIONS, LEGEND & SIGNAGE	1 02/19/19 FZD SR
2 2000 MENTO, ABBREVIATIONO, ELGEND & ORIGINAGE	2 05/31/19 NEW RFDS SR
TE SURVEY	
TE SURVEY	
TE PLAN	
SITE PLAN	
LAN AND MOUNTING DETAILS	
T & NORTHEAST ELEVATIONS	
& SOUTHWEST ELEVATIONS	
CODE COMPLIANCE UILDING CODE LESIDENTIAL CODE IECHANICAL CODE IECHANICAL CODE IECHANICAL CODE	DATE: "I HEREBY CERTIFY THAT THESE PLANS WERE PREPARED BY ME AND UNDER MY DIRECT SUPERVISION AND THAT I AN DULY REGISTERED ARCHITECT UNDER THE LAWS OF THE STATE OF WASHINGTON" CLE ELUM DT US-WA-5105 NEADE ETH STDEET & N
ITE ENERGY CODE	NEAR E 5TH STREET & N PENNSYLVANIA AVENUE CLE ELUM, WA 98922 SHEET TITLE
APPROVALS]]
EREBY APPROVE AND ACCEPT THESE DOCUMENTS & ACTOR TO PROCEED WITH THE CONSTRUCTION CUMENTS ARE SUBJECT TO REVIEW BY THE LOCAL AY IMPOSE CHANGES OR MODIFICATIONS.	TITLE SHEET
DATE: DATE:	
DATE: DATE:	SHEET NUMBER
DATE:	
DATE:	T-1.0
	11

GENERAL NOTES:

- THIS FACILITY IS EXEMPT FROM ACCESSIBILITY REQUIREMENTS PER 2015 IBC SECTION 1103.2.9. THIS FACILITY IS NON-OCCUPIABLE SPACE AND ENTERED ONLY BY SERVICE PERSONNEL
- ALL WORK SHALL CONFORM TO THE REQUIREMENTS OF THE LOCAL BUILDING CODE, THE LATEST EDITION AND ALL OTHER APPLICABLE CODES AND ORDINANCES
- CONTRACTOR SHALL CONSTRUCT SITE IN ACCORDANCE WITH THESE DRAWINGS AND CONSTRUCTION SPECIFICATIONS 80-T1196-1 REV H. THE SPECIFICATION IS THE RULING DOCUMENT AND ANY DISCREPANCIES BETWEEN THE SPECIFICATION AND THESE DRAWINGS SHOULD BE BROUGHT TO THE ATTENTION OF THE ARCHITECT OR ENGINEER OF RECORD PRIOR TO PROCEEDING WITH CONSTRUCTION.
- CONTRACTOR SHALL VISIT THE JOB SITE AND SHALL FAMILIARIZE HIMSELF WITH ALL CONDITIONS AFFECTING THE PROPOSED WORK AND SHALL MAKE PREVISIONS AS TO THE COST THEREOF. CONTRACTOR SHALL BE RESPONSIBLE FOR FAMILIARIZING HIMSELF WITH ALL CONTRACT DOCUMENTS, FIELD CONDITIONS AND DIMENSIONS AND CONFORMING THAT THE WORK MAY BE ACCOMPLISH AS SHOWN PRIOR TO PROCEEDING WITH CONSTRUCTION, ANY DISCREPANCIES SHALL BE BROUGHT TO THE ATTENTION OF THE ARCHITECT OR ENGINEER OF RECORD PRIOR TO THE COMMENCEMENT OF WORK, NO COMPENSATION WILL BE AWARDED BASED ON CLAIM OF LACK OF KNOWLEDGE OF FIELD CONDITIONS.
- PLANS ARE NOT TO BE SCALED. THESE PLANS ARE INTENDED TO BE A DIAGRAMMATIC OUTLINE ONLY UNLESS OTHERWISE NOTED. THE WORK SHALL INCLUDE FURNISHING MATERIALS, EQUIPMENT AND APPURTENANCES, AND LABOR NECESSARY TO EFFECT ALL INSTALLATIONS AS INDICATED ON THE DRAWINGS. OWNER PROVIDED MATERIALS WILL INCLUDE THE FOLLOWING, UNLESS NOTED OTHERWISE
 - A. TRANSMITTER
- B RE FILTER
- METS RACKS
- AUXILIARY EQUIPMENT IN MFTS RACK PUMP ASSEMBLY
- HEAT EXCHANGE
- HOSE AND HOSE MANIFOLD (ANY COPPER OR STEEL SECTION PROVIDED BY CONTRACTOR)
- UHF ANTENNA AND MOUNTING BRACKET, GPS ANTENNA AND KU ANTENNAS
- LIHE COAX AND HANGERS
- 480-208 & 208-400 ELECTRICAL TRANSFORMER (RE: E-2 FOR SPECIALIZED TRANSFORMER PROVIDED BY
- CONTRACTOR) AUTOMATIC TRANSFER SWITCH AND GENERATOR
- EQUIPMENT SHELTER (SHELTER FURNISH IN FACTORY W/HVAC EQUIPMENT AND ELECTRICAL DISTRIBUTION PANEL)
- M. INTEGRATED LOAD CENTER
- ANTENNAS, RADIOS & CABLES
- DIMENSIONS SHOWN ARE TO FINISH SURFACES UNLESS OTHERWISE NOTED. SPACING BETWEEN EQUIPMENT IS REQUIRED CLEARANCE. THEREFORE, IT IS CRITICAL TO FIELD VERIFY DIMENSIONS, SHOULD THERE BE ANY QUESTIONS REGARDING THE CONTRACT DOCUMENTS, EXISTING CONDITIONS AND/OR DESIGN INTENT, THE CONTRACTOR SHALL BE RESPONSIBLE FOR OBTAINING THE WORK
- DETAILS ARE INTENDED TO SHOW DESIGN INTENT. MODIFICATIONS MAY BE REQUIRED TO SUIT JOB DIMENSIONS OR CONDITIONS, AND SUCH MODIFICATIONS SHALL BE INCLUDED AS PART OF THE WORK.
- CONTRACTOR SHALL RECEIVE CLARIFICATION IN WRITING AND SHALL RECEIVE IN WRITING AUTHORIZATION TO PROCEED BEFORE STARTING WORK ON ANY ITEMS NOT CLEARLY DEFINED OR IDENTIFIED BY THE CONTRACT DOCUMENT.
- CONTRACTOR SHALL SUPERVISE AND DIRECT THE WORK USING THE BEST CONSTRUCTION SKILLS AND ATTENTION. CONTRACTOR SHALL BE SOLELY RESPONSIBLE FOR CONSTRUCTION MEANS, METHODS, TECHNIQUES, SEQUENCES AND PROCEDURES AND FOR COORDINATING ALL PORTIONS OF THE WORK UNDER CONTRACT, UNLESS OTHERWISE NOTED.
- CONTRACTOR SHALL BE RESPONSIBLE FOR THE SAFETY OF THE WORK AREA, ADJACENT AREAS AND BUILDING OCCUPANTS THAT ARE LIKELY TO BE AFFECTED BY THE WORK UNDER THIS CONTRACT. WORK SHALL CONFORM TO ALL OSHA REQUIREMENTS
- CONTRACTOR SHALL COORDINATE HIS WORK WITH THE SUPERINTENDENT OF THE BUILDING & GROUNDS & SCHEDULE HIS ACTIVITIES AND WORKING HOURS IN ACCORDANCE WITH THE REQUIREMENTS.
- CONTRACTOR SHALL BE RESPONSIBLE FOR COORDINATING HIS WORK WITH THE WORK OF OTHERS AS IT MAY RELATE TO RADIO EQUIPMENT, ANTENNAS AND ANY OTHER PORTIONS OF THE WORK.
- INSTALL ALL EQUIPMENT AND MATERIAL IN ACCORDANCE WITH MANUFACTURER'S RECOMMENDATIONS UNLESS SPECIFICALLY OTHERWISE INDICATED OR WHERE LOCAL CODES OR REGULATIONS TAKE PRECEDENCE.
- MAKE NECESSARY PROVISIONS TO PROTECT EXISTING SURFACE, EQUIPMENT, IMPROVEMENTS, PIPING, ETC. 14 AND IMMEDIATELY REPAIR ANY DAMAGE THAT OCCURS DURING CONSTRUCTION.
- 15 IN DRILLING HOLES INTO CONCRETE WHETHER FOR FASTENING OR ANCHORING PURPOSES, OR PENETRATIONS THROUGH THE FLOOR FOR CONDUIT RUNS, PIPE RUNS, ETC., IT MUST BE CLEARLY UNDERSTOOD THAT REINFORCING STEEL SHALL NOT BE DRILLED INTO, CUT OR DAMAGED UNDER ANY CIRCUMSTANCES (UNLESS NOTED OTHERWISE). LOCATIONS OF REINFORCING STEEL ARE NOT DEFINITELY KNOWN AND THEREFORE MUST BE SEARCHED FOR BY APPROPRIATE METHODS AND EQUIPMENT
- REPAIR ALL EXISTING WALL SURFACE DAMAGED DURING CONSTRUCTION SUCH THAT THEY MATCH AND BLEND IN WITH ADJACENT SURFACE.
- SEAL PENETRATION THROUGH FIRE RATED AREAS WITH U.L. LISTED AND FIRE CODE APPROVED MATERIALS. KEEP CONTRACT AREA CLEAN, HAZARD FREE, AND DISPOSE OF ALL DIRT, DEBRIS, AND RUBBISH. EQUIPMENT NOT SPECIFIED AS REMAINING ON THE PROPERTY OF THE OWNER SHALL BE REMOVED. LEAVE PREMISES IN CLEAN CONDITIONS AND FREE FROM PAINT SPOT, DUST, OR SMUDGES OF ANY NATURE. CONTRACTOR SHALL BE RESPONSIBLE FOR MAINTAINING ALL ITEMS UNTIL COMPLETION OF CONSTRUCTION
- MINIMUM BEND RADIUS OF ANTENNA CABLE SHALL BE IN ACCORDANCE WITH CABLE MANUFACTURER'S RECOMMENDATIONS.
- 20. DAMAGE TO EXISTING STRUCTURES AND/OR UTILITIES RESULTING FROM CONTRACTORS NEGLIGENCE SHALL BE REPAIRED AND/OR REPLACED TO THE OWNERS SATISFACTION AT NO ADDITIONAL COST TO THE CONTRACT
- 21 ALL CONSTRUCTION IS TO ADHERE TO T-MOBILE'S INTEGRATED CONSTRUCTION STANDARDS UNLESS 2015 IBC IS MORE STRINGENT
- THE INTENT OF THE PLANS AND SPECIFICATIONS IS TO PERFORM THE CONSTRUCTION IN ACCORDANCE WITH 22. THE 2015 IBC, WAC 51-11, WAC 51-11C, WAC 51-11R. SHOULD ANY CONDITIONS DEVELOP NOT COVERED BY THE APPROVED PLANS AND SPECIFICATIONS WHEREIN THE FINISH WORK WILL NOT COMPLY WITH WAC 51-11 2015 IBC OF REGULATIONS A CHANGE ORDER DETAILING AND SPECIFYING THE REGULERED WORK SHALL BE SUBMITTED TO AND APPROVED BY THE JURISDICTION BEFORE PROCEEDING WITH THE WORK.

SITE WORK NOTES:

- DO NOT SCALE BUILDING DIMENSIONS FROM DRAWINGS.
- SIZE, LOCATION, AND TYPE OF ANY UNDERGROUND UTILITIES OR IMPROVEMENTS SHALL BE ACCURATELY NOTED AND PLACED ON AS-BUILT DRAWINGS BY GENERAL CONTRACTOR AND ISSUED TO ARCHITECT OR ENGINEER OF RECORD AT COMPLETION OF PROJECT
- ALL EXISTING UTILITIES, FACILITIES, CONDITIONS AND THEIR DIMENSIONS SHOWN ON PLANS HAVE BEEN PLOTTED FROM AVAILABLE RECORDS. THE ARCHITECT OR ENGINEER OF RECORD AND OWNER ASSUME NO

RESPONSIBILITY WHATSOEVER AS TO THE SUFFICIENCY OR ACCURACY OF THE INFORMATION SHOWN ON THE PLANS OR THE MANNER OF THEIR REMOVAL OR ADJUSTMENT. CONTRACTOR SHALL BE RESPONSIBLE FOR DETERMINING EXACT LOCATION OF ALL EXISTING UTILITIES AND FACILITIES PRIOR TO START OF CONSTRUCTION, CONTRACTOR SHALL ALSO OBTAIN FROM FACH UTILITY COMPANY DETAILED INFORMATION. RELATIVE TO WORK SCHEDULES AND METHODS OF REMOVING OR ADJUSTING EXISTING UTILITIES.

- CONTRACTOR SHALL VERIFY ALL EXISTING UTILITIES BOTH HORIZONTAL AND VERTICALLY PRIOR TO START OF CONSTRUCTION. ANY DISCREPANCIES OR DOUBTS AS TO THE INTERPRETATION OF PLANS SHALL BE IMMEDIATELY REPORTED TO THE ARCHITECT OR ENGINEER OF RECORD FOR RESOLUTION AND INSTRUCTION, AND NO FURTHER WORK SHALL BE PERFORMED UNTIL THE DISCREPANCY IS CHECKED AND CORRECTED BY THE ARCHITECT OR ENGINEER OF RECORD. FAILURE TO SECURE SUCH INSTRUCTION MEANS CONTRACTOR WILL HAVE WORKED AT HIS/HER OWN RISK AND EXPENSE. CONTRACTOR SHALL CALL LOCAL DIGGER HOT LINE FOR UTILITY LOCATIONS 48 HOURS PRIOR TO START OF CONSTRUCTION.
- CONTRACTOR SHALL CLEAN ENTIRE SITE AFTER CONSTRUCTION SUCH THAT NO PAPER. TRASH, WEEDS, BRUSH OR ANY OTHER DEPOSITS WILL REMAIN. ALL MATERIALS COLLECTED DURING CLEANING OPERATIONS SHALL BE DISPOSED OF OFF-SITE BY THE GENERAL CONTRACTOR.
- ALL SITE WORK SHALL BE CAREFULLY COORDINATED BY THE GENERAL CONTRACTOR WITH LOCAL UTILITY COMPANY, TELEPHONE COMPANY, AND ANY OTHER UTILITY COMPANIES HAVING JURISDICTION OVER THIS LOCATION

PAINTING NOTES & SPECIFICATIONS:

- A. GENERA
- ALL PAINT PRODUCT LINES SHALL BE SHERWIN WILLIAMS UNLESS SPECIFICALLY NOTED OTHERWISE.
- CONTRACTOR SHALL PREPARE ALL SURFACES AND APPLY ALL FINISHES PER LATEST EDITION OF
- MANUFACTURER'S SPECIFICATIONS. COMPLY WITH MANUFACTURER'S WRITTEN INSTRUCTIONS REGARDING SUFFICIENT DRYING TIME BETWEEN
- COATS WITH PROVISIONS AS RECOMMENDED BY MANUFACTURER FOR EXISTING WEATHER CONDITIONS. FINISH COLOR AND TEXTURE OF ALL PAINTED SURFACES SHALL MATCH EXISTING ADJACENT SURFACES
- UNLESS OTHERWISE NOTED
- ALL PAINT MATERIAL DATA SHEETS SHALL BE PROVIDED TO THE T-MOBILE CONSTRUCTION MANAGER.
 - PREPARE PREVIOUSLY PAINTED SURFACE BY LIGHT SANDING WITH 400 GRIT SANDPAPER AND NON-HYDROCARBON WASH. PREPARE GALVANIZED SURFACES BY ACID ETCH OR SOLVENT CLEANING IN
- ACCORDANCE WITH SSPC-SP1 FURNISH DROP CLOTHES, SHIELDS, MASKING AND PROTECTIVE METHODS TO PREVENT SPRAY OR DROPPINGS
 - FROM DAMAGING ADJACENT SURFACES AND FACILITIES. APPLY PAINT BY AIRLESS SPRAY, SANDING LIGHTLY BETWEEN EACH SUCCEEDING ENAMEL COAT ON FLAT
 - SURFACES APPLY MATERIAL TO ACHIEVE A COATING NO THINNER THAN THE DRY FILM THICKNESS INDICATED
- APPLY BLOCK FILTER TO CONCRETE BLOCK CONSTRUCTION AT A RATE TO ENSURE COMPLETE COVERAGE WITH PORES COMPLETELY FILLED.
- CONTRACTOR SHALL CORRECT RUNS, SAGS, MISSES AND OTHER DEFECTS INCLUDING INADEQUATE COVERAGE AS DIRECTED BY THE T-MOBILE CONSTRUCTION MANAGER. REPAINT AS NECESSARY TO ACHIEVE SURFACES WHICH ARE SMOOTH, EVENLY COATED WITH UNIFORM SHEEN AND FREE FROM BLEMISHES.
 - COATING SYSTEM SPECIFICATIONS 1. DTM ACRYLIC COATING (SERIES B66) BY SHERWIN WILLIAMS CO. 1MIL DFT PER COAT APPLIED IN TWO
 - COATS OVER DTM BONDING PRIMER (B66A50) 2. 100% ACRYLIC, LATEX COATING EQUIVALENT TO A-100 (SERIES A-82) BY SHERWIN WILLIAMS CO. 1 DFT PER COAT APPLIED IN TWO COATS OVER SPECIFIED PRIMER
 - PAINT & PRIMER
- C. ANTENNAS
 - PRIMER KEM AQUA E61-W525
 - TOPCOAT COROTHANE II B65W200/B60V22

BTS CABINET

- PRIMER KEM AQUA E61-W525
- TOPCOAT COROTHANE II B65W200/B60V22
- COAXIAL JUMPER CABLES

PRIMER - AS REQUIRED FOR ADHESION. APPLY ONE COAT OF KEM AQUA WATER REDUCIBLE PRIMER E61W25 REDUCED 25%

TOPCOAT - 2 COATS COROTHANE II POLYURETHANE B65W200/B60V2

RAW STEEL

PRIMER - KEM BOND HS B50WZ4, DMT ACRYLIC PRIMER TOPCOAT - 2 COATS COROTHANE II POLYURETHANE B65W200/B60V2

GALVANIZED METAL

ACID ETCH WITH COMMERCIAL ETCH OR VINEGAR PRIMER COAT AND FINISH COAT (GALVITE HIGH SOLIDS OR DTM PRIMER/FINISH)

STAINLESS STEEL

PRIMER - OTM WASH PRIMER, B71Y1 TOPCOATS - 2 COATS COROTHANE II POLYURETHANE B65W200/B60V2

PRE-PRIMED STEEL

TOUCH UP ANY RUST OR UN-PRIMED STEEL WITH KEM BOND HS, SS0WZ4

ALUMINUM & COPPER

PRIMER - DTM WASH PRIMER, B71Y1 TOPCOAT - 2 COATS COROTHANE II POLYURETHANE B65W200/B60V2

CONCRETE MASONRY

PRIMER - PRO MAR EXTERIOR BLOCK FILLER TOPCOAT - 2 COATS A-100 LATEX HOUSE & TRIM, SHEEN TO MATCH

CONCRETE STUCCO (EXISTING) 2 COATS A-100 LATEX HOUSE & TRIM, SHEEN TO MATCH

STUCCO

PRIMER - PRO MAR MASONRY CONDITIONED B-46 W21000

TOPCOAT - SUPERPAINT A-80 SERIES A-89 SATIN A-84 GLOSS

WOOD

PRIMER - A-100 EXTERIOR ALKYD W009D PRIMER Y-24W20 TOPCOAT - 2 COATS A-100 LATEX HOUSE & TRIM SHEEN TO MATCH ADJACENT SURFACES

FIELD CUTS/ DAMAGE (PRIOR TO PRIME & PAINT)

FIRST & SECOND COAT - CUPRINOL CLEAR WOOD PRESERVATIVE #158-0356 ALL PENETRATIONS INTO

FINISHED GLU-LAMS SHALL BE CAULKED WITH "SIKAFLEX" SEALANT STEEL TOUCH UP

STEEL THAT HAS BEEN WELDED, CUT OR SCRATCHED IN THE FIELD SHALL BE TOUCHED UP WITH COLD

GALVANIZED PAINT.

BATTERY NOTES:

ROOM.

REGULATIONS

IS ADDRESSED ON

KNOWLEDGE OR EFFORT

HAVING JURISDICTION

SHOWN HEREIN (SEE SIGNAGE)

EQUAL OR GREATER FIRE RATING.

GROUNDING NOTES:

- COMPRESSION CONNECTIONS (2), 2 AWG BARE TINNED SOLID COPPER CONDUCTORS TO GROUNDING BAR. ROUTE CONDUCTORS TO BURIED GROUNDING RING AND PROVIDE PARALLEL EXOTHERMIC WELD EC SHALL USE PERMANENT MARKER TO DRAW THE LINES BETWEEN EACH SECTION AND LABEL EACH SECTION
- ("P", "A", "N", "I") WITH 1" HIGH LETTERS. ALL HARDWARE 18-8 STAINLESS STEEL, INCLUDING LOCK WASHERS, COAT ALL SURFACES WITH AN ANTI-OXIDANT COMPOUND BEFORE MATING. ALL HARDWARE SHALL BE STAINLESS STEEL 3/8 INCH DIAMETER OR LARGER
- FOR GROUND BOND TO STEEL ONLY: INSERT A CADMIUM FLAT WASHER BETWEEN LUG AND STEEL, COAT ALL SURFACES WITH AN ANTI-OXIDANT COMPOUND BEFORE MATING. 5
- SIDE
- 6 CONNECTION ORIENTATION. PROVIDE AS REQUIRED.
- WHEN THE SCOPE OF WORK REQUIRES THE ADDITION OF A GROUNDING BAR TO AN EXISTING TOWER, THE SUBCONTRACTOR SHALL OBTAIN APPROVAL FROM THE TOWER OWNER PRIOR TO MOUNTING THE GROUNDING BAR TO THE TOWER
- 8. (NEC), NATIONAL FIRE PROTECTION ASSOCIATION (NEPA) 780 (LATEST EDITION).

AS INDICATED IN SECTION 608.1

FIRE DEPARTMENT NOTES:

REQUIRED FOR THE QUANTITIES ON SITE

NUT & WASHER SHALL BE PLACED ON THE FRONT SIDE OF THE GROUNDING BAR AND BOLTED ON THE BACK

NUMBER OF GROUNDING BARS MAY VARY DEPENDING ON THE TYPE OF TOWER, ANTENNA LOCATION, AND

ALL ELECTRICAL AND GROUNDING AT THE CELL SITE SHALL COMPLY WITH THE NATIONAL ELECTRICAL CODE

A. ANY CHANGES OR ADDITIONS TO BACK-UP BATTERIES SHALL NOT CONTAIN ELECTROLYTE QUANTITIES IN EXCESS OF 50 GALLONS AND NEED NOT COMPLY WITH THE REQUIREMENTS OF 2015 IFC SECTION 608

FIRE DEPARTMENT FINAL INSPECTION REQUIRED. SCHEDULE INSPECTION 2 DAYS IN ADVANCE. A CFC PERMIT TO OPERATE BATTERY SYSTEMS WITH STATIONARY LEAD-ACID BATTERIES IS NOT

A CFC PERMIT MAY BE REQUIRED FOR THE HAZARDOUS MATERIALS ON SITE. A HAZARDOUS MATERIALS IDENTIFICATION SIGN IS REQUIRED FOR ALL ENTRANCES INTO BATTERY STORAGE AREAS. LETTERS MUST BE AT LEAST 1" IN HEIGHT AND IN A COLOR WHICH CONTRASTS TO THE BACKGROUND OF THE SIGN AND LIST THE FOLLOWING: "CLASS 1 WATER REACTIVE LIQUID TOXIC LIQUID CORROSIVE LIQUID OTHER HEALTH HAZARD LIQUID"

AN APPROVED METHOD TO NEUTRALIZE SPILLED ELECTROLYTE SHALL BE PROVIDED IN THE BATTERY

BATTERIES SHALL BE PROVIDED WITH SAFETY VENTING CAPS.

LOCATIONS AND CLASSIFICATIONS OF EXTINGUISHERS SHALL BE IN ACCORDANCE WITH THE UNIFORM FIRE CODE STANDARD 10-1 AND PLACEMENT IS SUBJECT TO APPROVAL OF THE FIRE INSPECTOR. STORAGE, DISPENSING OR USE OF ANY FLAMMABLE AND COMBUSTIBLE LIQUIDS, FLAMMABLE AND COMPRESSED GASES, AND OTHER HAZARDOUS MATERIALS SHALL COMPLY WITH UNIFORM FIRE CODE

EXIST DOORS SHALL BE ABLE TO OPEN FROM THE INSIDE WITHOUT THE USE OF KEY OR ANY SPECIAL

ADDRESS NUMBERS SHALL BE A MINIMUM 6 INCHES HIGH AND PLAINLY VISIBLE FROM ROADWAY BUILDING

REQUIRED SIGNAGE SHALL INCLUDE LETTERING HEIGHT OF AT LEAST ONE INCH, IN A COLOR THAT CONTRASTS TO THE SIGN BACKGROUND, AND SHALL BE PROMINENTLY DISPLAYED REQUIRED SIGNAGE SHALL INCLUDE, BUT MAY NOT BE LIMITED TO, APPLICABLE TYPES FROM EXAMPLES

M. ALL PENETRATIONS THROUGH FIRE RATED ASSEMBLIES SHALL BE CONSTRUCTED SO AS TO MAINTAIN AN

DECORATIVE MATERIALS SHALL BE MAINTAINED IN A FLAME-RETARDANT CONDITION. [IFC 807.3] CONTRACTOR SHALL VERIFY IN FIELD THE EXISTENCE OR INSTALLATION OF A FIRE EXTINGUISHER WITH A MINIMUM RATING OF 2A-10BC, WITH A CHARGE STATUS ACCEPTABLE TO THE LOCAL FIRE AUTHORITY

ERTICAL BRIDGE HOLDINGS, LLC 750 PARK OF COMMERCE DRIVE. SUITE 200 BOCA RATON EL 33487

verticalbridge

T··Mobile 10509 VISTA SORRENTO PKWY #206 SAN DIEGO, CA 92121 T-MOBILE.COM



REVISIONS				
REV.	DATE	DESCRIPTION	INITIALS	
0	02/01/19	PZD	SR	
1	02/19/19	FZD	SR	
2	05/31/19	NEW RFDS	SR	

HEREBY CERTIEV THAT THESE PLANS WERE PREPARED BY ME AND LINDER MY DIRECT SUPERVISION AND THAT I AM DULY REGISTERED ARCHITECT UNDER THE LAWS OF THE STATE OF

DATE


CLE ELUM DT US-WA-5105 NEAR E 5TH STREET & N PENNSYI VANIA AVENUE CLE ELUM, WA 98922

SHEET TITLE


GENERAL NOTES


SHEET NUMBER

T-2.0

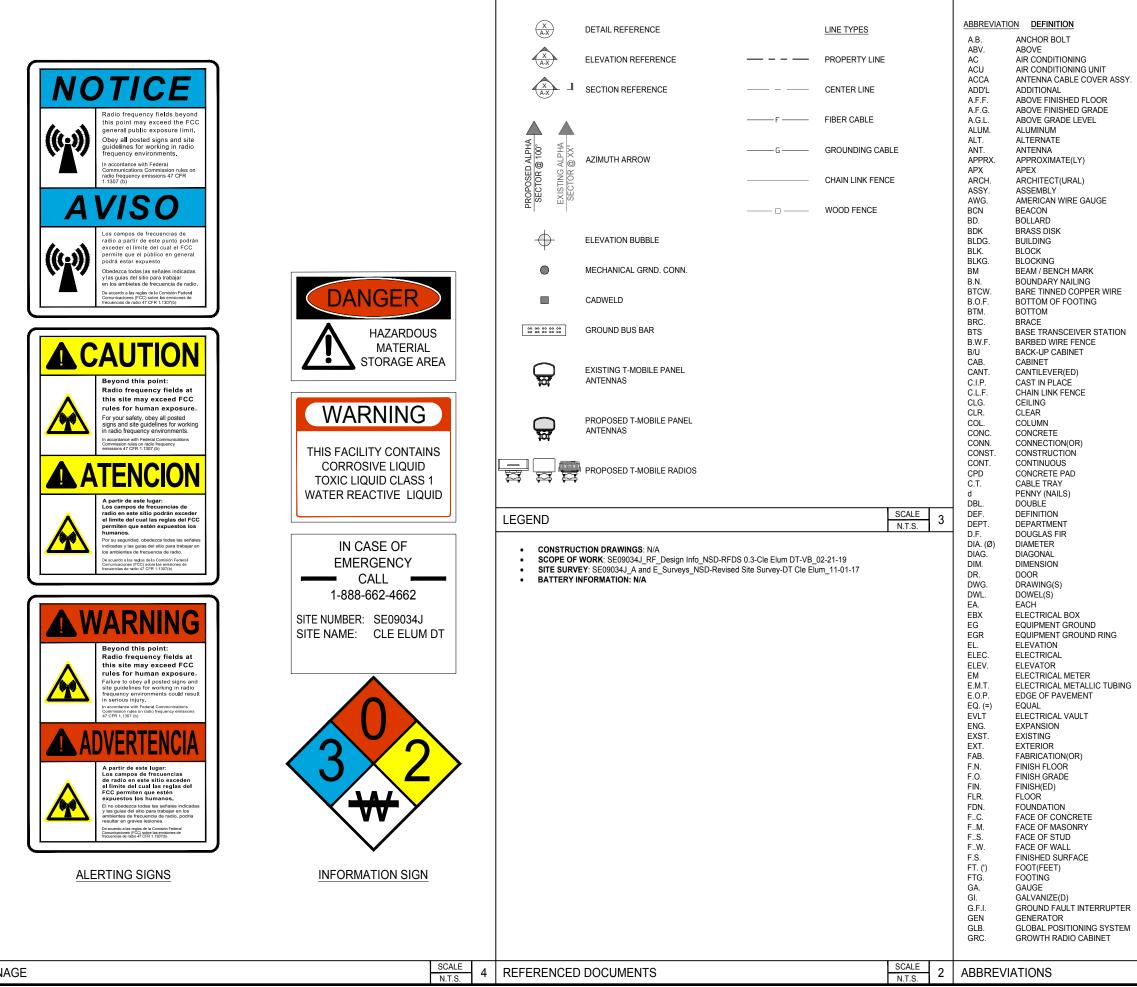

	GRND. HDR.	GROUND HEADER	ve	L L	calbrid	Y.
	HGR.	HEIGHT			CAL BRIDGE HOLDINGS, LLC	
Y.	ICGB. IGR	ISOLATED COPPER GROUND BUS INTERIOR GROUND RING		750 PA SUITE	RK OF COMMERCE DRIVE, 200	
1.	IN. (")	INCH(ES)	Ц	BOCA	RATON, FL 33487	
	INT.	INTERIOR				
	LB. (#) L.B.	POUND(S) LAG BOLTS				
	L.F.	LINEAR FEET (FOOT)	ll n		Mabile	
	L. MGB	LONG(ITUDINAL) MASTER GROUND BUS	II "		 Mobile 	
	MAS.	MASTER GROUND BUS			ISTA SORRENTO PKWY #206	
	MAX.	MAXIMUM			SAN DIEGO, CA 92121 T-MOBILE.COM	
	M.B. MECH.	MACHINE BOLT MECHANICAL				
	MFR.	MANUFACTURER				
	MIN.					
	MISC. MTL.	MISCELLANEOUS METAL		1	\sim	
	MW	MICROWAVE				
	(N) NO. (#)	NEW NUMBER		14		
	N.T.S.	NOT TO SCALE	5		I R E L E S S E DESIGN GROUP, INC.	
	0.C.	ON CENTER		5015 SH	IOREHAM PLACE, SUITE 150 SAN DIEGO, CA 92122	
	OH. OHP	OVERHEAD OVERHEAD POWER LINE			www.sacw.com	
	OPNG.	OPENING				
	P/C PLY.	PRECAST CONCRETE PLYWOOD			REVISIONS	
	PLT. PPC	POWER PROTECTION CABINET	REV. DA	ATE	DESCRIPTION	INITIAL
	P.S.F.	POUNDS PER SQUARE FOOT	0 02/0)1/19	PZD	SR
	P.S.I. P.T.	POUNDS PER SQUARE INCH PRESSURE TREATED	1 02/1	9/19	FZD	SR
	PWR.	POWER (CABINET)	2 05/3	31/19	NEW RFDS	SR
	QTY.	QUANTITY	2 03/3	51/19	NEW RFD3	
	R. RAD. CTR.	RADIUS RADIATION CENTER				
	RBS	RADIO BASE STATION				
	REF. REINF.	REFERENCE REINFORCEMENT(ING)				
	REQD.	REQUIRED				
	RF					
	RGS RRU	RIGID GALVANIZED STEEL REMOTE RADIO UNIT				
	RRH	REMOTE RADIO HEAD				
	SCH. SHT.	SCHEDULE SHEET	_			
	SIM.	SIMILAR	l í			
	SPEC.	SPECIFICATION(S)				
	SP SQ.	STEEL PLATE SQUARE				
	S.S.	STAINLESS STEEL				
	STD. STL.	STANDARD STEEL				
	STRUC.	STRUCTURAL				
	T.B.D.	TO BE DETERMINED				
	T.B.R. TEMP.	TO BE RESOLVED TEMPORARY				
	THK.	THICK(NESS)				
	TMA T.N.	TOWER MOUNTED AMPLIFIER TOE NAIL				
	T.O.A.	TOP OF ANTENNA			DAT	E:
G	T.O.C. T.O.F	TOP OF CURB TOP OF FOUNDATION			ERTIFY THAT THESE PLANS WER	E
9	T.O.P.	TOP OF PLATE (PARAPET)			BY ME AND UNDER MY DIRECT AND THAT I AM DULY REGISTER	ED
	T.O.S.	TOP OF STEEL	ARCH	ITECT U	NDER THE LAWS OF THE STATE WASHINGTON"	OF
	T.O.W. TWR.	TOP OF WALL TOWER				
	TYP.	TYPICAL	lí		CLE ELUM DT	
	U.G. U.L.	UNDER GROUND UTILITY POLE			US-WA-5105	
	U.N.O.	UNLESS NOTED OTHERWISE			R E 5TH STREET & N NSYLVANIA AVENUE	
	V.I.N. W.	VERIFY IN FIELD WIDE(WIDTH)		CL	E ELUM, WA 98922	
	WD.	WOOD				
	W.P. WT.	WEATHERPROOF			SHEET TITLE	
	VVI.	WEIGHT				
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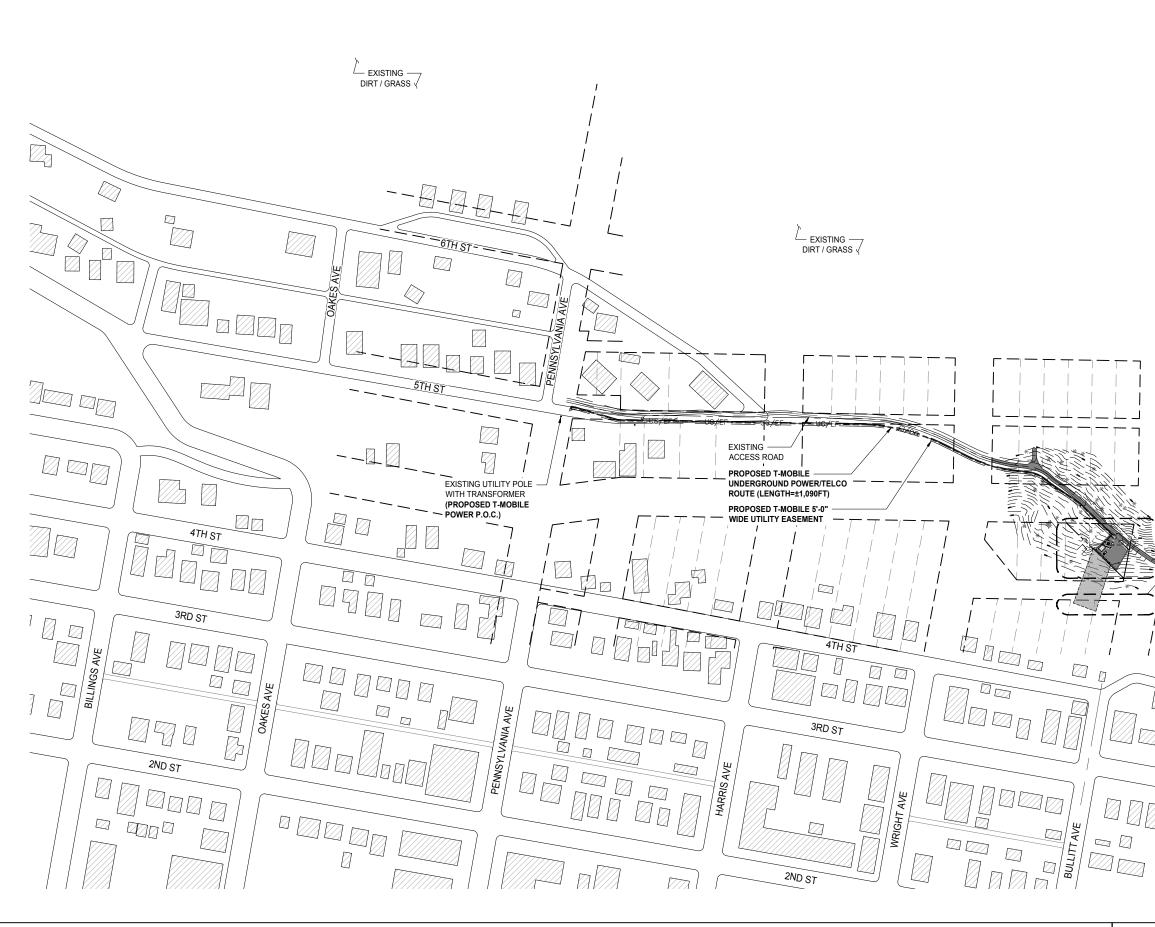
LATITUDE/LONGITUDE POSITION

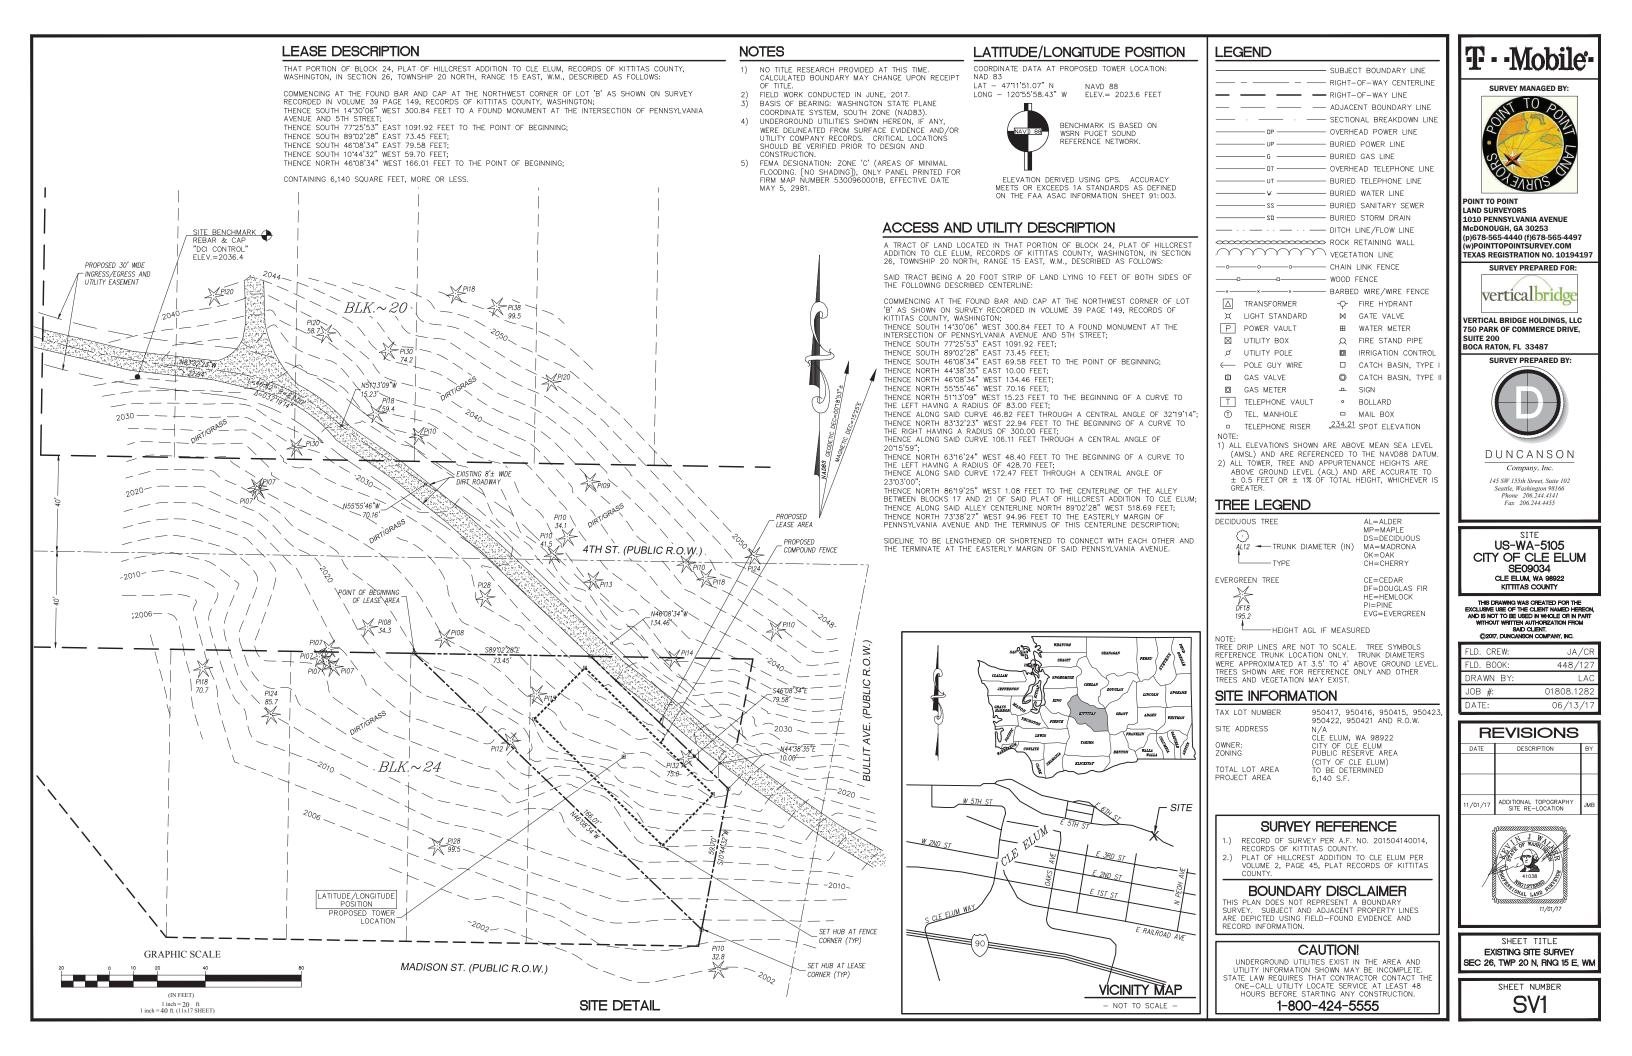ELEVATION DERIVED USING GPS. ACCURACY MEETS OR EXCEEDS 1A STANDARDS AS DEFINED ON THE FAA ASAC INFORMATION SHEET 91:003.

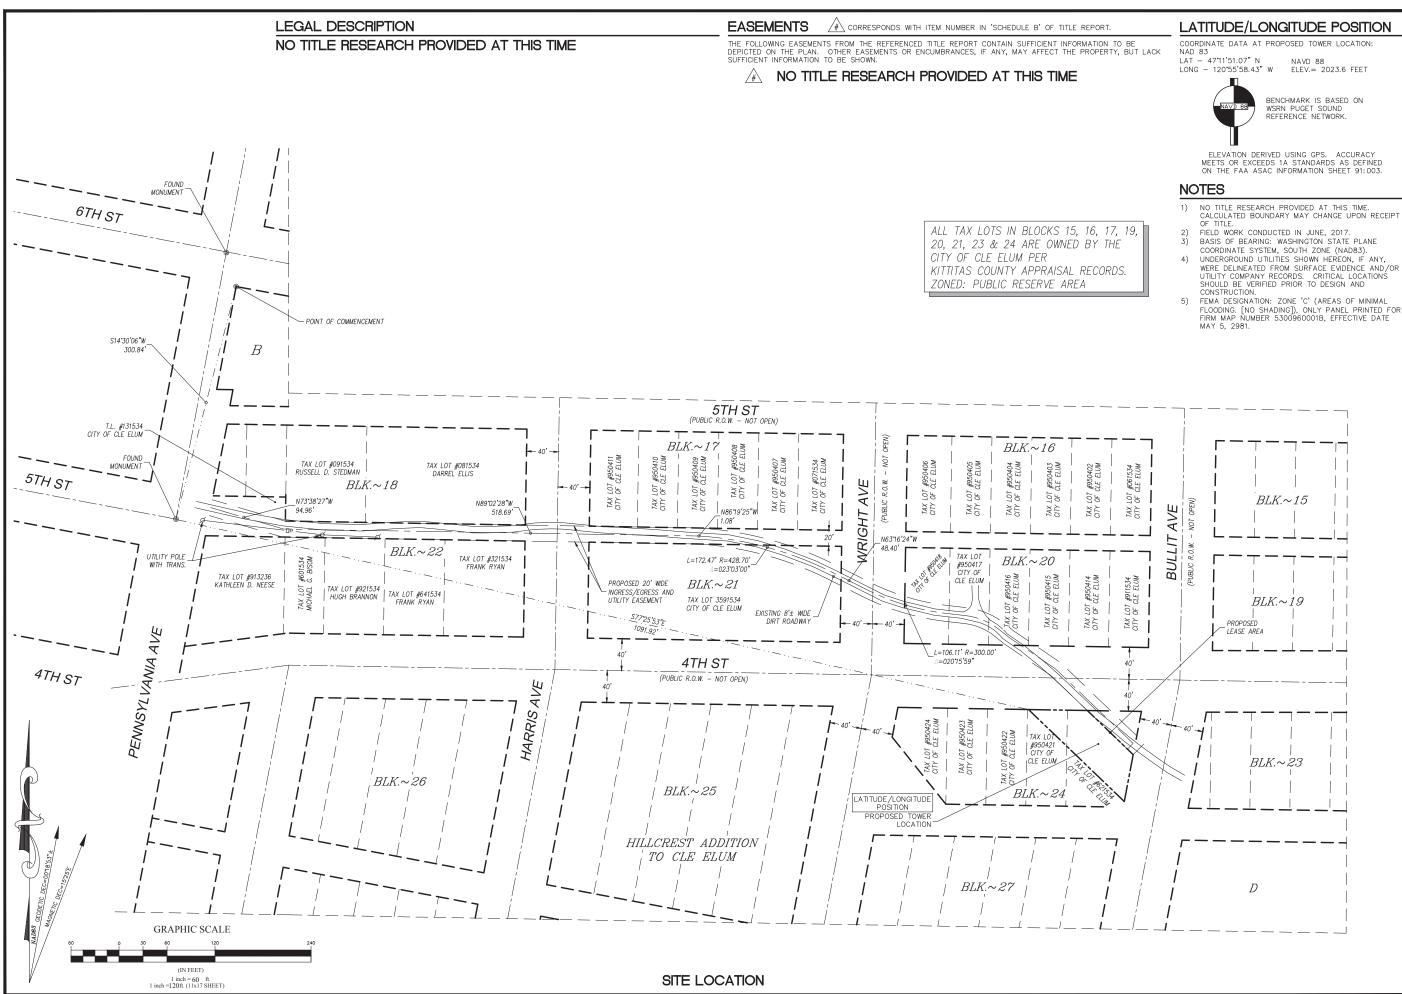
- NO TITLE RESEARCH PROVIDED AT THIS TIME. CALCULATED BOUNDARY MAY CHANGE UPON RECEIPT OF TITLE.


- FEMA DESIGNATION: ZONE 'C' (AREAS OF MINIMAL FLOODING. [NO SHADING]), ONLY PANEL PRINTED FOR FIRM MAP NUMBER 5300960001B, EFFECTIVE DATE






		VERT 750 P SUITI	ICAL BRIDGE HOLDINGS, LLC ARK OF COMMERCE DRIVE, E 200	ge
		- -	VISTA SORRENTO PKWY #206 SAN DIEGO, CA 92121	
Image: State of the state		SAC A	E DESIGN GROUP, INC. HOREHAM PLACE, SUITE 150 SAN DIEGO, CA 92122	
LAYOUT	1	02/19/19	FZD	SR
	2	05/31/19	NEW RFDS	SR
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US-WA-5105 NEAR E 5TH STREET & N PENNSYLVANIA AVENUE CLE ELUM, WA 98922 SHEET TITLE OVERALL SITE PLAN OVERALL SITE PLAN SHEET NUMBER A-1.0	Ĺ	SUPERVISIO	N AND THAT I AM DULY REGISTER UNDER THE LAWS OF THE STATE	ED OF
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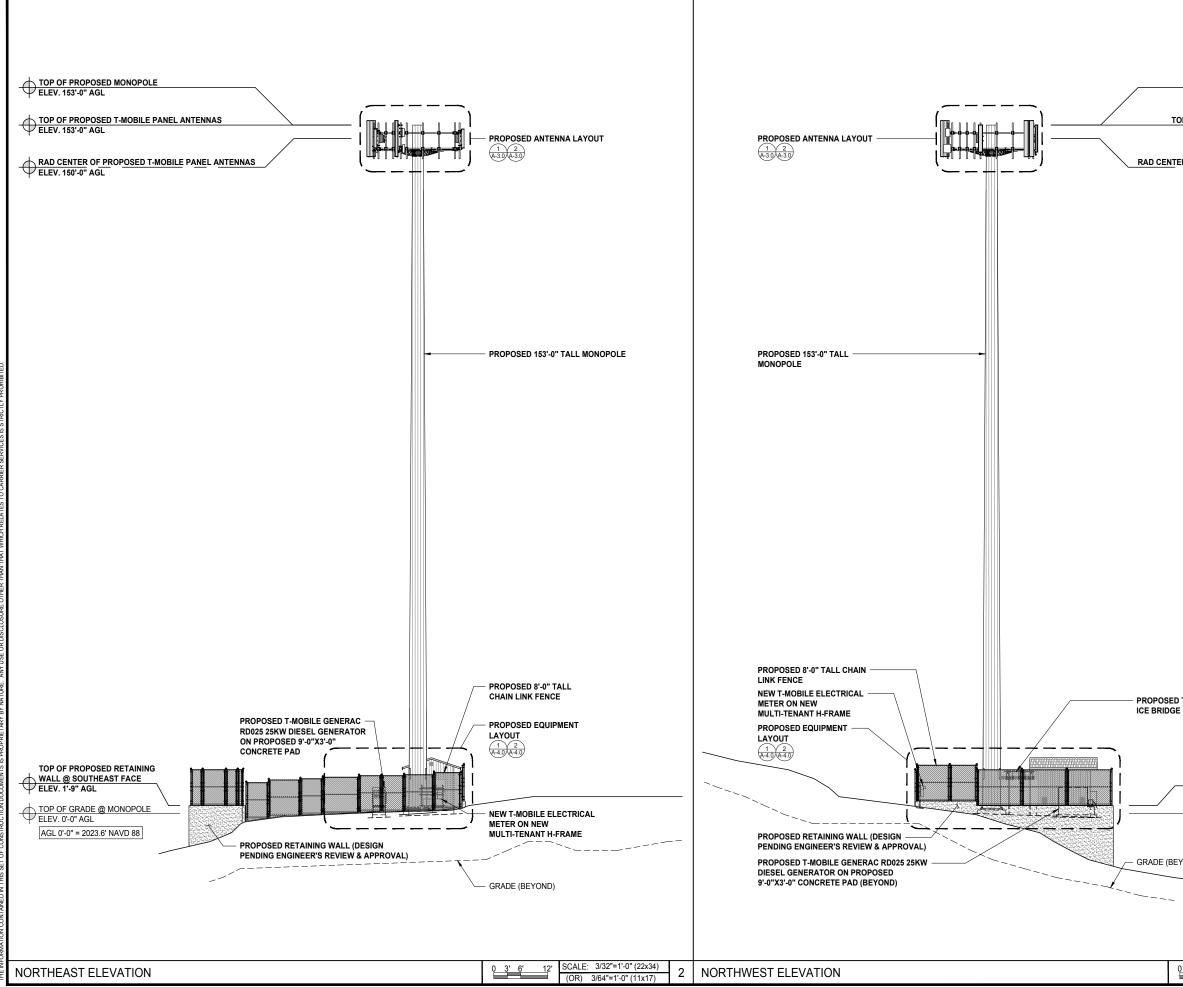


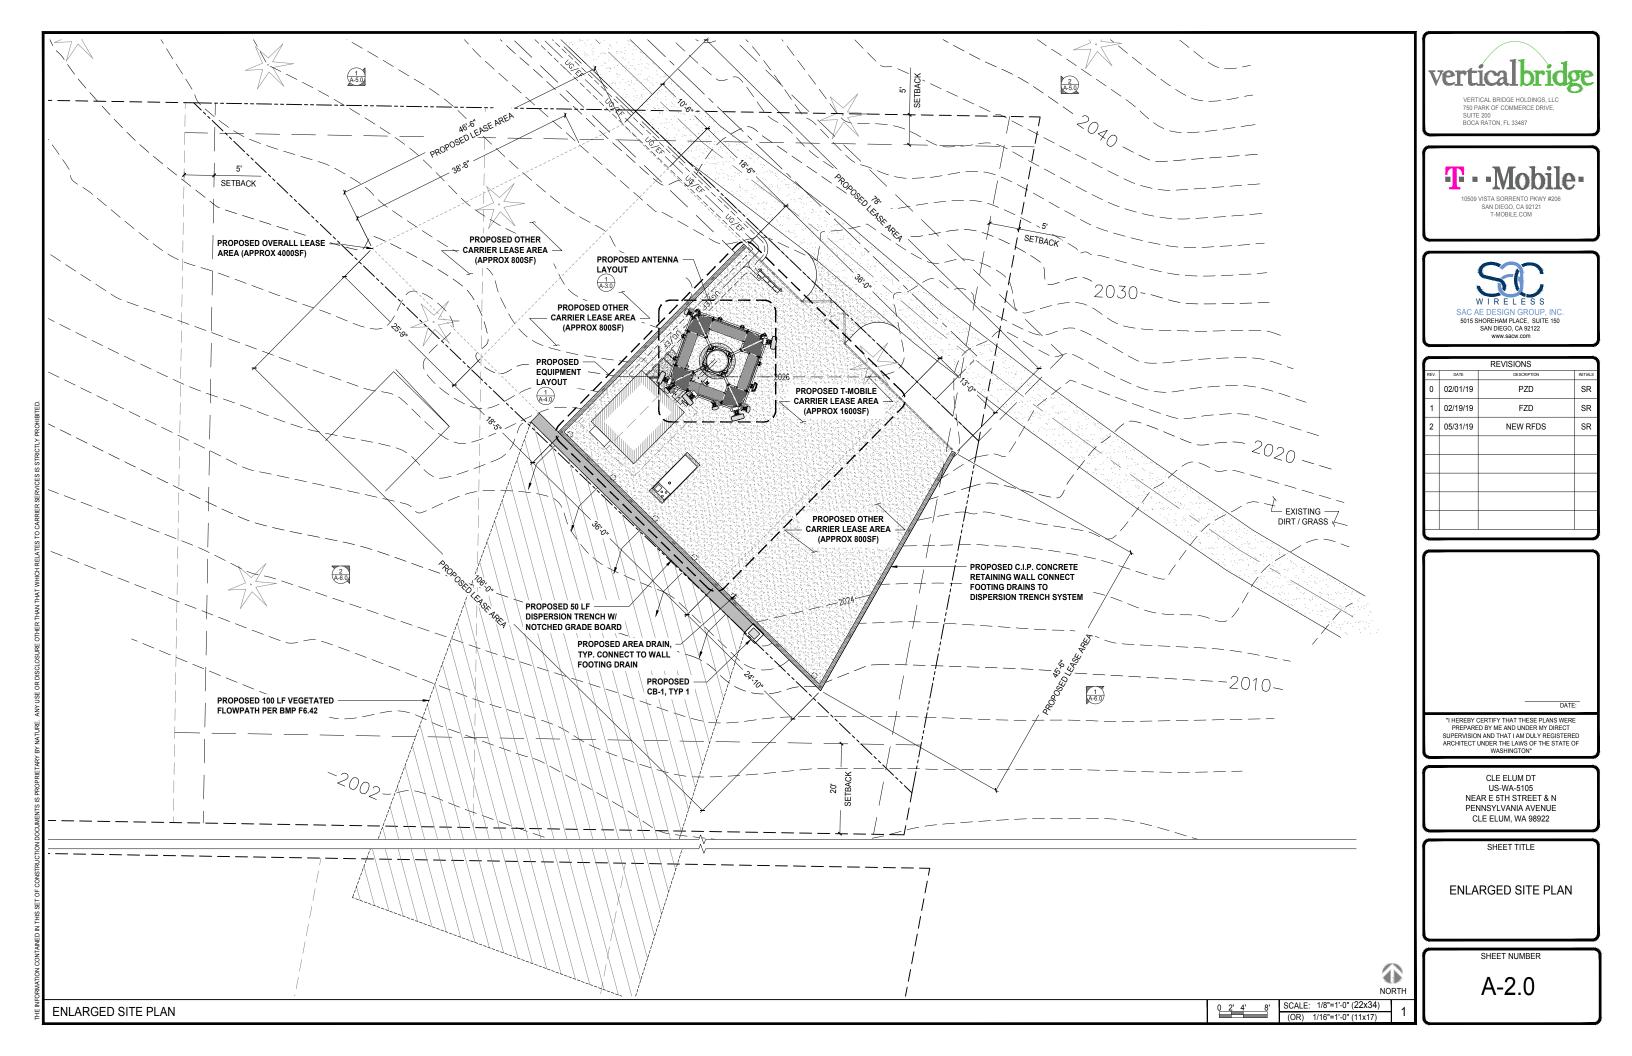

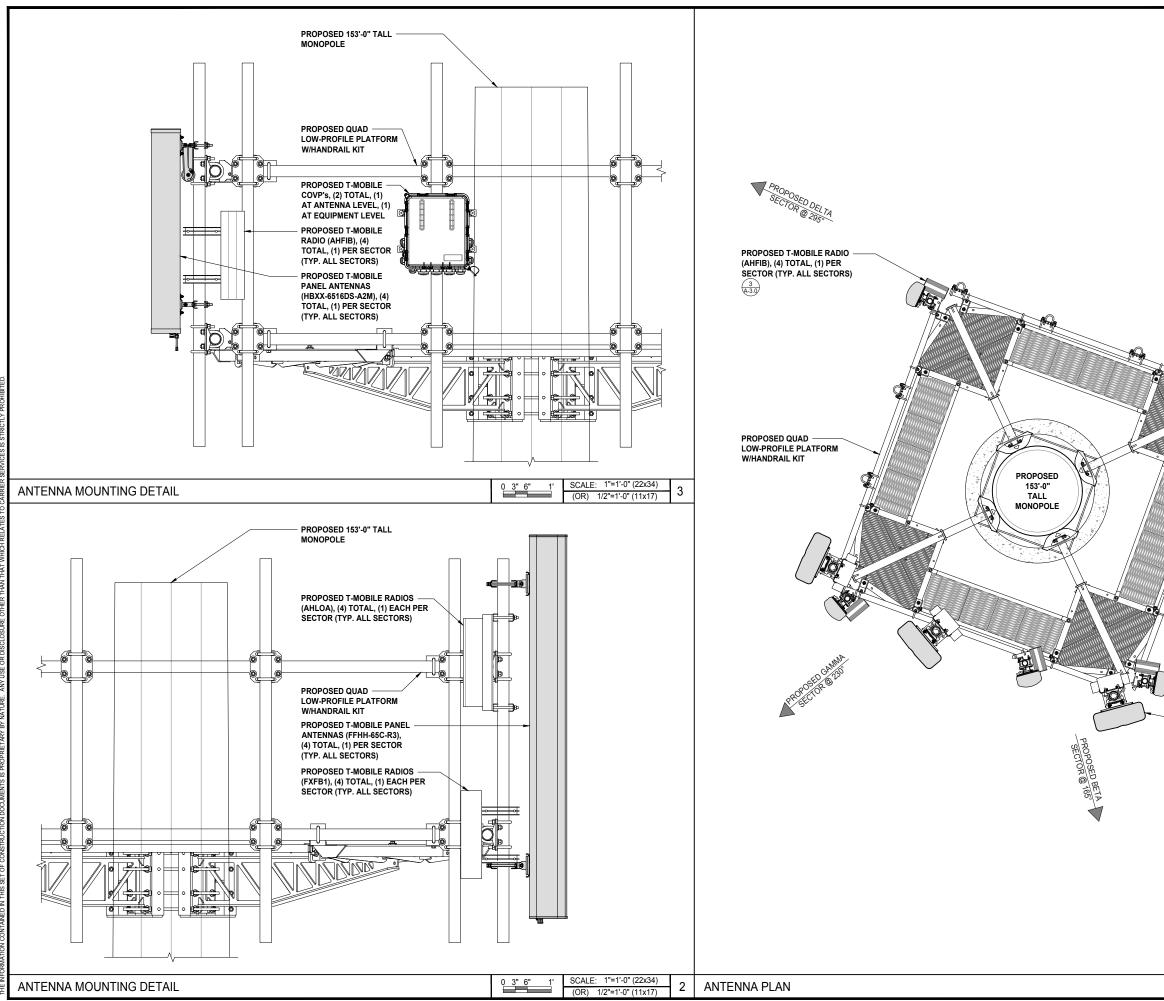			VERTI 750 PA SUITE BOCA	CAL BRIDGE HOLDINGS, LLC RK OF COMMERCE DRIVE, 200 RATON, FL 33487 • MODELEO, CA 92121 T-MOBILE COM	
	PROPOSED T-MOBILE RADIOS		SAC A	VI RELESS DESIGN GROUP. INC toReham PLACE. SUITE 150 SAN DIEGO, CA 92122 www.sacw.com	
~ /	(AHLOA), (4) TOTAL, (1) EACH PER SECTOR (TYP. ALL	REV.	DATE 02/01/19		INITIALS
	SECTORS) (ABOVE)	1	02/01/19	FZD	SR
	 PROPOSED T-MOBILE RADIOS (FXFB1), (4) TOTAL, (1) EACH PER SECTOR (TYP. ALL SECTORS) (BELOW) 2 ² ² ³ ³ PROPOSED ALPHA SECTOR @ 100° PROPOSED T-MOBILE COVP's, (2) TOTAL, (1) AT ANTENNA LEVEL, (1) AT EQUIPMENT LEVEL ³ ³ ³ PROPOSED T-MOBILE PANEL ANTENNAS (HBXX-6516DS-AZM), (4) TOTAL, (1) PER SECTOR (TYP. ALL SECTORS) PROPOSED T-MOBILE PANEL ANTENNAS (FFHH-65C-R3), (4) TOTAL, (1) PER SECTOR (TYP. ALL SECTORS) 		1 HEREBY C PREPAREI SUPERVISION ARCHITECT U	NEW RFDS	ATE:
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		Г		SHEET TITLE	
				ENNA PLAN ANI NTING DETAILS	
<u>0 6" 1' 2'</u>	NORTH SCALE: 1/2"=1'-0" (22x34)	ſ		SHEET NUMBER	
	(OR) 1/4"=1'-0" (11x17) 1				

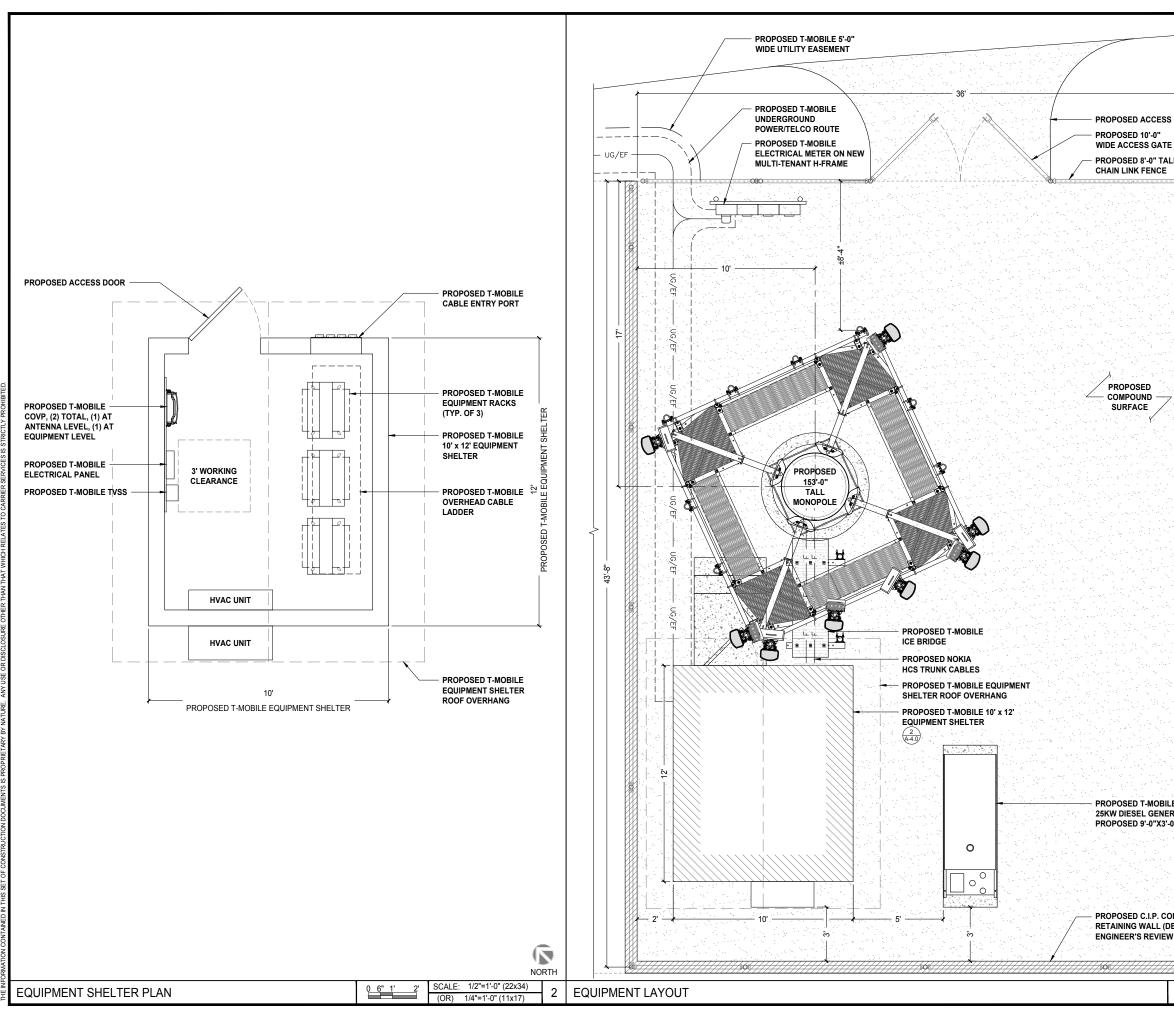

	Vertical Bridge Holdings, LLC 750 PARK OF COMMERCE DRIVE, SUITE 200 BOCA RATON, FL 33487
SS DRIVE TE FALL E 	T Mobile-
	SAN DIEGO, CA 92121 T-MOBILE.COM
	WIRELESS SACAE DESIGN GROUP, INC. 5015 SHORHAM PLACE, SUITE 150 SAN DIEGO, CA 92122 www.sacw.com
28년 전 19년 1월 20년 1월 1월 21년 1월 21년	DEVICIONO
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7	
	2 05/31/19 NEW RFDS SR
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	SUPERVISION AND THAT I AM DULY REGISTERED ARCHITECT UNDER THE LAWS OF THE STATE OF
지 않는 것 같은 것 같아.	WASHINGTON"
	CLE ELUM DT
	US-WA-5105
	NEAR E 5TH STREET & N PENNSYLVANIA AVENUE
BILE GENERAC RD025	CLE ELUM, WA 98922
NERATOR ON	
(3'-0" CONCRETE PAD	SHEET TITLE
	EQUIPMENT LAYOUT &
	EQUIPMENT SHELTER
	PLAN
CONCRETE	11
CONCRETE (DESIGN PENDING	
IEW & APPROVAL)	SHEET NUMBER
<u>ale de la contracta de la C</u> ala de la Cala	
NORTH	A-4.0
0 41 01 01 SCALE: 3/8"=1'-0" (22x34)	
(OR) 3/16"=1'-0" (11x17)	1



vertical	bridge

VERTICAL BRIDGE HOLDINGS, LLC 750 PARK OF COMMERCE DRIVE. SUITE 200 BOCA RATON, FL 33487





		REVISIONS	
REV.	DATE	DESCRIPTION	INITIALS
0	02/01/19	PZD	SR
1	02/19/19	FZD	SR
2	05/31/19	NEW RFDS	SR

DATE:

"I HEREBY CERTIFY THAT THESE PLANS WERE PREPARED BY ME AND UNDER MY DIRECT SUPERVISION AND THAT I AM DULY REGISTERED ARCHITECT UNDER THE LAWS OF THE STATE OF WASHINGTON"

CLE ELUM DT US-WA-5105 NEAR E 5TH STREET & N PENNSYLVANIA AVENUE CLE ELUM, WA 98922

SHEET TITLE

NORTHWEST & NORTHEAST ELEVATIONS

SHEET NUMBER

A-5.0

TOP OF PROPOSED MONOPOLE ELEV. 153'-0" AGL

TOP OF PROPOSED T-MOBILE PANEL ANTENNAS ELEV. 153'-0" AGL

RAD CENTER OF PROPOSED T-MOBILE PANEL ANTENNAS ELEV. 150'-0" AGL


PROPOSED T-MOBILE

TOP OF PROPOSED RETAINING WALL @ SOUTHWEST FACE ELEV. 1'-9" AGL

TOP OF GRADE @ MONOPOLE ELEV. 0'-0" AGL AGL 0'-0" = 2023.6' NAVD 88

GRADE (BEYOND)

SCALE: 3/32"=1'-0" (22x34) (OR) 3/64"=1'-0" (11x17) 12' 0 3' 6'

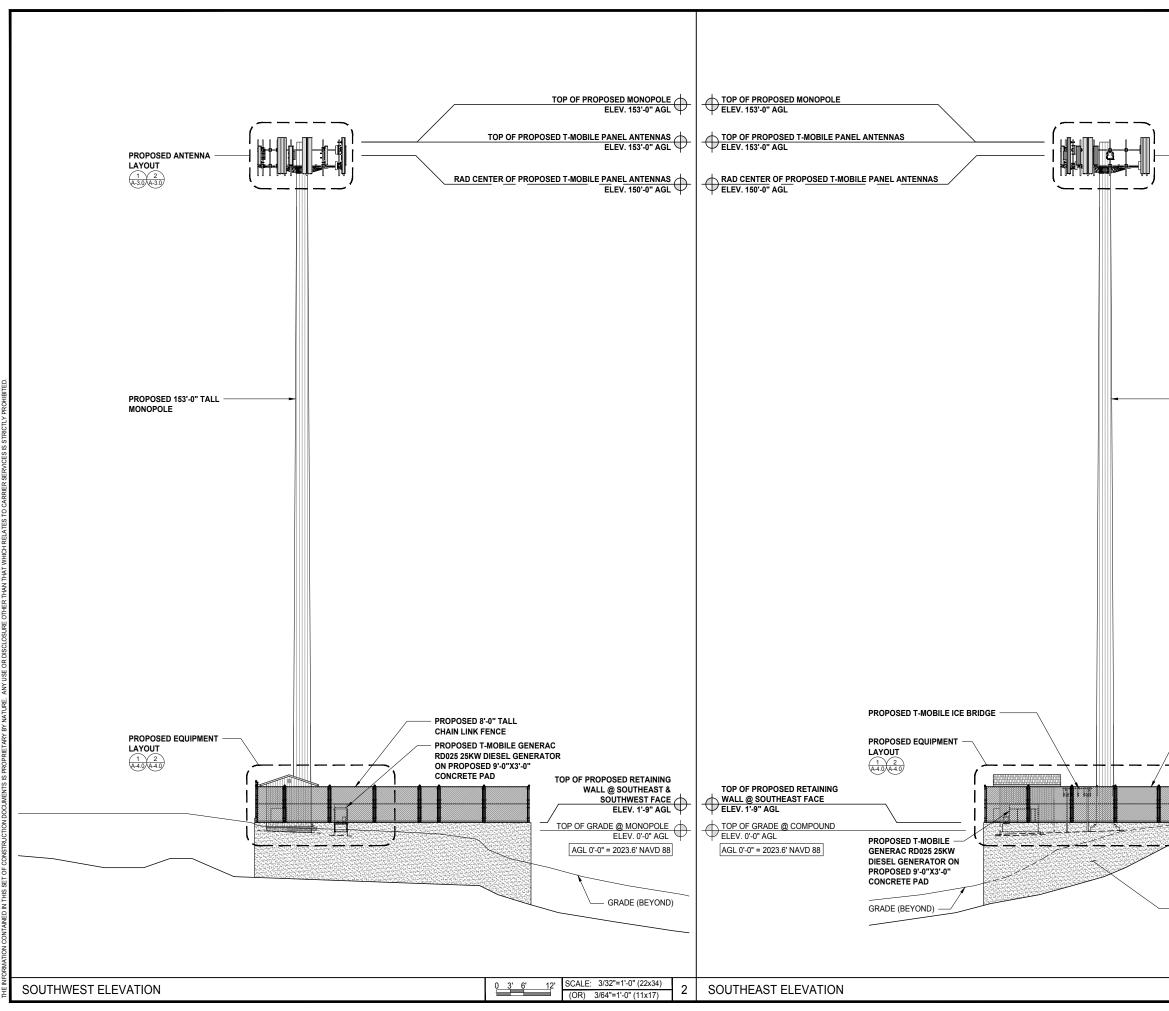

10509 VISTA SORRENTO PKWY #206 SAN DIEGO, CA 92121 T-MOBILE.COM Image: Comparison of the system			
REVISIONS REV. DATE DESCRIPTION 0 02/10/19 PZD 1 02/19/19 FZD			
PROPOSED 153"-0" TALL MONOPOLE	SAC AE DESIGN GROUP, INC. 5015 SHOREHAM PLACE, SUITE 150 SAN DIEGO, CA 92122		
REV DATE DESCRIPTION 0 02/01/19 PZD 1 02/19/19 FZD			
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NEW T-MOBILE ELECTRICAL US-WA-5105 METER ON NEW US-WA-5105 MULTI-TENANT H-FRAME PENNSYLVANIA AVENUE CLE ELUM, WA 98922	US-WA-5105 NEAR E 5TH STREET & N PENNSYLVANIA AVENUE		
SHEET TITLE			
ELEVATIONS	SOUTHEAST & SOUTHWEST ELEVATIONS		
(DESIGN PENDING ENGINEER'S REVIEW & APPROVAL) SHEET NUMBER			
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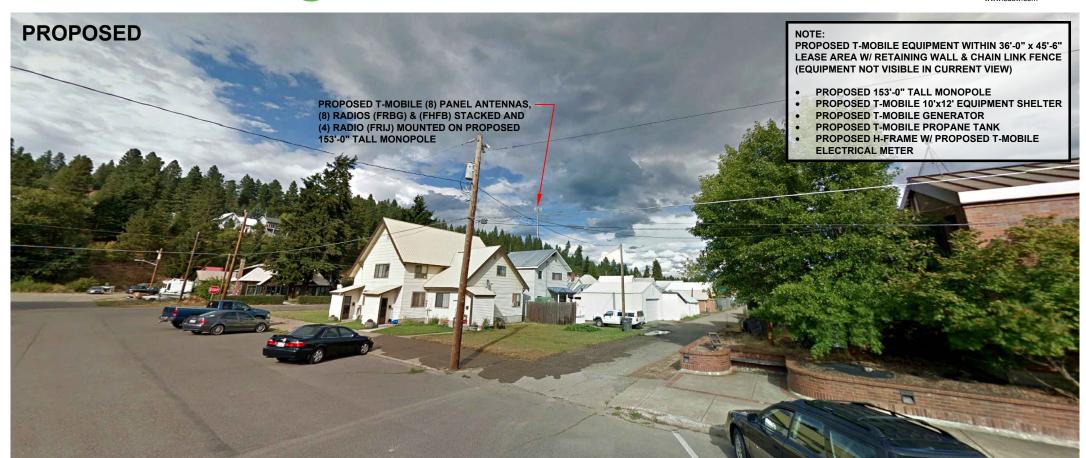
verticalbridge

US-WA-5105 SE09034J CLE ELUM DT NEAR E 5TH STREET & PENNSYLVANIA AVENUE CLE ELUM, WA 98922 CITY OF CLE ELUM

PHOTOSIMULATION VIEWPOINT 1









DISCLAIMER: THIS PHOTOSIMULATION IS INTENDED AS A GRAPHICAL REPRESENTATION OF EXISTING AND PROPOSED SITE CONDITIONS BASED ON THE PROJECT / DRAWING PLANS. IT IS NOT INTENDED FOR CONSTRUCTION. ACTUAL, FINAL CONSTRUCTION MAY VARY




verticalbridge

US-WA-5105 SE09034J CLE ELUM DT NEAR E 5TH STREET & PENNSYLVANIA AVENUE CLE ELUM, WA 98922 CITY OF CLE ELUM

PHOTOSIMULATION VIEWPOINT 2



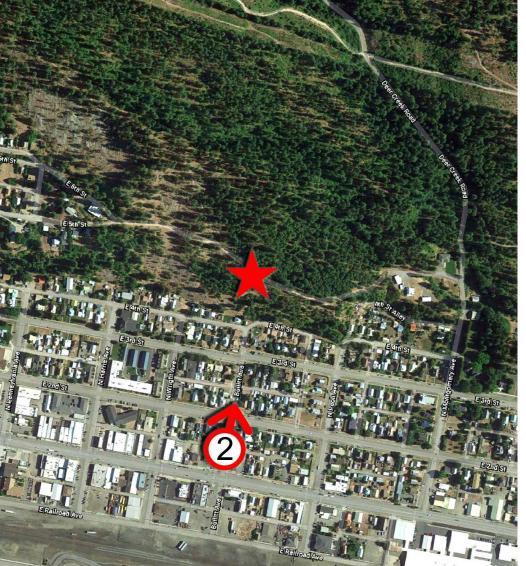



DISCLAIMER: THIS PHOTOSIMULATION IS INTENDED AS A GRAPHICAL REPRESENTATION OF EXISTING AND PROPOSED SITE CONDITIONS BASED ON THE PROJECT / DRAWING PLANS. IT IS NOT INTENDED FOR CONSTRUCTION. ACTUAL, FINAL CONSTRUCTION MAY VARY







verticalbridge

US-WA-5105 SE09034J CLE ELUM DT NEAR E 5TH STREET & PENNSYLVANIA AVENUE CLE ELUM, WA 98922 CITY OF CLE ELUM

PHOTOSIMULATION VIEWPOINT 3



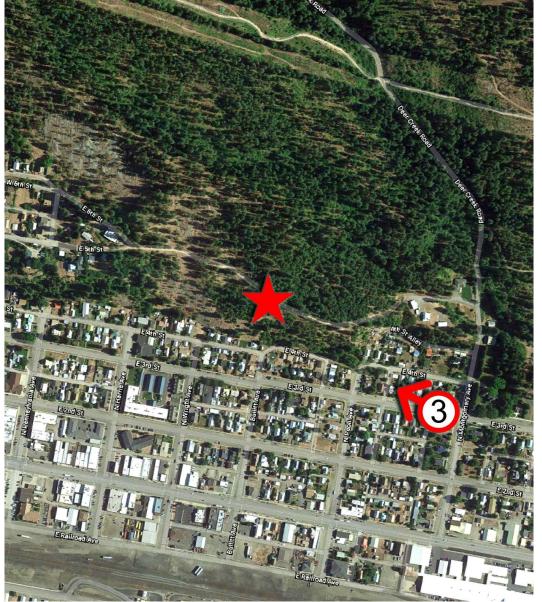

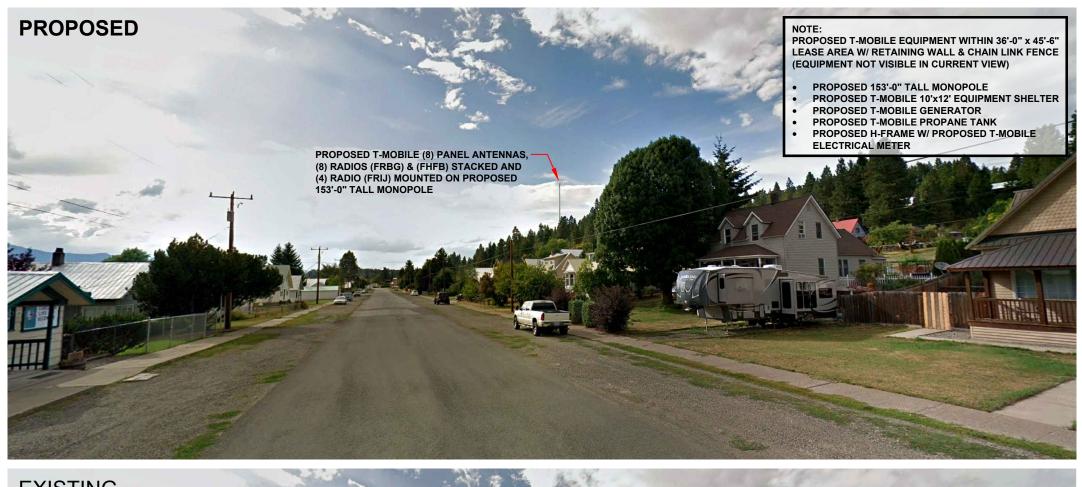



DISCLAIMER: THIS PHOTOSIMULATION IS INTENDED AS A GRAPHICAL REPRESENTATION OF EXISTING AND PROPOSED SITE CONDITIONS BASED ON THE PROJECT / DRAWING PLANS. IT IS NOT INTENDED FOR CONSTRUCTION. ACTUAL, FINAL CONSTRUCTION MAY VARY

