



RFDS: VER: 1

PROJECT: INFILL/ROB/GREENFIELD




200 SOUTH PENNSYLVANIA AVE

SITE NUMBER: US-WA-5105

CLE ELUM, WA 98922

LATITUDE 47° 11' 32.69" N (47.192414) **LONGITUDE 120° 56' 12.53" W (-120.936814) GROUND ELEVATION: 1905.6' AMSL**

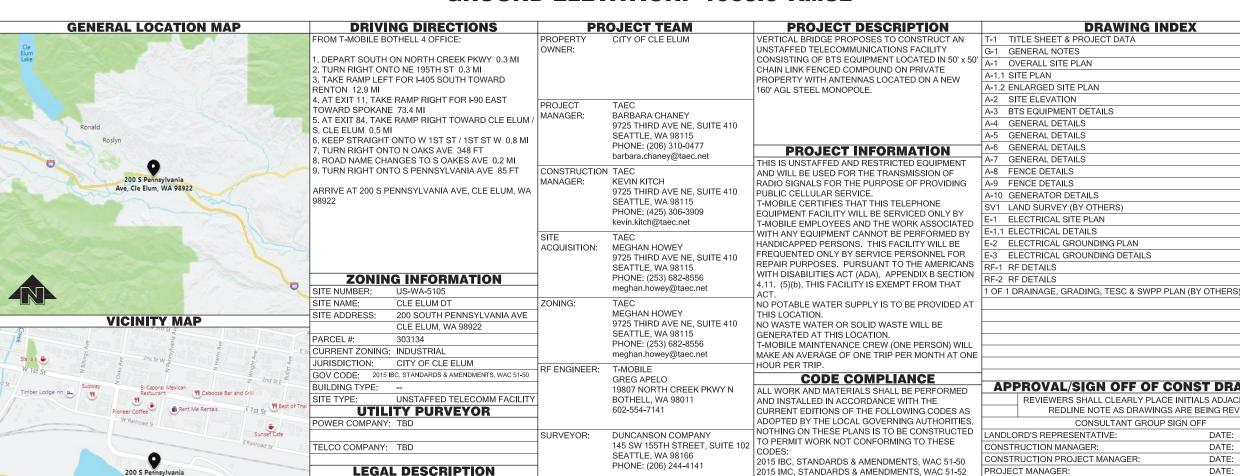

CONSULTING B.J. THOMAS, P.E.

7607 80TH AVE NE

MARYSVILLE, WA 98270

bithomas@bithomaspe.comcastbiz.net

PHONE: 206-851-1106

ACRES 18.17, SW 1/4- TAX 7 & 8; SEC. 26; TWP. 20;

Ave, Cle Elum, WA 98922

T - Mobile-

=PROJECT INFORMATION:=

CLE ELUM DT US-WA-5105

200 SOUTH PENNSYLVANIA AVE **CLE ELUM, WA 98922**

=|SSUED FOR:=

BEVISION HISTORY:=

BUILDING PERMIT

NO.	DATE:	DESCRIPTION:	CHK. BY:
7	11/17/2020	ADDING LIGHTENING ROD	ВЈТ
6	11/10/2020	REVISED PER REDLINES	BJT
5	10/29/2020	DRAINAGE PLAN ADDED	BJT
4	7/15/2020	MINOR REV	BJT
3	3/18/2020	REVISED PER REDLINES	BJT
2	2/25/2020	UPDATED SURVEY ADDED	BJT
Λ	2/12/2020	ISSUED DESIGN REVIEW	BJT

=PLANS PREPARED BY:=

B. J. THOMAS, P.E. **7607 80TH AVE NE MARYSVILLE, WA 98270** 206-851-1106

DRAWN BY: — СНК. BY:—

=LICENSURE:=



=DRAWING INFORMATION:=

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DRAWING TITLE:

TITLE SHEET

=DRAWING NUMBER:====

APPROVAL/SIGN OFF OF CONST DRAWINGS

REVIEWERS SHALL CLEARLY PLACE INITIALS ADJACENT TO EACH REDLINE NOTE AS DRAWINGS ARE BEING REVIEWED.

.	CONSULTANT GROUP SIGN OFF				
)	LANDLORD'S REPRESENTATIVE:			DATE:	
	CONSTRUCTION MANAGER:			DATE:	
	CONSTRUCTION PROJECT MANAGER:			DATE:	
	PROJECT MANAGER:			DATE:	
	SITE ACQUISITION:			DATE:	
	ZONING	:		DATE:	
	RF ENGI	NEER:		DATE:	
			CALL T	WO WORKING DAYS BEFORE YOU DIG	

2015 IEC STANDARDS & AMENDMENTS, WAC 51-54 2015 NEPA 54 - NATIONAL FUEL GAS CODE

2014 NFPA 58 - LIQUEFIED PETROLEUM GAS CODE

2015 UPC, STANDARDS & AMENDMENTS, WAC 51-56,

(PROPANE INSTALLATIONS ONLY)

(PROPANE INSTALLATIONS ONLY)

2017 NATIONAL ELECTRICAL CODE

ANSI / TIA / EIA - 222 - G

NFPA-101 - LIFE SAFETY CODE

2012 NATIONAL ELECTRIC SAFETY CODE

LOCAL BUILDING CODE ORDINANCES

2015 INTERNATIONAL FIRE CODE

CONTRACTOR(S) AT ALL
RENCHING IN ACCORDANCE
WITH CURRENT OSHA
STANDARDS

NATIONAL UTILITIES UNDERGROUND LOCATE ELECTRIC - RED TEL/CATV - ORANGE SEWER - GREEN PROPOSED - WHITE WATER - BLUE SURVEY - PINK

GAS/OIL - YELLOW

GENERAL NOTES:

- 1. DRAWINGS ARE NOT TO BE SCALED, WRITTEN DIMENSIONS TAKE PRECEDENCE, THIS SET OF DOCUMENTS IS INTENDED TO BE USED FOR DIAGRAMMATIC PURPOSED ONLY. UNLESS NOTED OTHERWISE. THE GENERAL CONTRACTOR'S SCOPE OF WORK SHALL INCLUDE FURNISHING ALL MATERIALS, EQUIPMENT, LABOR AND ANY REQUIREMENTS DEEMED NECESSARY TO COMPLETE INSTALLATION AS DESCRIBED IN THE DRAWINGS AND OWNER'S PROJECT MANUAL
- 2. THE CONTRACTOR IS RESPONSIBLE FOR ALL DIMENSIONS AND STANDARDIZED DETAILS THAT REQUIRE MODIFICATIONS DUE TO ACTUAL FIELD CONDITIONS AND REQUIREMENTS MUST BE SUBMITTED TO AND APPROVED BY, T-MOBILE WIRELESS REPRESENTATIVE PRIOR TO START OF WORK
- 3. PRIOR TO THE SUBMISSION OF BIDS, CONTRACTORS INVOLVED SHALL VISIT THE JOB SITE TO FAMILIARIZE THEMSELVES WITH ALL CONDITIONS AFFECTING THE PROPOSED PROJECT. CONTRACTORS SHALL VISIT THE CONSTRUCTION SITE WITH THE CONSTRUCTION/CONTRACT DOCUMENTS TO VERIEV FIELD CONDITIONS AND CONFIRM THAT THE PROJECT WILL BE ACCOMPLISHED. AS SHOWN PRIOR TO PROCEEDING WITH CONSTRUCTION ANY ERRORS OMISSIONS OR DISCREPANCIES SHALL BE BROUGHT TO THE ATTENTION OF THE ARCHITECT/ENGINEER VERBALLY AND IN WRITING.
- 4. THE GENERAL CONTRACTOR SHALL RECEIVE WRITTEN AUTHORIZATION TO PROCEED WITH CONSTRUCTION PRIOR TO STARTING WORK ON ANY ITEM NOT CLEARLY DEFINED BY THE CONSTRUCTION DRAWINGS/CONTRACT DOCUMENTS.
- 5. THE CONTRACTOR SHALL SUPERVISE AND DIRECT THE PROJECT DESCRIBED IN THE CONTRACT DOCUMENTS. THE CONTRACTOR SHALL BE SOLELY RESPONSIBLE FOR ALL CONSTRUCTION MEANS, METHODS, TECHNIQUES, SEQUENCES, SAFETY, AND PROCEDURES FOR COORDINATING ALL PORTIONS OF THE WORK UNDER THE CONTRACT.
- 6. THE CONTRACTOR SHALL INSTALL ALL EQUIPMENT AND MATERIALS ACCORDING TO MANUFACTURER'S/VENDOR'S SPECIFICATIONS UNLESS NOTED OTHERWISE OR WHERE LOCAL CODES OR ORDINANCES TAKE PRECEDENCE
- 7. ALL WORK PERFORMED ON THE PROJECT AND MATERIALS INSTALLED SHALL BE IN STRICT ACCORDANCE WITH ALL APPLICABLE CODES, REGULATIONS, AND ORDINANCES. CONTRACTOR SHALL GIVE ALL NOTICES AND COMPLY WITH ALL LAWS, ORDINANCES, RULES, REGULATIONS AND LAWFUL ORDERS OF ANY PUBLIC AUTHORITY, MUNICIPAL AND UTILITY COMPANY SPECIFICATIONS, AND LOCAL AND STATE JURISDICTIONAL CODES BEARING ON THE PERFORMANCE OF THE WORK.
- 8. GENERAL CONTRACTOR SHALL PROVIDE, AT THE PROJECT SITE, A FULL SET OF CONSTRUCTION DOCUMENTS UPDATED WITH THE LATEST REVISIONS INVOLVED WITH THE PROJECT. THIS SET IS A VALID CONTRACT DOCUMENT ONLY IF THE TITLE SHEET IS STAMPED IN RED INK "FOR CONSTRUCTION" AND EACH SUCCESSIVE SHEET BEARS THE ARCHITECT'S/ENGINEER'S SIGNED WET STAMP
- 9. THE CONTRACTOR IS RESPONSIBLE FOR ADEQUATELY BRACING AND PROTECTING ALL WORK DURING CONSTRUCTION AGAINST DAMAGE, BREAKAGE, COLLAPSE, ETC. ACCORDING TO APPLICABLE CODES, STANDARDS, AND GOOD CONSTRUCTION PRACTICES
- 10. THE CONTRACTOR SHALL MEET ALL OSHA REQUIREMENTS FOR ALL INSTALLATIONS.
- 11. THE CONTRACTOR SHALL BE RESPONSIBLE FOR ALL DAMAGES TO THE EXISTING CONSTRUCTION AND REPAIR ALL DAMAGES TO BETTER THAN NEW CONSTRUCTION. THE CONTRACTOR SHALL NOTIFY THE CONSULTANT OF ANY DAMAGE TO THE BUILDING SITE OR ANY ADJACENT STRUCTURES AROUND THE PROJECT. THE T-MOBILE REPRESENTATIVE SHALL BE SOLE AND FINAL JUDGE AS TO THE QUALITY OF THE REPAIRED CONSTRUCTION. ANY ADDITIONAL MODIFICATIONS WHICH MUST BE MADE SHALL BE MADE AT THE CONTRACTOR'S EXPENSE.
- 12. WHERE NEW PAVING, CONCRETE SIDEWALKS OR PATHS MEET EXISTING CONSTRUCTION, THE CONTRACTOR SHALL MATCH THE EXISTING PITCH, GRADE, AND ELEVATION SO THE ENTIRE STRUCTURE SHALL HAVE A SMOOTH TRANSITION.
- 13. THE CONTRACTOR SHALL MODIFY THE EXISTING FLOORS, WALL, CEILING, OR OTHER CONSTRUCTION AS REQUIRED TO GAIN ACCESS TO AREAS FOR ALL MECHANICAL, PLUMBING, ELECTRICAL, OR STRUCTURAL MODIFICATIONS. WHERE THE EXISTING CONSTRUCTION DOORS. PARTITIONS, CEILING, ETC., ARE TO BE REMOVED, MODIFIED, OR REARRANGED OR WHERE THE EXPOSED OR HIDDEN MECHANICAL, ELECTRICAL, SYSTEMS ARE ADDED OR MODIFIED, THE GENERAL CONTRACTOR SHALL REPAIR, PATCH AND MATCH ALL EXISTING CONSTRUCTION AND FINISHES OF ALL FLOORS WALLS AND CEILINGS. WHERE CONCRETE MASONRY CONSTRUCTION IS MODIFIED, THE CONTRACTOR SHALL TOOTH IN ALL NEW CONSTRUCTION TO MATCH THE EXISTING BOND. WHERE CONCRETE CONSTRUCTION IS MODIFIED. THE CONTRACTOR SHALL VERIFY THE EXACT DETAILS TO BE USED FOR CONSTRUCTION. ALL WORK SHALL BE COVERED UNDER THE GENERAL CONTRACT
- 14. IF CONTRACTOR OR SUBCONTRACTOR FIND IT NECESSARY TO DEVIATE FROM ORIGINAL APPROVED PLANS. THEN IT IS THE CONTRACTOR'S AND THE SUBCONTRACTOR'S RESPONSIBILITY TO PROVIDE THE CONSULTANT WITH 4 COPIES OF THE PROPOSED CHANGES FOR HIS APPROVAL BEFORE PROCEEDING WITH THE WORK. IN ADDITION THE CONTRACTOR AND SUBCONTRACTORS SHALL BE RESPONSIBLE FOR PROCURING ALL NECESSARY APPROVALS FROM THE BUILDING AUTHORITIES FOR THE PROPOSED CHANGES BEFORE PROCEEDING WITH THE WORK. THE CONTRACTOR AND SUBCONTRACTORS SHALL BE RESPONSIBLE FOR PROCURING ALL NECESSARY INSPECTIONS AND APPROVALS FROM BUILDING AUTHORITIES DURING THE EXECUTION OF THE WORK.
- 15. CONTRACTOR TO PROVIDE A PORTABLE FIRE EXTINGUISHER WITH A RATING OF NOT LESS THAN 2-A OR 2-A10BC WITHIN 75 FEET TRAVEL DISTANCE TO ALL PORTIONS OF PROJECT AREA DURING CONSTRUCTION
- 16. THE CONTRACTOR SHALL PERFORM WORK DURING OWNER'S PREFERRED HOURS TO AVOID DISTURBING NORMAL BUSINESS
- 17. SEAL ALL PENETRATIONS THROUGH FIRE-RATED AREAS WITH U.L. LISTED OR FIRE MARSHAL APPROVED MATERIALS AS APPLICABLE TO THIS FACILITY AND OR PROJECT SITE.
- 18. CONTRACTOR SHALL BE RESPONSIBLE FOR UTILITY LOCATES, SCHEDULING, COORDINATING SPECIAL AND BUILDING DEPARTMENT INSPECTIONS
- 19. CONTRACTOR SHALL BE RESPONSIBLE FOR CONTACTING AND UTILIZING ORIGINAL ROOFING CONTRACTOR AS REQUIRED TO MAINTAIN ANY EXISTING ROOFING WARRANTY.
- 20. ROUTING OF ALL CONDUITS, CABLES, CABLE TRAYS ETC ARE INDICATED AS PROPOSED LOCATION ONLY. CONFIRM THE EXACT LOCATION AND ROUTING WITH THE ON SITE T-MOBILE CONSTRUCTION MANAGER PRIOR TO STARTING WORK

CONCRETE NOTES:

#5 AND SMALLER & WWF11/2 IN.

- 1. ALL CONCRETE WORK SHALL BE IN ACCORDANCE WITH THE ACI 301, ACI 318 AND THE SPECIFICATION CAST-IN-PLACE CONCRETE
- 2. ALL CONCRETE SHALL HAVE A MINIMUM COMPRESSIVE STRENGTH OF 3000 PSI AT 28 DAYS UNO.
- 3. REINFORCING STEEL SHALL CONFORM TO ASTM A 615. GRADE 60. DEFORMED UNLESS NOTED OTHERWISE, WELDED WIRE FABRIC SHALL CONFORM TO ASTM A 185 WELDED STEEL WIRE FABRIC UNLESS NOTED OTHERWISE. SPLICES CLASS "B" AND ALL HOOKS SHALL BE STANDARD UNO.
- 4. THE FOLLOWING MINIMUM CONCRETE COVER SHALL BE PROVIDED FOR REINFORCING STEEL UNLESS SHOWN OTHERWISE ON DRAWINGS: CONCRETE CAST AGAINST EARTH - 3 IN. CONCRETE EXPOSED TO EARTH OR WEATHER: #6 AND LARGER ...
- 5. A 1/2" TROWELED RADIUS SHALL BE PROVIDED AT ALL EXPOSED EDGES OF CONCRETE UNO. HOLES TO RECEIVE EXPANSION/WEDGE ANCHORS SHALL BE 1/8" LARGER IN DIAMETER THAN THE ANCHOR BOLT, DOWEL OR ROD AND SHALL CONFORM TO MFR RECOMMENDATION FOR EMBEDMENT DEPTH OR

6. INSTALLATION OF CONCRETE EXPANSION/WEDGE ANCHOR, SHALL BE PER MANUFACTURER'S WRITTEN RECOMMENDED PROCEDURES.

AS SHOWN ON THE DRAWINGS. AVOID CUTTING EXISTING REBAR WHEN DRILLING HOLES IN THE

7. FLOAT SURFACE SHALL BE A SMOOTH FINISH. SURFACE SHALL BE FREE OF ALL OBVIOUS DEPRESSIONS. SURFACE SHALL BE SLOPED AT 2% TO PROMOTE DRAINAGE AWAY FROM EQUIPMENT.

ABBREVIATIONS

ELEVATED SLAB

INSUL INSULATION VERT VERTICAL INT INTERIOR W/ WITH	CMU CONC CONST CONT CONT CONT CONT CONT CONT CONT CON	AIR CONDITIONER ABOVE FINISHED FLOOR ABOVE FINISHED FLOOR ABOVE FINISHED GRADE AND FROM THE STAND AND THE STAND	MINING HILL MAN NOOD HER PERSON TO THE CONTROL OF T	JOINT LAMINATED LINEAL FOOT MANUFACTURER MAXIMUM MECHANICAL MANHOLE MILLIMETER MINIMUM MISCELLANEOUS MILES PER HOUR METAL NOT IN CONTRACT NOMINAL NOT TO SCALE ON CENTER OUTSIDE DIAMETER OVERHEAD OPENING OPPOSITE PROPOSED PROSONAL COMMUNICATION SYS PLATE PAIR POUNDS PER SQUARE INCH POUNDS PER SQUARE FOOT PRESSURE TREATED RADIUS ROOF DRAIN REINFORCED/REINFORCING REQUIRED ROOM RIGHT OF WAY SCHEDULE SECTION SQUARE FOOT STAINLESS STEEL STANDARD STELL STRUCTURAL TEMPORARY THICK TOP OF STEEL VINNIESS NOTERET VINNIESS NOTERET TOP OF STEEL VINNIESS NOTERET TYPICAL UNLESS NOTERET TOP OF STEEL VINNIESS NOTERET TYPICAL UNLESS NOTERET TYPICAL TY
WWM WELDED WIRE MESH	HOR HR HVAC INSUL INT	HOLLOW METAL HORIZONTAL HOUR HEIGHT HEATING VENTILATION AIR CONDITIONING INSULATION INTERIOR	TOC TYP UNO VCT VERT	TOP OF CONCRETE

LEGENDS & SYMBO	OLS
CHAIN LINK FENCE	_ x x x x x
CEDAR FENCE	
POWER	- P $-$
TELCO	$ \tau \tau \tau \tau \tau \tau \tau -$
POWER/TELCO	- P $-$ T $-$ P $-$ T $-$ P $-$ T $-$
COAX	- coax — coax — coax — coax —
OVERHEAD POWER	—он——он——он——он——
CENTERLINE	
REVISION BUG	1
	DETAIL NUMBER
ELEVATION VIEW BUG	
	SHEET NUMBER
ELEVATION VIEW BUILD	TOP OF XXXXX
ELEVATION VIEW BUG	XXX'-X" AGL
DETAIL BUG	DETAIL NUMBER
	SHEET NUMBER
	DETAIL NUMBER
SECTION BUG	
	SHEET NUMBER

SITE WORK NOTES:

- 1. RUBBISH, STUMPS, DEBRIS, STICKS, STONES AND OTHER REFUSE SHALL BE REMOVED FROM THE SITE AND DISPOSED OF LEGALLY
- 2. THE SITE SHALL BE GRADED TO CAUSE SURFACE WATER TO FLOW AWAY FROM THE PCS FOLIPMENT TOWER AREAS, AND ADJACENT BUILDINGS
- 3. NO FILL OR EMBANKMENT MATERIAL SHALL BE PLACED ON FROZEN GROUND. FROZEN MATERIALS, SNOW OR ICE SHALL NOT BE PLACED IN ANY FILL OR EMBANKMENT.
- 4. THE SUBGRADE SHALL BE COMPACTED AND BROUGHT TO A SMOOTH UNIFORM GRADE PRIOR TO THE CRUSHED STONE APPLICATION
- 5. ALL EXISTING ACTIVE SEWER, WATER, GAS, ELECTRIC, AND OTHER UTILITIES WHERE ENCOUNTERED IN THE WORK SHALL BE PROTECTED AT ALL TIMES AND WHERE REQUIRED FOR THE PROPER EXECUTION OF THE WORK, SHALL BE RELOCATED AS DIRECTED BY ENGINEERS. EXTREME CAUTION SHOULD BE USED BY THE CONTRACTOR WHEN EXCAVATING OR PIER DRILLING AROUND OR NEAR UTILITIES. CONTRACTOR SHALL PROVIDE SAFETY TRAINING FOR THE WORKING CREW.
- 6. ALL EXISTING INACTIVE SEWER, WATER, GAS, ELECTRIC AND OTHER UTILITIES, WHICH INTERFERE WITH THE EXECUTION OF THE WORK, SHALL BE REMOVED AND SHALL BE CAPPED, PLUGGED OR OTHERWISE DISCONTINUED AT POINTS WHICH WILL NOT INTERFERE WITH THE EXECUTION OF THE WORK, SUBJECT TO THE APPROVAL OF
- 7. THE AREAS OF THE CUSTOMER'S PROPERTY DISTURBED BY THE WORK AND NOT COVERED BY THE BUILDING, DRIVEWAY OR CRUSHED STONE, SHALL BE GRADED TO A UNIFORM SLOPE, FERTILIZED, SEEDED, AND COVERED WITH MULCH AS SPECIFIED IN THE SPECIFICATION LANDSCAPE WORK.
- 8 BEDDING MATERIAL FOR LITH ITY LINES CUI VERTS AND PIPING: CLEAN SAND MEDILIM TP COARSE, SUB ROUNDED NATURAL RIVER OR BANK SAND, WASHED, FREE OF SILT OR CLAY, LOAM, FRIABLE OR SOLUBLE MATERIALS, AND ORGANIC MATER; GRADED IN ACCORDANCE WITH THE FOLLOWING GRAIN SIZE DISTRIBUTION:

SIEVE SIZE	PERCENT PASSING
3/8"	100
NO. 4 MESH	60-90
NO. 8 MESH	0-45
NO. 16 MESH	0-25
NO. 100 MESH	0-2
NO. 100 MESH	0-2
NO. 200 MESH	0-2

9. BMP'S FOR TEMPORARY EROSION/SEDIMENTATION CONTROL SHALL BE IMPLEMENTED PER LOCAL, CITY OR COUNTY GUIDELINES AND PER PLAN IF APPLICABLE.

SPECIAL INSPECTIONS:

SPECIAL INSPECTIONS IN ACCORDANCE WITH IBC 2015 SECTION 1704.

SOILS/GEOTECHNICAL:

- ☐ SHORING INSTALLATION AND MONITORING
- □ OBSERVE AND MONITOR EXCAVATION
- ☐ VERIFY SOIL BEARING nsf BEARING
- ☐ SUBSURFACE DRAINAGE PLACEMENT
- □ VERIFY FILL MATERIAL AND COMPACTION
- □ VERIFY CONDITIONS AS ANTICIPATED
- □ PILE PLACEMENT (AUGER CAST/DRIVEN PILE)
- □ OTHER

REINFORCED CONCRETE:

- ☐ REINFORCING STEEL AND CONCRETE PLACEMENT
- □ PRESTRESSED/PRECAST CONCRETE FABRICATION AND ERECTION
- □ BATCH PLANT INSPECTION
- □ SHOTCRETE
- □ GROUTING □ OTHER

STRUCTURAL STEEL:

- ☐ FABRICATION AND SHOP WELDS
- ☐ ERECTION AND FIELD WELDS AND BOLTING
- □ OTHER

STRUCTURAL ALLIMINUM:

- ☐ FABRICATION AND SHOP WELDS
- ☐ ERECTION AND FIELD WELDS AND BOLTING □ OTHER:

STRUCTURAL MASONRY:

- □ PERIODIC

MISCELLANEOUS:

□ OTHER:

ANCHORING TO CONCRETE:

- ☐ BOLTS INSTALLED IN CONCRETE
- ☐ POST-INSTALLATION ADHESIVE ANCHORS
- □ POST-INSTALLATION MECHANICAL ANCHORS



==PROJECT INFORMATION:=

CLE ELUM DT US-WA-5105 200 SOUTH PENNSYLVANIA AVE

CLE ELUM. WA 98922

=ISSUED FOR:

BUILDING PERMIT

=REVISION HISTORY:				
NO.	DATE:	DESCRIPTION:	BY:	
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=PLANS PREPARED BY:====

B. J. THOMAS, P.E. **7607 80TH AVE NE MARYSVILLE, WA 98270** 206-851-1106

=DRAWN BY:====	——СНК. ВҮ:	
JL	ВЈ	




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GENERAL NOTES

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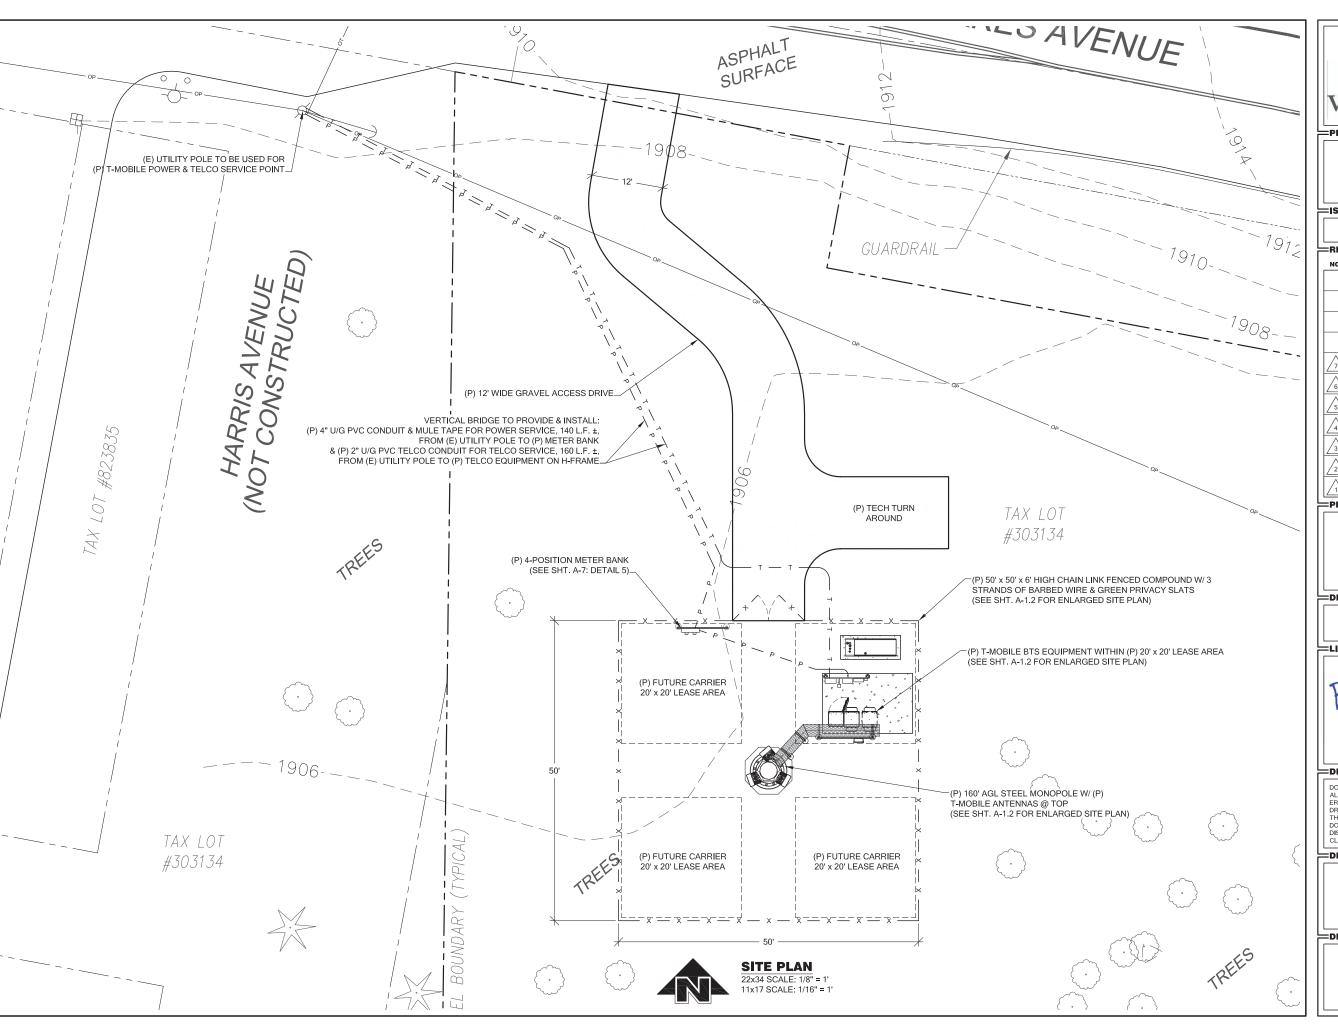
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OVERALL SITE PLAN

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200 SOUTH PENNSYLVANIA AVE CLE ELUM, WA 98922

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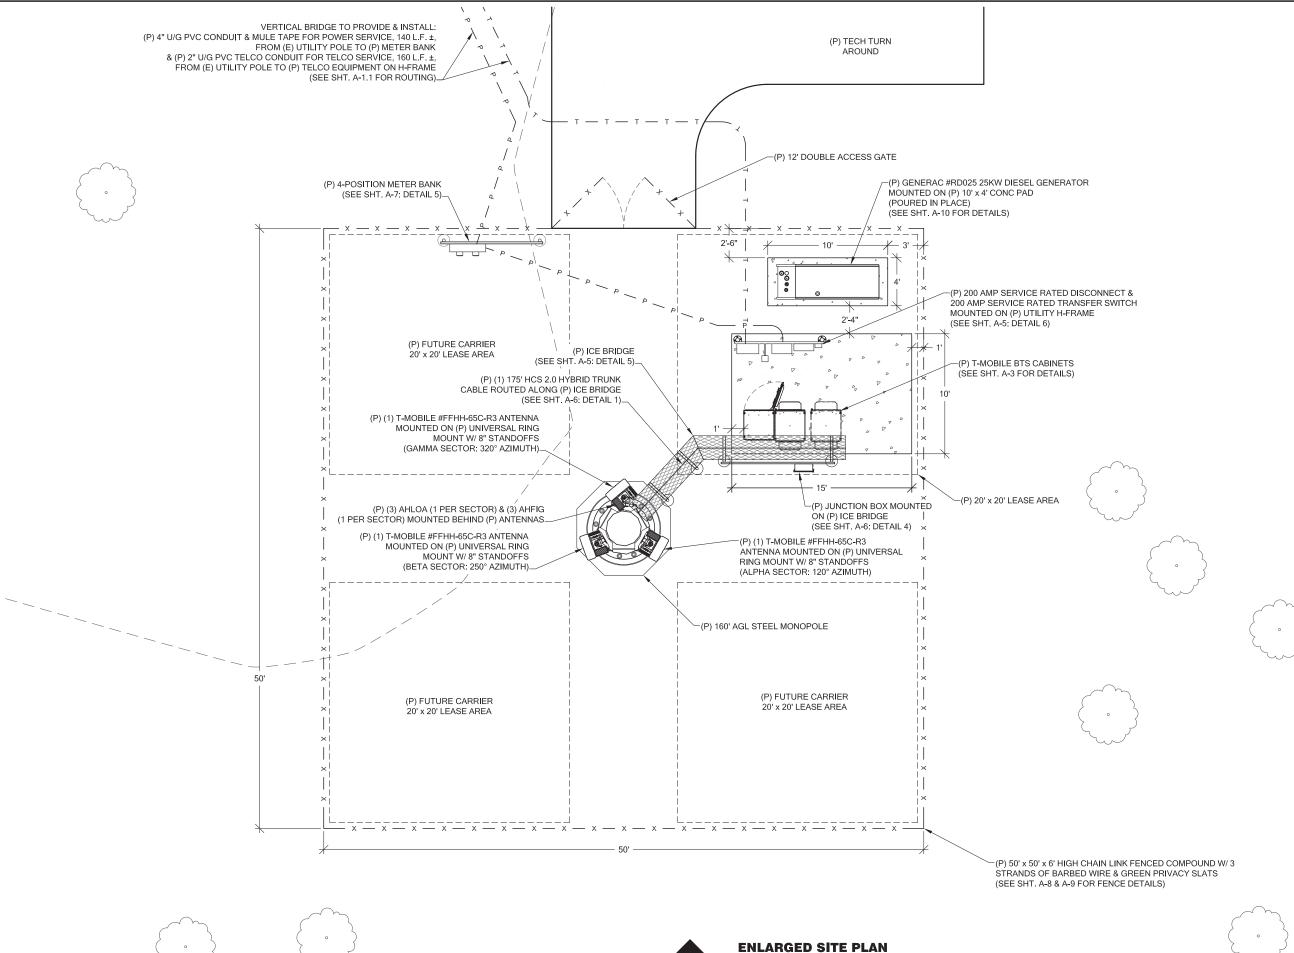
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DRAWING TITLE:

SITE PLAN

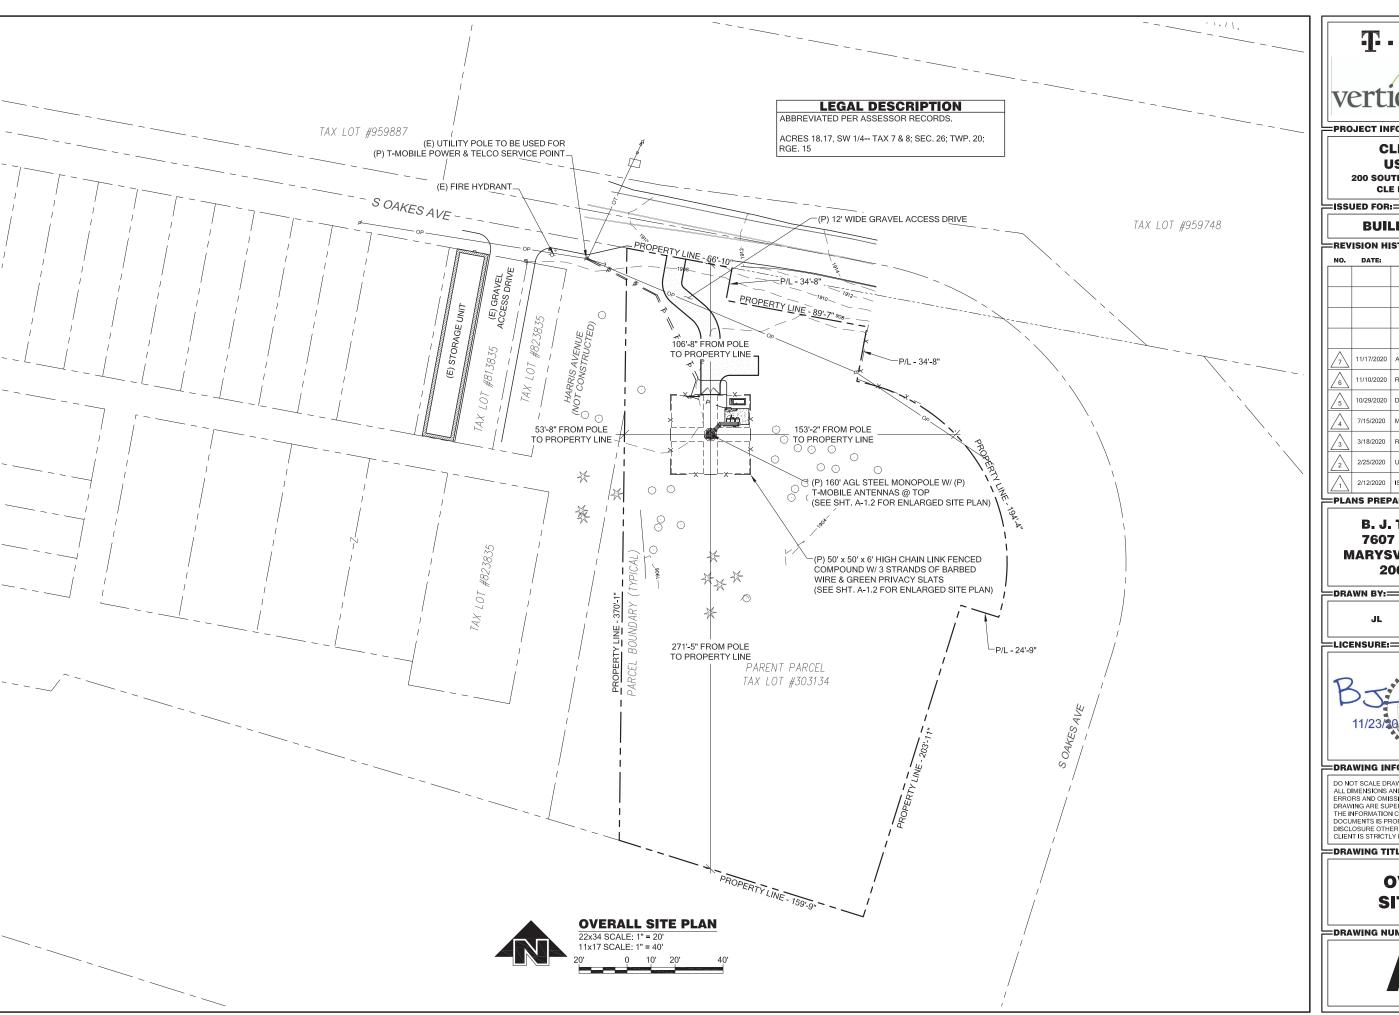DRAWING NUMBER:

A-1.1





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CLE ELUM DT US-WA-5105

200 SOUTH PENNSYLVANIA AVE CLE ELUM, WA 98922

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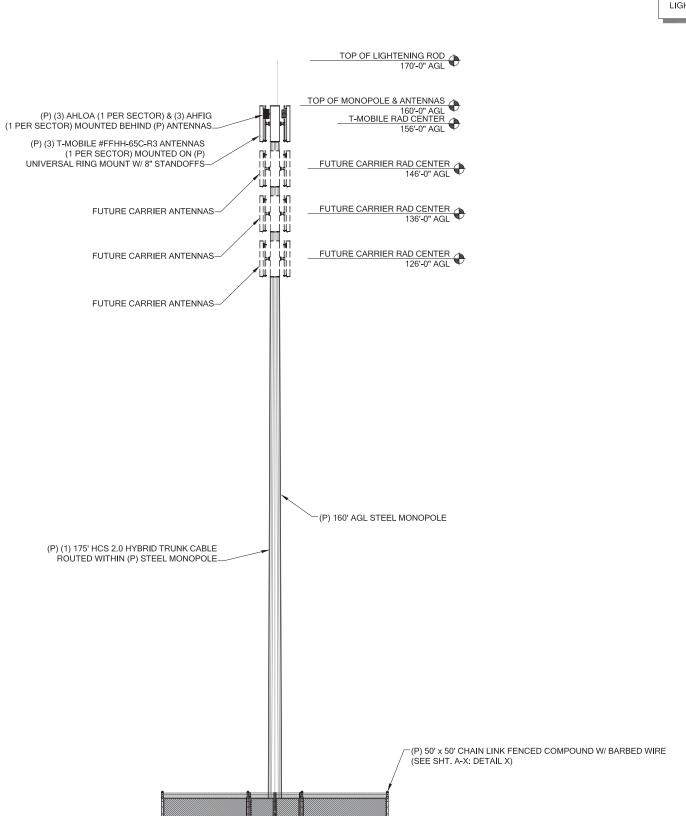
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ENLARGED SITE PLAN

=DRAWING NUMBER:====

A-1.2





1 NORTH ELEVATION
A-2 SCALE: NTS

PAINT NOTE:

THE TOWER AND ALL PROPOSED AND FUTURE ANTENNAS AND ATTACHMENTS SHALL BE FACTORY PAINTED A COLOR THAT IS SELECTED BY THE TOWER OWNER AND IS SIMILAR TO, AND NO LIGHTER THAN, SHERWIN WILLIAMS JASPER #6216.



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DRAWING INFORMATION:


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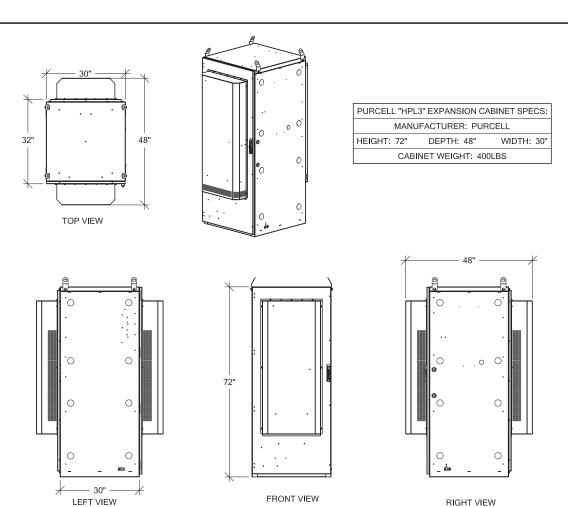
DRAWING TITLE:

SITE ELEVATION

DRAWING NUMBER:

A-2



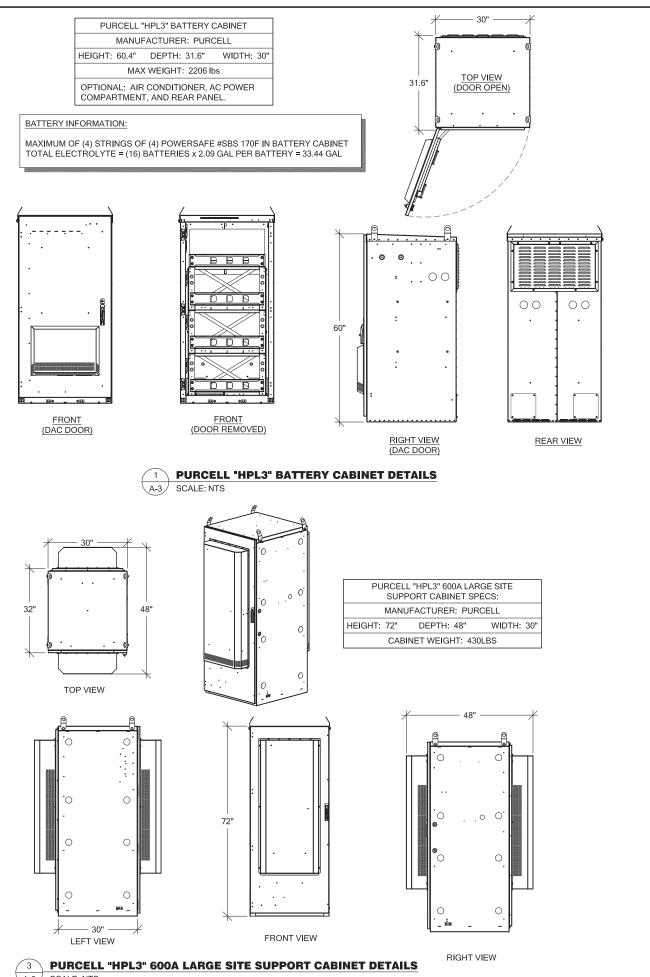

PURCELL "HPL3" EXPANSION CABINET DETAILS

A-3 SCALE: NTS



PROJECT INFORMATION:

CLE ELUM DT US-WA-5105

200 SOUTH PENNSYLVANIA AVE CLE ELUM, WA 98922

ISSUED FOR:=

BUILDING PERMIT

REV	CHK. BY:		
140.	DATE:	DESCRIPTION:	Τ
<u>_7</u>	11/17/2020	ADDING LIGHTENING ROD	BJT
6	11/10/2020	REVISED PER REDLINES	BJT
5	10/29/2020	DRAINAGE PLAN ADDED	ВЈТ
4	7/15/2020	MINOR REV	ВЈТ
3	3/18/2020	REVISED PER REDLINES	ВЈТ
2	2/25/2020	UPDATED SURVEY ADDED	BJT
\bigwedge	2/12/2020	ISSUED DESIGN REVIEW	BJT

PLANS PREPARED BY:

B. J. THOMAS, P.E. 7607 80TH AVE NE MARYSVILLE, WA 98270 206-851-1106

JL BJ





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DRAWING TITLE:

BTS EQUIPMENT DETAILS

DRAWING NUMBER:

A-3


A-3 SCALE: NTS

MANUFACTURER: MODEL:

NOKIA ABIA AIR SCALE


WEIGHT:

DIMENSION (HxWxD) 1.9" x 8.3" x 14.8" 4.63 LBS

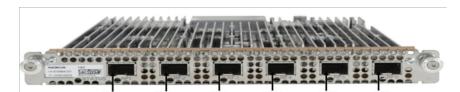



ASIK - Baseband Card

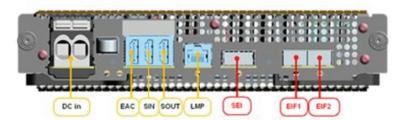

MANUFACTURER: NOKIA MODEL: ASIK AIR SCALE

DIMENSION (HxWxD) 1.9" x 8.3" x 14.8" WEIGHT: 6.83 LBS

ASIA plug in unit Ext Alarm GPS -& Ctrl



External SM ext

- Flexi

(SFP+)

MANUFACTURER: MODEL:

DIMENSION (HxWxD)

WEIGHT:


1Gbps Electrical Ethernet (RJ45)

LMP

6.83 LBS

ASIA AIR SCALE

1.9" x 8.3" x 14.8"

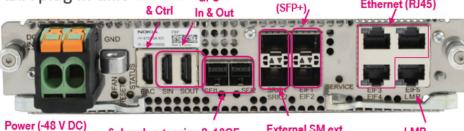


Subrack extension 2x10GE

Mini SAS-HD

ASIA DETAIL SCALE: NTS




ABIL - Capacity Card

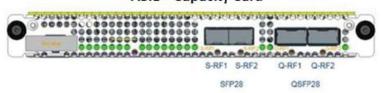


MANUFACTURER: NOKIA ABIL AIR SCALE MODEL:

1.9" x 8.3" x 14.8" DIMENSION (HxWxD) 4.63 LBS WEIGHT:




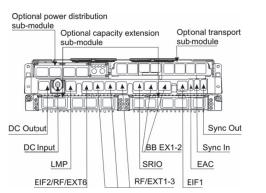

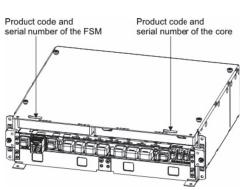

FSMF MODULE				
PROPERTY	VALUE			
HEIGHT	133mm/3U (5.2 in)			
WIDTH	447 mm (17.6 in)			
DEPTH	422 mm (16.5 in)			
WEIGHT W/ CORE MODULE	MAX. 11.5 kg (25.3 lb)			



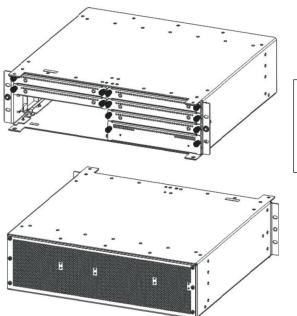

MANUFACTURER: MODEL: AMIA AIRSCALE SUBRACK 5.0" x 17.6" x 15.7" EMPTY: 10.9 LBS DIMENSION (HxWxD) WEIGHT:

WITH BLINDS: 14.8 LBS WITH ALL UNITS: 52 LBS



AMIA DETAIL SCALE: NTS



PROJECT INFORMATION:=

CLE ELUM DT US-WA-5105

200 SOUTH PENNSYLVANIA AVE CLE ELUM, WA 98922

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1	2/12/2020	ISSUED DESIGN REVIEW	BJT

PLANS PREPARED BY:

B. J. THOMAS, P.E. **7607 80TH AVE NE MARYSVILLE, WA 98270** 206-851-1106

DRAWN BY: CHK. BY:

LICENSURE:




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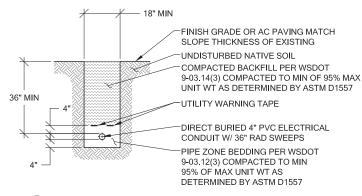
GENERAL DETAILS





1 TELCO SERVICE TRENCH

A-5 SCALE: NTS

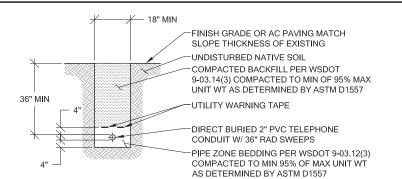

3 CONC. EQUIPMENT SLAB DETAIL

SCALE: NTS

-GROUND LEVEL

4" GRAVEL (7/8 CHIPPED NO FINES)

OVER LANDSCAPE WEED BARRIER

NO SPECIAL INSPECTIONS REQUIRED.

LANDSCAPE WEED BARRIER

3000 PSI CONCRETE.

1/2" CHAMFER (TYP)_

UNDISTURBED NATIVE SOIL


#4 REBAR @ 12" O.C. EACH

6" COMPACTED AGGREGATE TO 95%

MAX UNIT WEIGHT PER ASTM D1557-

8" CONC PAD FOR BTS EQUIPMENT

WAY OR WIRE MESH-

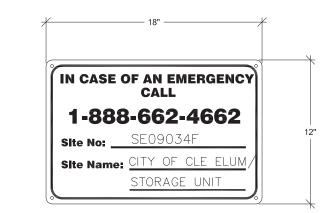


4 SITE SIGNAGE DETAIL
A-5 SCALE: NTS

2 POWER SERVICE TRENCH A-5 SCALE: NTS

NOTE:

ANCHOR DETAIL- 1/2" DIAMETER ANCHOR BOLTS IF CAST IN PLACE WITH 6" DEPTH OR 5/8" DIAMETER HILTI KWIK HUS-EZ BOLTS IF POST-INSTALLED WITH 6" DEPTH.


PLATE DETAIL- CARRIER CAN ALTERNATELY INSTALL A PRE-MANUFACTURED KIT FROM SITE PRO, SUCH AS THEIR PRODUCT "IB24D" OR IB24B".

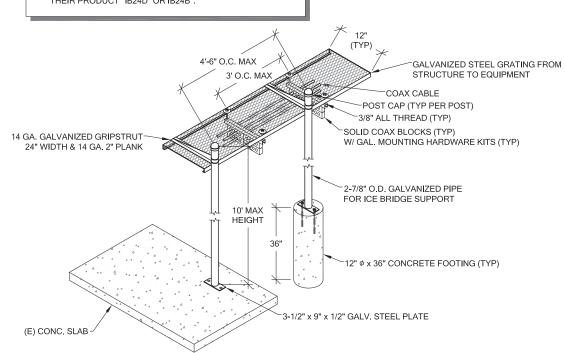

ICE BRIDGE DETAIL

SCALE: NTS



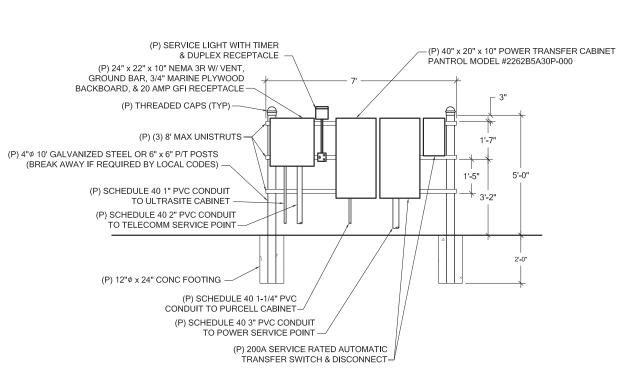



PROJECT INFORMATION:

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PLANS PREPARED BY:

B. J. THOMAS, P.E. 7607 80TH AVE NE MARYSVILLE, WA 98270 206-851-1106

-	☐DRAWN BY:=	CHK. BY:
	JL	ВЈ

LICENSURE:=



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GENERAL DETAILS




HELIAX® FiberFeed® Hybrid Trunk Cables

FiberFeed® trunk cable assemblies are factory constructed specifically for the devices listed in this guide ensuring perfect compatibility and trouble free installation. Additional features that ease installation and ensure a long service life include:

- Robust breakout design tailored for specific enclosures
- Integrated rip cords for length management
- Stranded construction for easy bending and maximum fiber protection
 Factory test certificate included with every cable assembly
- Corrugated aluminum shield protects from crush and animal damage

Specifications

Hybrid Trunk Cable 6 AWG power conductor wire 24 Single mode fiber					
FD2606-24S55	6	6	24	24	31/33

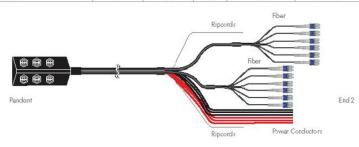

HYBRID TRUNK CABLE DETAIL SCALE: NTS

Hybrid Jumpers for Nokia Radios

Ordering Information

Hybrid Jumpers for Nokia Radios	6	HFT410-4\$NOK2-6
End 1: 4 fibers terminated DIC for Nokia RRUs with flush out power cord (red/black conductors).	10	HFT41 0-48NOK2-10
End 2: 4 fibers terminated LC and 4 X 10 AVVG	15	HFT410-4\$NOK2-15
conductors terminated at hybrid trunk connector (HQLC)	20	HFT410-4\$NOK2-20
	25	HFT410-4\$NOK2-25
	30	HFT410-4\$NOK2-30
	40	HFT410-4\$NOK2-40
	50	HFT410-4\$NOK2-50
	60	HFT410-4\$NOK2-60
	70	HFT410-4\$NOK2-70
	80	HFT410-4\$NOK2-80
	90	HFT410-4\$NOK2-90
	100	HFT410-4SNOK2-100

Note: Longer lengths are available; contact your CommScope sales representative for details.






RADIO MODULE FOR 600/700MHz RRH

MANUFACTURER: MODEL:


AHLOA

NET WEIGHT: DIMENSION (LxWxD) 83.78 LBS 22.05" x 12.13" x 7.44"

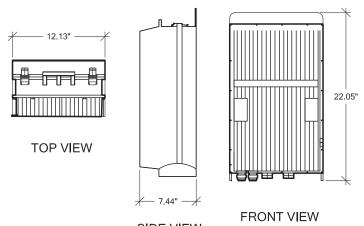

SIDE VIEW 3 AHLOA DETAIL
A-6 SCALE: NTS


MANUFACTURER: MODEL: AHFIG 70.5 LBS WEIGHT: 27.4" x 12.1" x 6.5" DIMENSION (LxWxD)

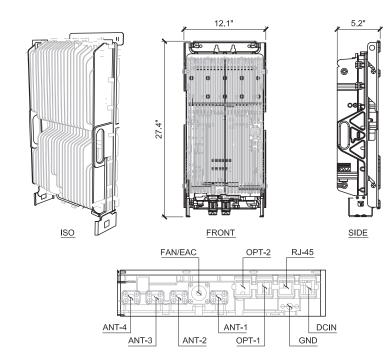


AHFIG DETAIL SCALE: NTS

FIBER & POWER JUNCTION BOX W/ OVP

MANUFACTURER: COMMSCOPE MODEL: FE-16148-OVP-B12 DIMENSION (HxWxD) 16" x 14" x 8" WEIGHT: 23.5lbs

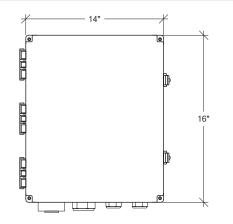

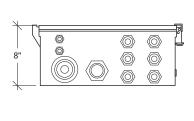





CLE ELUM DT US-WA-5105

200 SOUTH PENNSYLVANIA AVE **CLE ELUM, WA 98922**

ISSUED FOR:=

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NO.	EVISION HISTORY:		
	DATE	DESCRIPTION!	BY:
^			
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1	2/12/2020	ISSUED DESIGN REVIEW	ВЈТ

PLANS PREPARED BY:

B. J. THOMAS, P.E. **7607 80TH AVE NE MARYSVILLE, WA 98270** 206-851-1106

DRAWN BY: CHK. BY:

LICENSURE:



=DRAWING INFORMATION:=


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GENERAL DETAILS









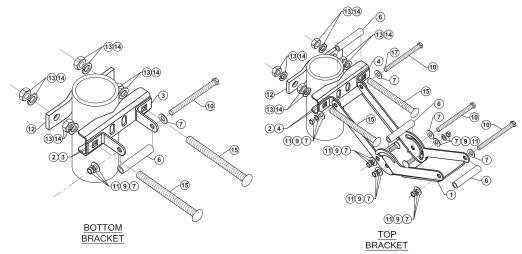

NOTE: -PROPOSED RRUS TO BE MOUNTED VERTICALLY ONLY -MOUNTING PIPE NOT SHOWN FOR CLARITY

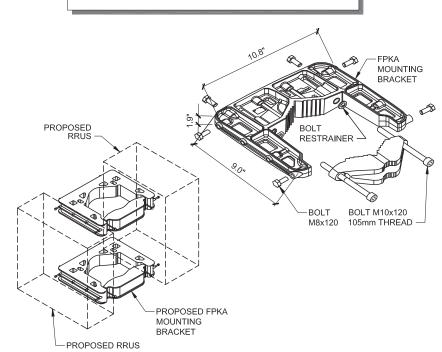


FPKA DETAIL SCALE: NTS

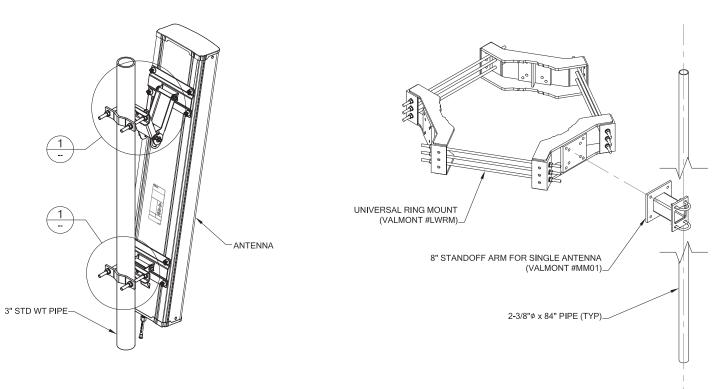



UNIVERSAL RING MOUNT & 8" STANDOFF DETAIL

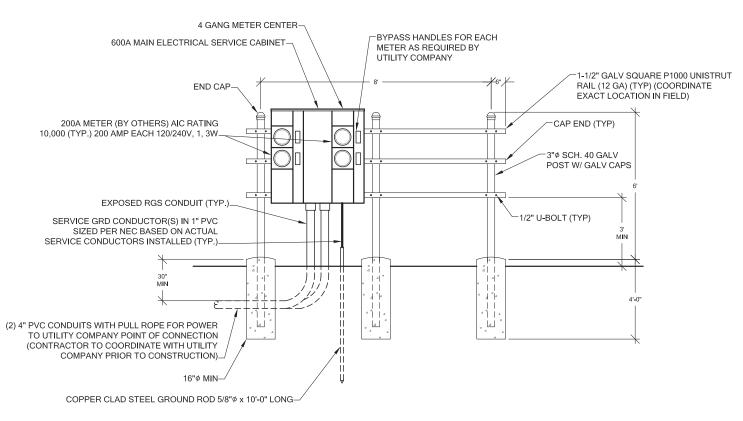





CLE ELUM DT US-WA-5105

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LICENSURE:=




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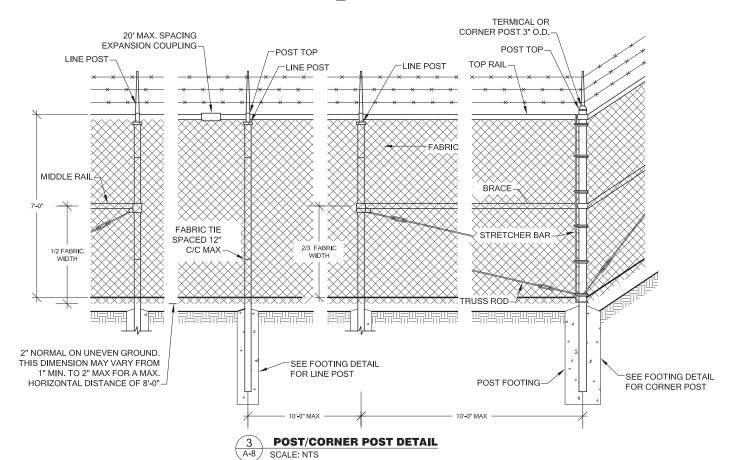
DRAWING TITLE:

GENERAL DETAILS






1 CHAIN LINK DETAIL A-8 SCALE: NTS

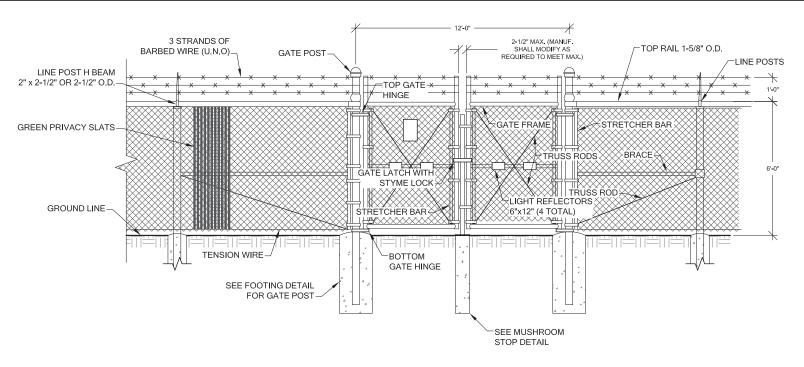

CENTER GATE STOP

METAL MUSHROOM STOP.
INSTALL WITH SLOT PARALLEL
WITH GATE CLOSED

MUSHROOM STOP DETAIL
A-8 SCALE: NTS

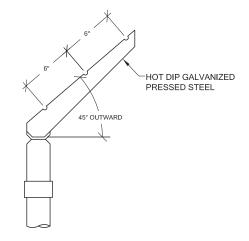

4 BARBED WIRE ARM OF LINE POST
A-8 SCALE: NTS



5 INSTALLATION AT CORNERS
A-8 SCALE: NTS



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PLANS PREPARED BY:

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ļ	DRAWN BY: CHK, BY:					
		BJ				
	JL.	BJ				



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DRAWING TITLE:

FENCE DETAIL

DRAWING NUMBER:

A-8

NOTES:

ZINC COATING - THE WEIGHT OF THE COATING SHALL NOT BE LESS THAN 1.2 OUNCES PER SQUARE FOOT OF ACTUAL SURFACE COVERED. ALL FERROUS METALS USED AS PART OF THE FENCE INSTALLATION SHALL BE HOT DIP GALVANIZED OR STAINLESS STEEL. ALL SCREWS, BOLTS, LOCK WASHERS, NUTS, ETC. SHALL BE HOT DIP GALVANIZED OR MADE OF STAINLESS STEEL.

FABRIC - STANDARD INDUSTRIAL GRADE #9 GAUGE WITH 2 INCH MESH ZINC COATED CHAIN LINK WITH A BREAKING STRENGTH OF NOT LESS THAN 1290 POUNDS SHALL BE USED. THE FABRIC SHALL BE ZINC COATED BY THE HOT DIP PROCESS AFTER

METAL POSTS - METAL POSTS (LINE, CORNER, TERMINAL, GATE POSTS, MIDDLE RAILS, BRACES AND TOP RAIL) SHALL BE HOT DIP GALVANIZED SCHEDULE 40 TUBULAR STEEL WITH AN OUTSIDE DIAMETER AS INDICATED ON THE DRAWING. A POST TOP FITTING OF GALVANIZED STEEL WILL BE INSTALLED TO EXCLUDE MOISTURE.

POSTS CAPS - ALL POST CAPS TO USE THE BARBED WIRE OUTRIGGER BRACKET AND SHALL BE ATTACHED TO THE POST WITH TAMPER RESISTANT SCREWS, BRADS, OR BOLTS.

TOP RAIL - A MINIMUM OF ONE COUPLING IN EACH STRAIGHT RUN OF TOP RAIL, SHALL HAVE A HEAVY SPRING INSERTED WITHIN THE COUPLING TO TAKE UP EXPANSION AND CONTRACTION OF THE TOP RAIL. THE TOP RAIL SHALL BE FASTENED TO TERMINAL

MIDDLE RAIL - THE MIDDLE RAIL SHALL BE OF THE SAME MATERIAL AS THE TOP RAIL AND INSTALLED WITH HOT DIP GALVANIZED

BRACE RAIL - BRACE RAIL MATERIAL SHALL BE OF THE MATERIAL AS THE TOP RAIL AND LOCATED 2/3 OF THE DISTANCE UP FROM THE BOTTOM OF THE FABRIC. BRACE RAILS SHALL BE SECURELY FASTENED TO POSTS BY SUITABLE PRESSED STEEL

TRUSS RODS - SHALL BE 3/8" ROUND GALVANIZED STEEL RODS WITH GALVANIZED TURNBUCKLES. THE ZINC COATING SHALL BE NOT LESS THAN 1.2 OUNCES PER SQUARE FOOT OF SURFACE.

TENSION WIRE - THE TENSION WIRE SHALL BE OF #7 GAUGE HOT DIP GALVANIZED SPRING TENSION WIRE WITH A BREAKING STRENGTH OF NOT LESS THAN 1900 POUNDS. THIS WIRE SHALL BE KEPT TAUT WITH GALVANIZED TURNBUCKLES AND ATTACHED TO POSTS WITH GALVANIZED HARDWARE OR CABLE CLAMPS.

FABRIC TIES - THE FABRIC TIES SHALL BE ALUMINUM WIRE NOT LESS THAN #9 GAGE

STRETCHER BARS - THE STRETCHER BARS SHALL BE FLAT GALVANIZED STEEL BARS NOT LESS THAN 5/16" x 3/4" AND NOT LESS THAN 2" SHORTER THAN THE FABRIC. STRETCHER BAR BANDS SHALL BE FLAT GALVANIZED STEEL BARS NOT LESS THAN 5/16" x 1-1/2" WITH 5/16" DIAMETER GALVANIZED CARRIAGE BOLT.


BARBED WIRE - BARBED WIRE OF GALVANIZED STEEL (OR ALUMINUM) CONSISTING OF 12 1/2 GAUGE WIRE WITH 4-POINT BARBS OF 14 GAUGE WIRE SPACED 5 INCHES APART.

GATE FRAMES SHALL BE CONSTRUCTED OF 2-1/2 INCH OUTSIDE DIAMETER HEAVY DUTY GALVANIZED STEEL PIPE. THE GATES SHALL BE ASSEMBLED USING CORNER FITTINGS OF HEAVY PRESSED STEEL OR MALLEABLE CASTINGS OR MAY BE WELDED IF THE ENTIRE GATE FRAME IS HOT DIP GALVANIZED AFTER THE WELDING. ALL GATES SHALL BE EQUIPPED WITH HEAVY DUTY GALVANIZED STEEL TYPE HINGES WITH LARGE BEARING SURFACES OF ADEQUATE STRENGTH TO SUPPORT THE GATE. THE HINGES SHALL NOT TWISTED OR TURN UNDER THE ACTION OF THE GATE. GATES WILL PROVIDE A FULL RANGE OF MOTION AND BE EASILY OPENED AND CLOSED BY ONE PERSON. GATE LATCH SHALL BE CARGO PROTECTORS, INC. MODEL FL-100. LATCH SHALL BE EQUIPPED TO RECEIVE A PADLOCK.

METHOD OF FASTENING


STRETCHER BAR TO POST

PROVIDE R.F. WARNING SIGNAGE ON ALL GATES.

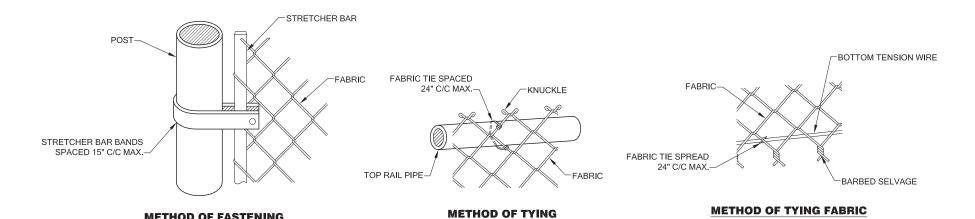

FABRIC TO PIPE



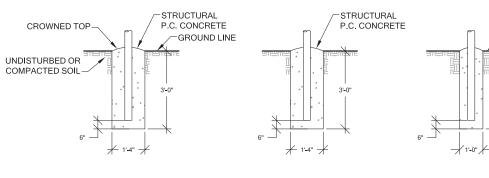

FOOTING FOR TERMINAL OR CORNER POST

FOOTING FOR GATE POST

FOOTING FOR LINE POST

GROUND LINE

POST FOOTING DETAIL SCALE: NTS

TO TENSION WIRE



=PROJECT INFORMATION:=

CLE ELUM DT US-WA-5105

200 SOUTH PENNSYLVANIA AVE **CLE ELUM. WA 98922**

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1	2/12/2020	ISSUED DESIGN REVIEW	BJT

PLANS PREPARED BY:

B. J. THOMAS, P.E. **7607 80TH AVE NE MARYSVILLE, WA 98270** 206-851-1106

ř	=DRAWN BY:====CHK. BY:===					
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ı	JL	BJ				



=DRAWING INFORMATION:=


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=DRAWING TITLE:===

FENCE DETAILS

=DRAWING NUMBER:====



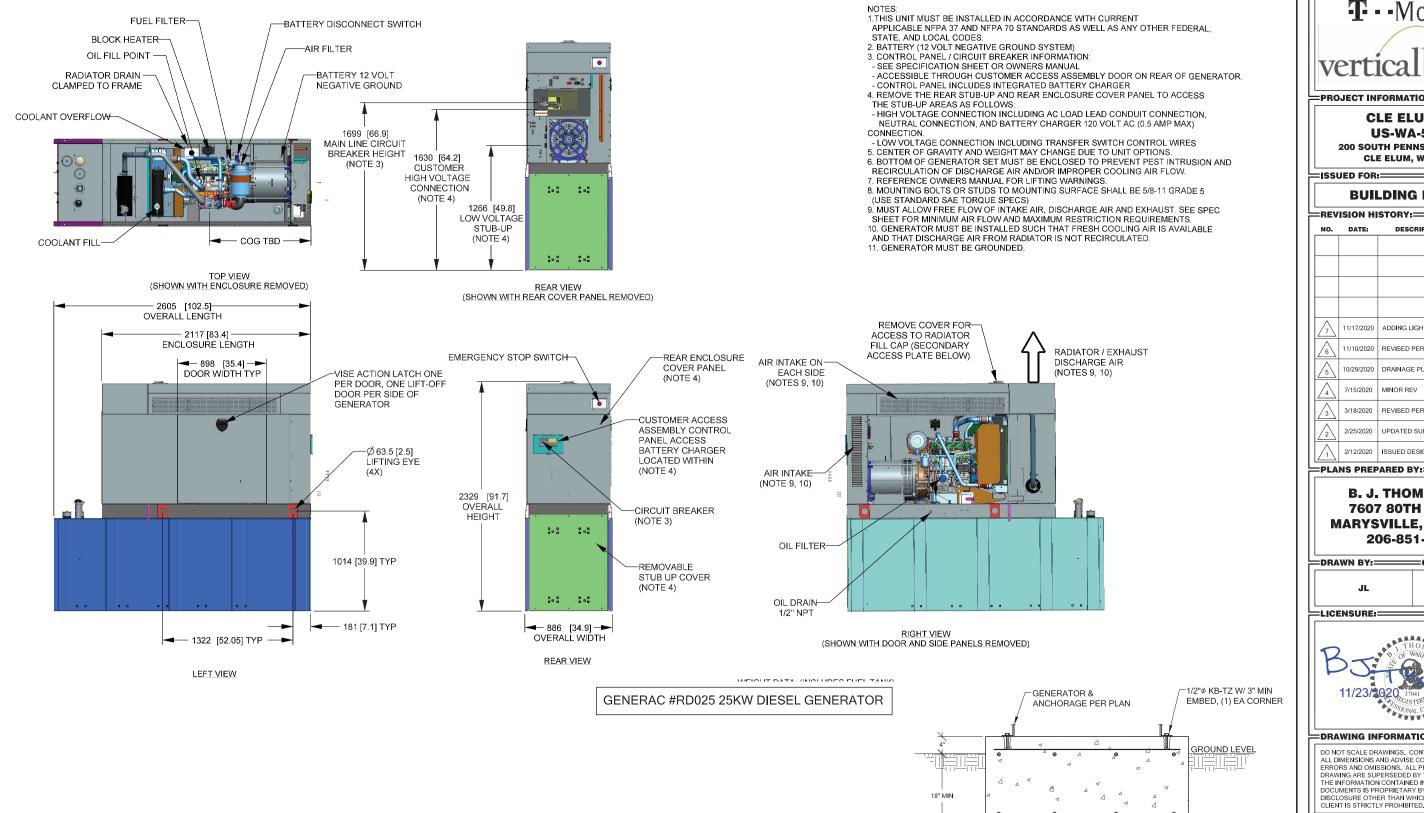

ANCHOR NOTE:

1/2" KWJK BOLT TZ W/ 3" EMBEDMENT AT EACH CORNER. T - Mobile-

=PROJECT INFORMATION:=

CLE ELUM DT US-WA-5105

200 SOUTH PENNSYLVANIA AVE **CLE ELUM, WA 98922**

SSUED FOR:

BUILDING PERMIT

NO.	DATE:	E: DESCRIPTION:			
7	11/17/2020	ADDING LIGHTENING ROD	BJT		
6	11/10/2020	REVISED PER REDLINES	BJT		
5	10/29/2020	DRAINAGE PLAN ADDED	BJT		
4	7/15/2020	MINOR REV	BJT		
3	3/18/2020	REVISED PER REDLINES	BJT		
2	2/25/2020	UPDATED SURVEY ADDED	BJT		
/1	2/12/2020	ISSUED DESIGN REVIEW	BJT		

PLANS PREPARED BY:

B. J. THOMAS, P.E. **7607 80TH AVE NE MARYSVILLE, WA 98270** 206-851-1106

=DRAWN BY:==== — СНК. BY:—





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DRAWING TITLE:

REINF PER PLAN

-#4 REBAR @ 10" O.C.


GENERATOR PAD DETAIL

A-10 SCALE: NTS

TOP & BOTTOM, EA WAY

GENERATOR DETAILS

=DRAWING NUMBER:=====

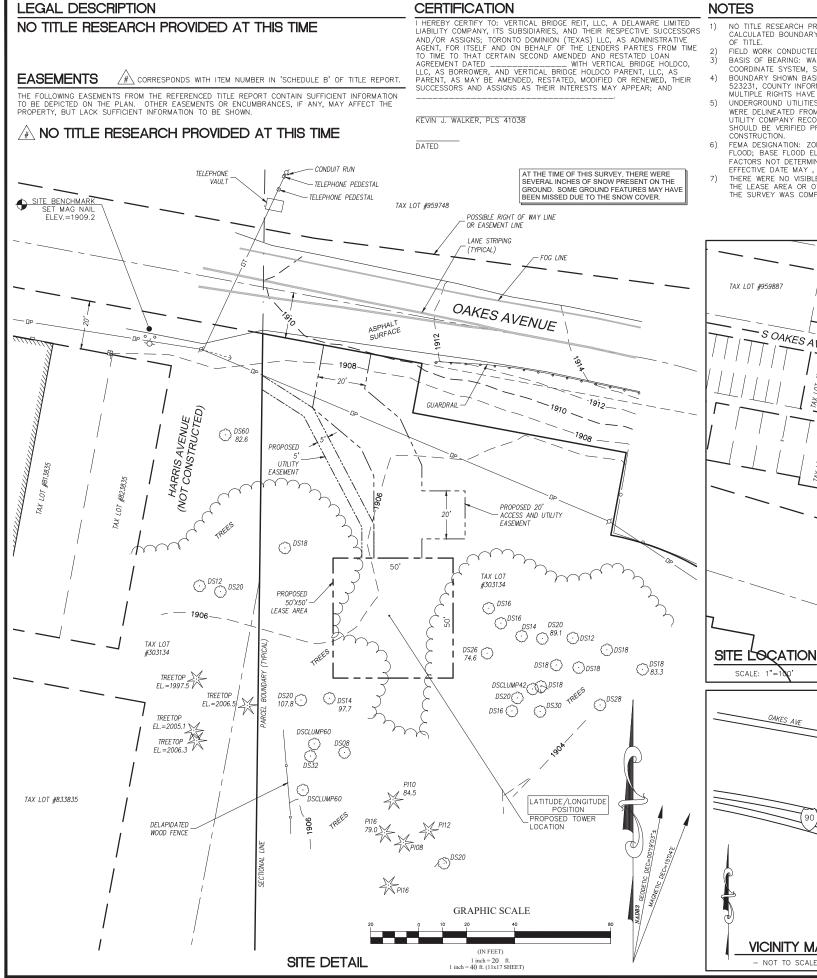

NOTES

- NO TITLE RESEARCH PROVIDED AT THIS TIME. CALCULATED BOUNDARY MAY CHANGE UPON RECEIPT OF TITLE.
- FIELD WORK CONDUCTED IN JANUARY, 2020. BASIS OF BEARING: WASHINGTON STATE PLANE
- COORDINATE SYSTEM, SOUTH ZONE (NAD83).
 BOUNDARY SHOWN BASED ON RECORD OF SURVEY NO. 523231, COUNTY INFORMATION INDICATES POSSIBLE MULTIPLE RIGHTS HAVE THE SAME TAX LOT NUMBER. UNDERGROUND UTILITIES SHOWN HEREON, IF ANY,
- WERE DELINEATED FROM SURFACE EVIDENCE AND/OR UTILITY COMPANY RECORDS. CRITICAL LOCATIONS SHOULD BE VERIFIED PRIOR TO DESIGN AND
- FEMA DESIGNATION: ZONE A (AREAS OF 100—YEAR FLOOD; BASE FLOOD ELEVATIONS AND FLOOD HAZARD FACTORS NOT DETERMINED) PANEL 5300960001B, EFFECTIVE DATE MAY, 1981. THERE WERE NO VISIBLE ENCROACHMENTS AFFECTING THE LEASE AREA OR OTHER EASEMENTS AT THE TIME
- THE SURVEY WAS COMPLETED.

-SOAKESAVE -

SCALE: 1"=

VICINITY MAP

- NOT TO SCALE

PARENT PARCEL

TAX LOT #303134

SOAKESAVE

WHISPERING PINES DR

INTERSTATE HWY 90

SITE

LATITUDE/LONGITUDE POSITION

NAVD 88

COORDINATE DATA AT PROPOSED TOWER LOCATION NAD 83

47*11'32.69" N LONG - 120*56'12.53" W

ELEV.= 1905.6 FEET 47.192414* N BENCHMARK IS BASED ON LONG - 120.936814° W WSRN REFERENCE NETWORK

> ELEVATION DERIVED USING GPS. ACCURACY MEETS OR EXCEEDS 1A STANDARDS AS DEFINED ON THE FAA ASAC INFORMATION SHEET 91:003.



TAX LOT #618936

LATITUDE/LONGITUDE POSITION

PROPOSED TOWER

LEGEND - SUBJECT BOUNDARY LINE - RIGHT-OF-WAY CENTERLINE - RIGHT-OF-WAY LINE - ADJACENT BOUNDARY LINE ---- SECTIONAL BREAKDOWN LINE OVERHEAD POWER LINE BURIED POWER LINE - BURIED GAS LINE OVERHEAD TELEPHONE LINE BURIED TELEPHONE LINE BURIED WATER LINE - BURIED SANITARY SEWER - BURIED STORM DRAIN - · · - DITCH LINE/FLOW LINE ROCK RETAINING WALL

VEGETATION LINE CHAIN LINK FENCE WOOD FENCE BARBED WIRE/WIRE FENCE Δ TRANSFORMER -Q- FIRE HYDRANT X LIGHT STANDARD M GATE VALVE P POWER VAULT WATER METER FIRE STAND PIPE

☑ UTILITY BOX Q UTILITY POLE IRRIGATION CONTROL Ø CV ← POLE GUY WIRE ☐ CATCH BASIN, TYPE 101 GAS VALVE CATCH BASIN, TYPE O GAS METER

1 TEL. MANHOLE □ MAIL BOX .234.21 SPOT ELEVATION TELEPHONE RISER 1) ALL FLEVATIONS SHOWN ARE ABOVE MEAN SEA LEVEL

BOLLARD

(AMSL) AND ARE REFERENCED TO THE NAVD88 DATUM 2) ALL TOWER, TREE AND APPURTENANCE HEIGHTS ARE ABOVE GROUND LEVEL (AGL) AND ARE ACCURATE TO \$\frac{1}{2}\$. 5. FEET OR \$\pm\$ 1% OF TOTAL HEIGHT, WHICHEVER IS GREATER.

TREE LEGEND

T TELEPHONE VAULT

DECIDUOUS TREE AL=ALDER MP=MAPLE DS=DECIDUOUS MA=MADRONA TRUNK DIAMETER (IN) OK=OAK CH=CHERRY

EVERGREEN TREE CF=CFDAR DF=DOUGLAS FIR HE=HEMLOCK PI=PINE EVG=EVERGREEN

HEIGHT AGL IF MEASURED

TREE DRIP LINES ARE NOT TO SCALE. TREE SYMBOLS REFERENCE TRUNK LOCATION ONLY. TRUNK DIAMETERS WERE APPROXIMATED AT 3.5' TO 4' ABOVE GROUND LEVEL. TREES SHOWN ARE FOR REFERENCE ONLY AND OTHER TREES AND VEGETATION MAY EXIST.

SITE INFORMATION

303134 MAP #20-15-26034-0002 TAX LOT NUMBER

SITE CONTACT HONE NUMBER ZONING

67 SERVICES GOVERNMENTAL (CITY OF CLE ELUM) TO BE DETERMINED 2500 S.F.

TOTAL LOT AREA

SURVEY REFERENCE

- RECORD OF SURVEY PER A.F. NO. 523231 RECORDS OF KITTITAS COUNTY.
- RECORD OF SURVEY PER A.F. NO. 200412170002. RECORDS OF KITTITAS COUNTY

BOUNDARY DISCLAIMER

THIS PLAN DOES NOT REPRESENT A BOUNDARY SURVEY. SUBJECT AND ADJACENT PROPERTY LINES. ARE DEPICTED USING FIELD—FOUND EVIDENCE AND RECORD INFORMATION.

CAUTION!

UNDERGROUND UTILITIES EXIST IN THE AREA AND UTILITY INFORMATION SHOWN MAY BE INCOMPLETE ONE—CALL UTILITY LOCATE SERVICE AT LEAST 48
HOURS BEFORE STARTING ANY CONSTRUCTION.

1-800-424-5555

verticalbridge ERTICAL BRIDGE HOLDINGS, LLC 750 PARK OF COMMERCE DRIVE. BOCA RATON, FL 33487 SURVEY PREPARED BY DUNCANSON Company, Inc. 145 SW 155th Street, Suite 102 Seattle, Washington 98166 Phone 206.244.4141 Fax 206.244.4455

IB.J. THOMAS. PEI

SURVEY PREPARED FOR:

CLE ELUM DT US-WA-5105

S 1/2 S 26 T20N R15F WM CLE ELUM, WA 98922 KITTITAS COUNTY

THIS DRAWING WAS CREATED FOR THE CXCLUSING USE OF THE CLIENT NAMED HERIOT AND IS NOT TO BE USED IN HOLLE OR IN PROM WITHOUT WRITTEN AUTHORIZATION FROM SAID CLIENT. © 2018, DUNCANSON COMPANY, INC.

LD. CREW CR/C LD. BOOK 543/98 DRAWN RY LAC 01808 163 JOB #:


02/03/2

DATE:

RI	EVISIONS	
DATE	DESCRIPTION	BY
2/24/20	ADD LEASE AND ACCESS UTILITY EASEMENTS	KJW
	Sammar	



SHEET NUMBER SV₁

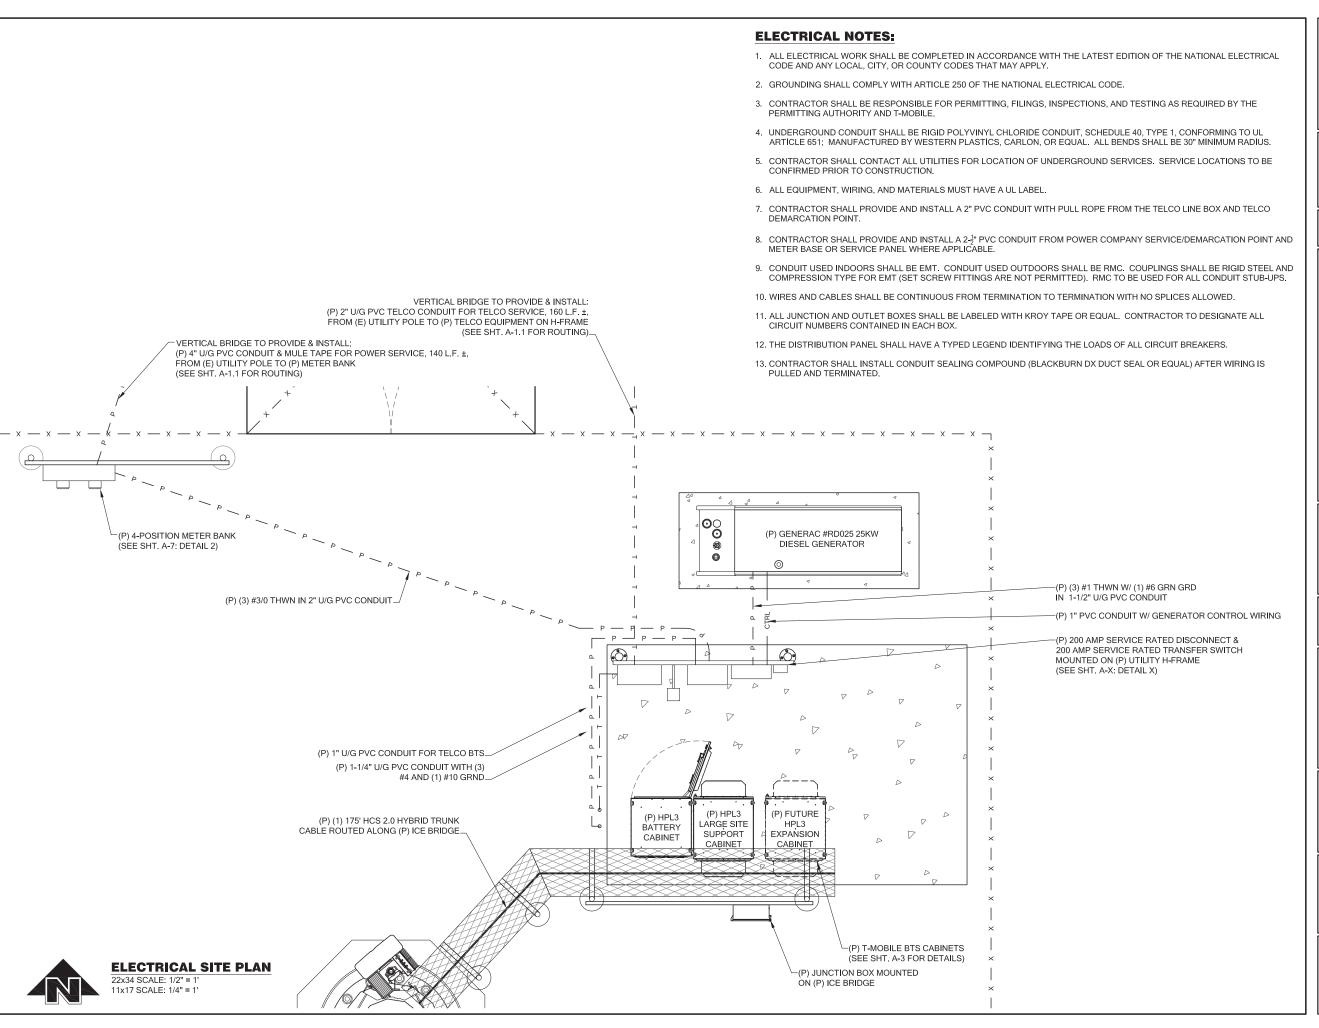



==PROJECT INFORMATION:==

CLE ELUM DT US-WA-5105

200 SOUTH PENNSYLVANIA AVE CLE ELUM, WA 98922

=ISSUED FOR:=

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/1\	2/12/2020	ISSUED DESIGN REVIEW	BJT

PLANS PREPARED BY:

B. J. THOMAS, P.E. 7607 80TH AVE NE MARYSVILLE, WA 98270 206-851-1106

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=LICENSURE:=




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==DRAWING TITLE:====

ELECTRICAL SITE PLAN






LOAD CALCS:

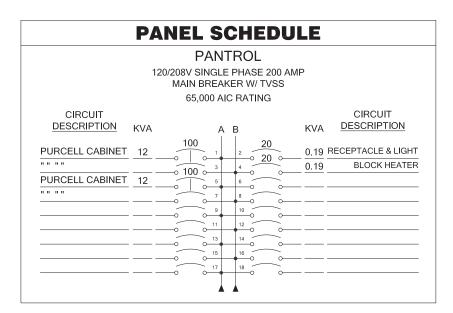(5) 3 KW RECTIFIERS = 15 KVA

RECEPTACLE & LIGHT = 0.19 KVA

BLOCK HEATER = 0.19 KVA

TOTAL 15.38 KVA
64 AMPS

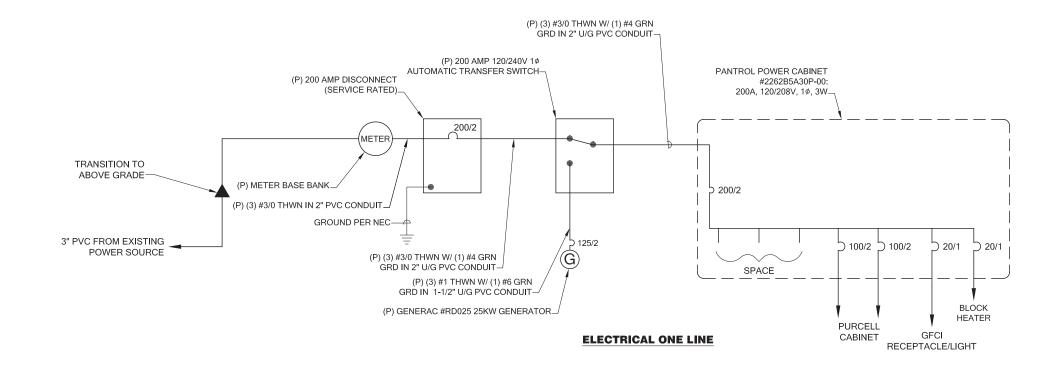



PROJECT INFORMATION:

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\bigwedge	2/12/2020	ISSUED DESIGN REVIEW	ВЈТ		

PLANS PREPARED BY:

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LICENSURE:



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DRAWING TITLE:

ELECTRICAL DETAILS

DRAWING NUMBER:

E-1.1

BOND GATE POST TO (P) SITE GROUND RING. BOND GATE POST TO GATE. BOND H-FRAME POSTS AND MOUNTED (P) GROUND INSPECTION WELL EQUIPMENT TO (P) GROUND RING-(P) MECHANICAL CONNECTION (TYP) (SEE GROUNDING NOTES #4 & #6) BOND H-FRAME POSTS AND MOUNTED EQUIPMENT TO (P) GROUND RING-(P) GROUND INSPECTION WELL (SEE SHT. E-3, DETAIL 4). (P) #2 SOLID BARE TINNED COPPER WIRE (SITE GROUND RING). BOND BTS EQUIPMENT TO (P) MGB W/ #2 GREEN STRANDED THWN (TYP) (SEE SHT. E-4, DETAIL 5) (P) AGB AT TOP OF POLE DIRECTLY BELOW ANTENNA ARRAY (SEE GROUNDING NOTE #5)_ BOND (P) MGB AT BOTTOM OF POLE TO (P) MGB NEAR BTS EQUIPMENT (P) MGB AT BOTTOM OF POLE (SEE GROUNDING NOTE #5) BOND (P) AGB TO (P) MGB (P) #2 SOLID BARE TINNED COPPER (POLE GROUND RING). (P) GROUND RODS (TYP OF 3) AROUND (P) POLE GROUND RING-BOND (4) CORNER FENCE POST (P) CADWELD BOND (TYP) TO (P) SITE GROUNDING (SEE GROUNDING NOTE #4) (SEE SHT. E-3 FOR ADDITIONAL INFORMATION)

SYMBOL LEGEND:

MGB
MASTER GROUND BAR 1/4"x4"x24"
COPPER

AGB ACCESSORY GROUND BAR 1/4"x4"x12" OR 1/4"x4"x20" COPPER

EXPOSED WIRING
---- UNDERGROUND WIRING

■ CADWELD

MECHANICAL CONNECTION

5/8"x8' COPPER CLAD STEEL GROUND ROD

INSPECTION POR

■ - EXOTHERMIC (CADWELD) BELOW GROUND

 \perp GROUND

BOND FROM (P) GENERATOR TO (P) MGB

(P) MGB NEAR BTS EQUIPMENT MOUNTED TO ICEBRIDGE (SEE GROUNDING NOTE #5)

BOND (P) MGB TO (P) SITE GROUND RING

GROUNDING NOTES:

- GROUNDING SHALL COMPLY WITH LATEST EDITION OF THE NATIONAL ELECTRICAL CODE.
- 2. MINIMUM BENDING RADIUS FOR GROUND CONDUCTOR IS 8".
- 3. NO SPLICES PERMITTED IN GROUND CONDUCTORS.
- ALL GROUNDING CONNECTORS TO BE CLEAN AND FREE OF PAINT AT THEIR MATING SURFACES AND INSTALLED PER MANUFACTURER'S RECOMMENDATIONS. USE PENETROX OR EQUIVALENT ANTIOXIDANT GREASE.
- 5. ALL GROUND BAR CONNECTIONS ARE TO BE 2 HOLE LUG COMPRESSION TYPE. STACKED CONNECTIONS ARE NOT ACCEPTABLE. BACK TO BACK CONNECTIONS ON OPPOSITE SIDES OF THE GROUND BAR WILL BE PERMITTED.
- 6. ENSURE ALL MECHANICAL CONNECTORS ARE TORQUED TO THE MANUFACTURER'S SPECIFIED VALUES.
- 7. MULTIPLE BONDS ON GROUND RODS TO BE SEPARATED BY ATLEAST 6".
- 8. MAXIMUM RESISTANCE OF THE COMPLETED GROUND SYSTEM SHALL NOT EXCEED A RESISTANCE OF 5 OHMS TO EARTH.
- 9. GROUND WIRES SHALL NOT BE INSTALLED THROUGH HOLES IN ANY METAL OBJECTS OR SUPPORTS; TO PRECLUDE ESTABLISHING A "CHOKE" POINT
- 10. GROUND BARS SHALL NOT BE FIELD MODIFIED.
- 11. GROUND RING BURIAL DEPTH SHALL BE 30".
- 12. A CERTIFIED CONTRACTOR WILL MAKE ALL MEASUREMENTS
 REQUIRED TO TEST THE GROUNDING SYSTEM USING A MEGGER OR
 EQUIVALENT. THE ACCEPTABLE RESISTANCE MEASURED FOR THE
 GROUNDING SYSTEM WILL NOT EXCEED 5 OHMS RESISTANCE.
 THREE DISTANCES SHALL BE USED: 1 AT 100 FEET, 1 AT 70 FEET,
 AND 1 AT 35 FEET. THESE DISTANCES ARE SUBJECT TO A SITE BY
 SITE BASIS. T-MOBILE-WTS SHALL BE GIVEN 24 HOURS NOTICE. ALL
 COSTS ASSOCIATED WITH GROUND TESTING WILL BE AT THE
 EXPENSE OF THE CONTRACTOR.



PROJECT INFORMATION:=

CLE ELUM DT US-WA-5105

200 SOUTH PENNSYLVANIA AVE CLE ELUM, WA 98922

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	101014 111	STORY:	снк.
NO.	DATE:	DESCRIPTION:	BY:
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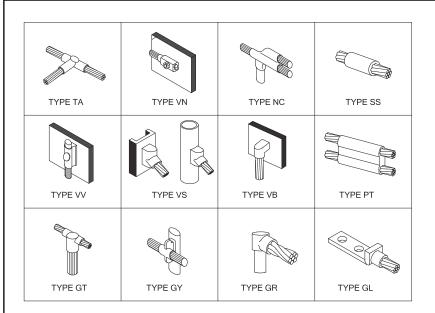
ELECTRICAL GROUNDING PLAN

=DRAWING NUMBER:====


E-2

1 ELECTRICAL GROUNDING PLAN


22x34 SCALE: 1/2" = 1' 11x17 SCALE: 1/4" = 1'



1 TYPICAL CADWELD CONNECTIONS E-3 N.T.S.

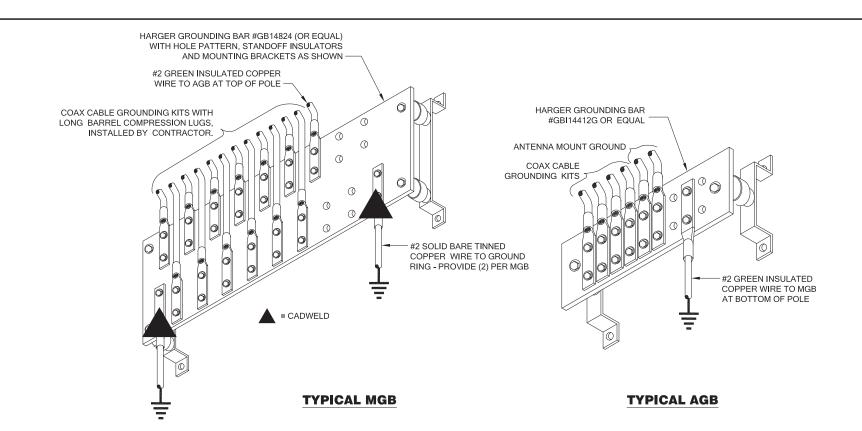



GROUND BAR DETAILSN.T.S.

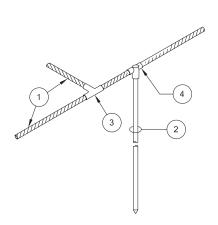

- 1 MAIN CONDUCTOR, COPPER CABLE
- 2 5/8"x8' COPPER CLAD STEEL GROUND ROD
- 3 CADWELD TYPE "TA"
- 4 CADWELD TYPE "GT"

GROUND ROD CONNECTION N.T.S.

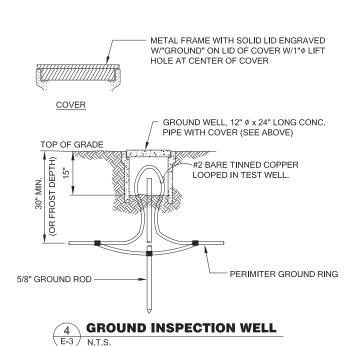

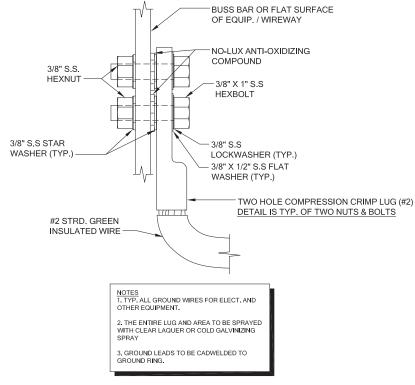

TYPICAL CABINET GROUNDING DETAIL

8. N.T.S.

T - Mobile-

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$\frac{2}{\sqrt{2}}$	7/15/2020	MINOR REV	BJT
<u>/4\</u>	//15/2020	MINOR REV	BJI
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DRAWN BY: CHK. BY:

=LICENSURE:=



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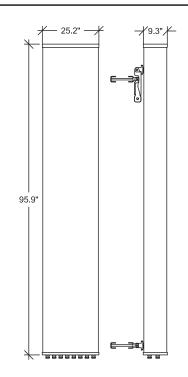
ELECTRICAL GROUNDING DETAILS

DRAWING NUMBER:

E-3

SITE LOADING CHART

SECTOR	COLOR	ANTENNA MODEL #	VENDOR	AZIMUTH (TN)	MECHANICAL DOWNTILT	ELECTRICAL DOWNTILT	RADIATION CENTER	HYBRID CABLE LENGTH	COAX CABLES
ALPHA	RED	FFHH-65C-R3	COMMSCOPE	120°	0°	TBD	156'-0" AGL		
BETA	GREEN	FFHH-65C-R3	COMMSCOPE	250°	0°	TBD	156'-0" AGL	(1) 175' HCS 2.0 HYBRID TRUNK CABLE	N/A
GAMMA	BLUE	FFHH-65C-R3	COMMSCOPE	320°	0°	TBD	156'-0" AGL		



COMMSCOPE ANTENNA DATA								
MECHANICAL SPECIFICATIONS								
PART NUMBER HEIGHT WIDTH DEPTH WEIGHT								
FFHH-65C-R3		95.9 in		25.2 in	9.3 in		127	7.6 lbs
CONNECTORS	CONNECTORS STANDARD MOUNTING HARDWARE							
(8) 7-16 DIN	INCLUDED							
ELECTRICAL	SPECIF	ICATION	IS					
FREQUENCY	POLAR	RIZATION	GΑ	IN	AZIMU'	ТН В	.W.	
617-2360 MHz	±45° 15.8-19.6 dBi 55°- 67°							
VSWR MAX INPUT POWER ELEVATION B.W.						<i>l</i> .		
	<1.5:1 300 WATTS 4.4° - 10.2°							

T -- Mobile-

PROJECT INFORMATION:

CLE ELUM DT US-WA-5105

200 SOUTH PENNSYLVANIA AVE CLE ELUM, WA 98922

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DRAWN BY: CHK. BY:

LICENSURE:



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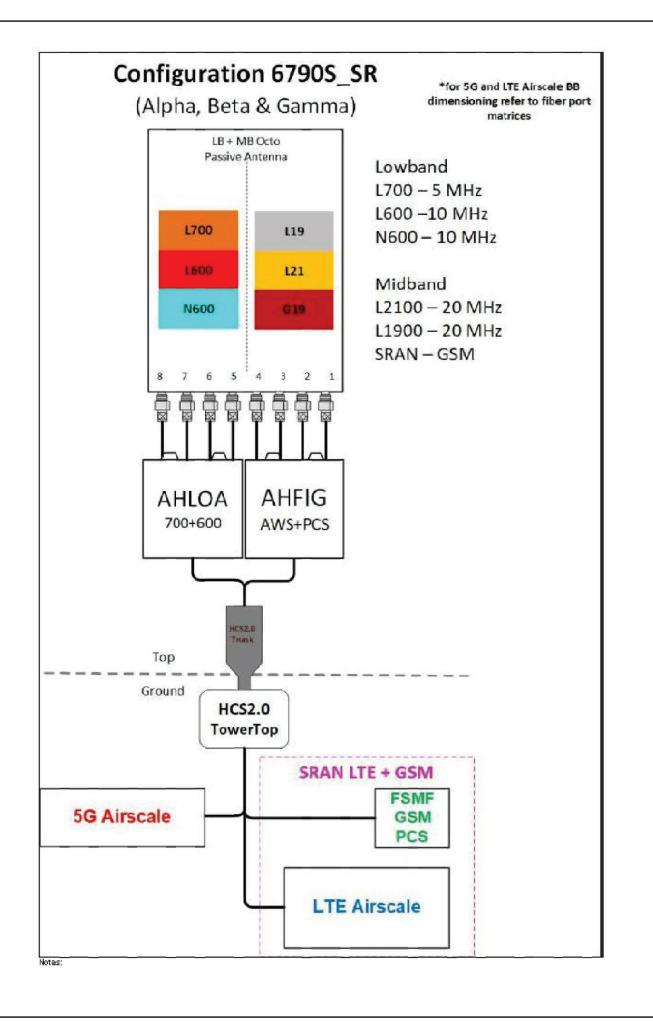
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DRAWING TITLE:

RF DETAILS

DRAWING NUMBER:

RF-1



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RF DETAILS

DRAWING NUMBER:

RF-2

SECTION 26, TOWNSHIP 20 N, RANGE 15E TELEPHONE PEDESTA OAKES AVENUE GRAPHIC SCALE SCALE IN FEET UTILITY POLE TO BE-USED FOR T-MOBILE POWER & TELCO SERVICE POINT 4" U/G PVC POWER -CONDUIT ROUTED FROM UTILITY POLE TO METER BANK 12' WIDE GRAVEL ACCESS W/TRANSITION ZONE PER DETAIL. CROSS SLOPE FINAL GRADE TO PROVIDE 2" U/G PVC TELCO CONDUIT NOTES: REFER TO ARCHITECTURAL PLANS ROUTED FROM UTILITY POLE TO TELCO EQUIPMENT ON FOR LEASE/EASEMENT AREAS & POSITIVE SLOPE T-MOBILE 20' X 20' LEASED CELLULAR COMMUNICATIONS EQUIPMENT COMPOUND PER ARCHITECTURAL PLANS S=2% & DETAILS. CONSTRUCT 2' LIMITS OF-WIDE GRAVEL TRANSITION DISTURBANCE PAD ALONG EAST AND -160' AGL STEEL MONOPOLE W/T-MOBILE ANTENNAS AT TOP (SEE ARCHITECTURAL PLANS). GROUND EL. 1905.6 AMSL TAX LOT #303134 SILT FENCE IF-NECESSAR' NATIVE BRUSH TRANSITION ZONE DETAIL DELAPIDATED WOOD FENCE EX. GRADE NOTE: THE INTENT IS TO CONSTRUCT THE GRAVEL ACCESS & CELL COMPOUND SURFACING WITHOUT ANY INCREASE/CHANGE IN EXISTING GRADE. ALL EARTHWORK CUT/SPOILS TO BE REMOVED FROM THE PROPERTY. ACCESS DRIVEWAY & CELL COMPOUND SECTION N.T.S. SILT FENCE MAINTENANCE STANDARDS 1. ANY DAMAGE SHALL BE REPAIRED IMMEDIATELY. IF CONCENTRATED FLOWS ARE EVIDENT UPHILL OF THE FENCE, THEY MUST BE INTERCEPTED & CONVEYED TO A SEDIMENT TRAP OR POND. FILTER FABR 3. IT IS IMPORTANT TO CHECK THE UPHILL SIDE OF THE FENCE FOR SIGNS OF THE FENCE CLOSGING & ACTING AS A BARRIER TO FLOW & HENC ACSING CHANNELIZATION OF FLOWS PRAGLILE! TO THE FENCE. IF THIS OCCURS, REPLACE THE FENCE OR REMOVE THE TRAPPED SEDIMENT. 4. SEDIMENT MUST BE REMOVED WHEN THE SEDIMENT IS 6 INCHES BACKFILL TRENCH WITH NATIVE SOIL OR 3/4"-1.5" WASHED GRAVEL. 1-800-424-5555 SILT FENCE DETAIL 5. IF THE FILTER FABRIC (GEOTEXTILE) HAS DETERIORATED DUE TO ULTRAVIOLET BREAKDOWN, IT SHALL BE REPLACED. (ID,MT,ND,OR,WA)

PROJECT SCOPE

THE PROJECT SCOPE

THE PROJECT CONSISTS OF THE COSTRUCTION OF AN UNSTAFFED TELECOMMUNICATIONS FACILITY CONSISTING OF BTS EQUIPMENT LOCATED IN 50' x 50' CHAIN LINKED FENCED COMPOUND ON PRIVATE PROPERTY WITH ANTENNAS LOCATED ON A NEW 160' AGG STEEL MONOPOLE (PER ARCHITECTURAL PLANS AND DETAILS). OCCASIONAL AND INFREQUENT ACCESS TO THE SITE (TECHNICIAN SITE VISIT EXPECTED TO BE 1-2 TIMES PER MONTH) WILL BE FROM EXISTING PAVED ROAD. LITTLE SITE IMPACT IS ANTICIPATED AND THEREFORE MINIMAL T.E.S.C. MEASURES ARE REQUIRED. PROJECT CONTRACTOR SHALL EVALUATE SITE CONDITIONS AS WEATHER CHANCES OCCUR AND THE PROJECT PROGRESSES TO COMPLETION. COMPLETE FAMILIARTY WITH THE NOTES CONTAINED IN THIS PLAN SET IS REQUIRED PRIOR TO BEGINNING WORK. IT IS ANTICIPATED THAT THE MINIMAL DEVELOPED DRAINAGE THAT RESULTS FROM THE PROJECT WILL SAFELY SHEET FLOW AND DISPERSE INTO THE VEGETATION THAT SURROUND THE PROJECT SITE. NO IMPACT ON EXISTING CONDITIONS OR ADVERSE AFFECTS TO THE LOCAL SOIL AND/OR SURFACE WATER CONDITIONS IS ANTICIPATED. ALL EARTHWORK SPOILS SHALL BE REMOVED FROM THE SITE. ABSOLUTELY NO FILL OR CHANGES TO THE EXISTING GRADE IS ALLOWED ON THE SITE.

CONSTRUCTION SEQUENCE

1. ARRANGE & ATTEND A PRECONSTRUCTION MEETING WITH CITY OF CLE ELUM SITE INSPECTOR.

- 2. FLAG OR FENCE CLEARING LIMITS.
- 3. CALL ONE-CALL UTILITY LOCATE SERVICE PRIOR TO ANY EXCAVATION WORK.
- 4. CONSTRUCT ROCK CONSTRUCTION ENTRANCE, IF NECESSARY, NOT ANTICIPATED.
- 5. INSTALL PERIMETER PROTECTION (SILT FENCE, BRUSH BARRIER, ETC.) WHEN, & IF, NECESSARY.

6. MAINTAIN EROSION CONTROL MEASURES IN ACCORDANCE WITH KING COUNTY STANDARDS & MANUFACTURER'S RECOMMENDATIONS.

7. MAINTAIN ACCESS TO OFF-SITE ROADS & DRIVEWAYS AT ALL TIMES DURING THE DURATION OF THE PROJECT.

8. RELOCATE EROSION CONTROL MEASURES OR INSTALL NEW MEASURES SO THAT AS SITE CONDITIONS CHANCE THE EROSION & SEDIMENT CONTROL IS ALWAYS IN ACCORDANCE WITH THE KING COUNTY TESC MINIMUM REQUIREMENTS.

- 9. COVER ALL AREAS THAT WILL BE UNWORKED FOR MORE THAN SEVEN DAYS DURING THE DRY SEASON OR TWO DAYS DURING THE WET SEASON WITH STRAW, WOOD FIBER MULCH, COMPOST, PLASTIC SHEETING OR EQUIVALENT. 10. STABILIZE ALL AREAS THAT REACH FINAL GRADE WITHIN SEVEN DAYS.
- 11. SEED OR SOD ANY AREAS TO REMAIN UNWORKED FOR MORE THAN 30 DAYS.
- 12. UPON COMPLETION OF THE PROJECT, ALL DISTURBED AREAS MUST BE STABILIZED & BMPS REMOVED IF APPROPRIATE AFTER ACCEPTANCE BY INSPECTOR.

SITE WORK GENERAL NOTES

2. EXISTINC ACTIVE UTILITIES (I.E. SEWER, WATER, 64S, ELECTRIC, ETC.)

NOODITIES OURINN WORK SHALL BE RETOTED AMBER REQUIRED FOR THE PROPER EXCLUTIONED FOR THE PROPER EXCLUTION FOR THE PROPER EXCLUTION SHOULD BE USED BY THE CONTRACTOR WHEN EXCAVATING OR DRILLING PIERS AROUND OR NEAR UTILITIES. CONTRACTOR WHEN EXCAVATING OR DRILLING PIERS AROUND OR NEAR UTILITIES. CONTRACTOR SHALL PROPINGE SAFETY TRAINING FOR THE WORKING CREW. THIS WILL INCLUDE BUT NOT BE

3. ALL SITE WORK SHALL BE AS INDICATED ON THE DRAWINGS AND STIPULATED IN THE DESIGN AND CONSTRUCTION SPECIFICATIONS.

5. FINISH SITE GRADES SHALL BE SUCH THAT SURFACE WATER FLOWS AWAY FROM THE PCPs EQUIPMENT AND TOWER AREAS.

6. THE SUB GRADE SHALL BE COMPACTED TO A FIRM NON-YIELDING CONDITION AND UNIFORM GRADE PRIOR TO PLACEMENT OF BASE ROCK AND/OR ASPHALT PAVEMENT.

7. EXISTING INACTIVE UTILITIES (SEWER, GAS, WATER, ELECTRIC, ETC.), WHICH INTERFERE WITH THE EXECUTION OF THE WORK, SHALL BE REMOVED AND/OR CAPPED, PLUGGED OR OTHERWISE DISCONTINUED AT POINTS WHICH WILL NOT INTERFERE WITH THE EXECUTION OF THE WORK. ALL UTILITY SANDOMENT SHALL BE SUBJECT TO THE APPROVAL OF ENDINEERING, OWNER AND/OR LOCAL UTILITIES.

8. ALL LANDSCAPE AREAS DISTURBED BY THE CONSTRUCTION WORK SHALL BE RESTORED TO PRE-EXISTING GRADE AND CONDITION. ANY DAMAGED LANDSCAPING PLANTS, TREES, AND/OR SHRUBS SHALL BE REPLACED WITH LIKE KIND AND SIZE.

9. CONTRACTOR SHALL MINIMIZE DISTURBANCE TO THE EXISTING SITE TO THE MAXIMUM EXTENT POSSIBLE DURING CONSTRUCTION. EROSION CONTROL MEASURES, IF REQUIRED, STALL BE IN ACCORDANCE TO THIS PLAN AND ANY AND ALL LOCAL GUIDELINES FOR EROSION BAND SEDIMENT CONTROL.

WET SEASON GRADING NOTES

1. THE CONSTRUCTION SEQUENCE SHALL BE MODIFIED, AS NECESSARY TO MINIMIZE THE AREA OF UNSTABLIZED SOIL. A MAXIMUM OF 1,000 SQUARE—FEET OF SOIL SHALL BE EXPOSED AT ANY TIME.

2. EARTHEN AREAS THAT ARE SUBJECT TO CONTRIBUTING SEDIMENTS DURING STORM EVENTS AND WHERE EARTH MOVEMENT IS NOT ANTICIPATED FOR 48-HOURS SHALL BE STABILIZED A USING GROUND COVER BMP'S TO STABILIZE THE SOIL. USE STRAW MULCH AT A RATE OF 1.5# PER SQUARE FOOT OR 6" DEPTH WHATEVER IS GREATER.

3. WET SEASON TESC MEASURES WILL BE EXPANDED TO INCLUDE THE FOLLOWING A SECOND SILT FENCE 10 FEET INSIDE THE ORIGINAL SILT FENCE.

4. SOILS SHALL NOT BE DISTURBED EXCEPT FOR ACTUAL CONSTRUCTION ACTIVITIES. PARKING IS ALLOWED ON PAVED AND/OR GRAVEL SURFACES ONLY.

5. SLOPES 8% AND GREATER WITHOUT ESTABLISHED GROUNDCOVER WILL BE STABILIZED 3. SUPPLES OF ANY ORGANIER WINDOWN ESTABLISHED ORGANIZATION WILL BE STABLISZED WITH PLASTIC SHEETING, 6 MIL (MINIMUM). THE SHEETING SHALL BE ANCHORED WITH SAND BAGS LOCATED 5' APART ON THE PERIMETER AND 10 FEET ON CENTER ON THE REMAINDER OF THE SHEETING. A MINIMUM OF 2 FEET OVERLAP IS REQUIRED ON ALL OVERLAPPING SHEETS.

7. WHEN RAINFALL IS HEAVY (DEFINED AS RAINFALL HARD ENOUGH TO PRODUCE SEDIMENT RUN-OFF FROM THE EXPOSED DIRT), ALL EXPOSED EARTHWORK SHALL BE COVERED. NO OTHER CONSTRUCTION ACTIVITY SHALL OCCUR ON PERVIOUS SURFACES DURING THESE PERIODS OF HEAVY RAIN.

8. ALL DRAINAGE SWALES SHALL BE FULLY VEGETATED. SWALES SHALL BE SODDED IF THE VEGETATION GROWING IN THE SWALES IS INSUFFICIENT TO PROVIDE WATER QUALITY TREATMENT AND TO PREVENT EROSION OF THE SWALE.

9. FILTER FABRIC (GEOTEXTILE FABRIC) SHALL BE INSTALLED BENEATH THE ENTIRE CONSTRUCTION ENTRANCE



VICINITY MAP

LEGAL DESCRIPTION

PROJECT SITE DATA

SITE NAME: CLE FLUM DT

SITE ADDRESS: 200 SOUTH PENNSYLVANIA AVE, CLE ELUM, WA 98922 TAX ACCOUNT NO: 303134

CONTACT LIST

DEVELOPER: VERTICAL BRIDGE **CONSULTING ENGINEER:** B.J. THOMAS, P.E. PH. (206) 851-1106 CIVIL ENGINEER: LITCHFIELD ENGINEERING PH. (425) 821-5038 DUCANSON COMPANY PH. (206) 244-4141

CENTER OF SITE (PROPOSED MONOPOLE)

COORDINATE DATA AT CENTER OF MONOPOLE LOCATION: LAT - 47' 11' 32.69" N LONG - 120' 56' 12.53" W ELEV.: 1905.6' AMSL

BASE FLOOD ELEVATION = 1904.0 (BASED ON AN EXTRAPOLATION OF FEMA FIRM MAP 530096 0001B DATED MAY 5, 1981)

1. ALL WORK PERTAINING TO THIS PROJECT SHALL BE SUBJECT TO INSPECTION BY THE CITY INSPECTOR OR HIS DESIGNATED REPRESENTATIVE.

2. PRIOR TO BEGINNING CONSTRUCTION, CONTRACTOR SHALL COORDINATE A PRECONSTUCTION CONFERENCE WITH THE CITY INSPECTION UNIT.

SWPPP NOTE - MANAGEMENT OF THE PROJECT

IT WILL BE THE RESPONSIBILITY OF THE CONTRACTOR AND DEVELOPER TO MANAGE THIS PROJECT AND COORDINATE WITH THE CITY INSPECTOR AND ENGINEER.

INSPECTION AND MONITORING;
SITE INSPECTIONS SHALL BE DONE BY A PERSON WHO IS KNOWLEDGEABLE IN THE
PRINCIPLES AND PRACTICES OF EROSION AND SEDIMENT CONTROL. THE PERSON
MUST HAVE SKILLS TO FIRST ASSESS THE SITE CONDITIONS AND CONSTRUCTION
ACTIVITIES THAT COULD IMPACT THE QUALITY OF STORMWATER, AND SECOND ASSESS
THE EFFECTIVENESS OF EROSION AND SEDIMENT CONTROL MEASURES USED TO
CONTROL THE QUALITY OF STORMWATER, DISCHARGES USED TO

WHENEVER INSPECTION AND/OR MONITORING REVEALS THAT THE BMPS IDENTIFIED IN THE CONSTRUCTION SWPPP ARE INADEQUATE, APPROPRIATE BMPS OR DESIGN CHANGES SHALL BE IMPLEMENTED AS SOON AS POSSIBLE.

MAINTAINING AN UPDATED CONSTRUCTION SWPPP:
THE CONSTRUCTION SWPPP SHALL BE RETAINED ON-SITE WHENEVER CONSTRUCTION IS UNDERWAY.

ALTHOUGH NOT ANTICIPATED, THE SWPPP SHALL BE MODIFIED WHENEVER THERE IS A CHANGE IN THE DESIGN, CONSTRUCTION, OPERATION, OR MAINTENANCE AT THE CONSTRUCTION SITE THAT HAS, OR COULD HAVE, A SIGNIFICANT EFFECT ON THE DISCHARGE OF POLLUTANTS TO WATERS OF THE STATE.

THE SWPPP SHALL BE MODIFIED IF, DURING INSPECTIONS OR INVESTIGATIONS THE SWPPP SHALL BE MODIFIED IF, DURING INSPECTIONS OR INVESTIGATIONS CONDUCTED BY THE OWNER/OPERATOR, OR THE APPLICABLE LOCAL OR STATE REGULATORY AUTHORITY, IT IS DETERMINED THAT THE SWPPP IS INTEFFECTIVE IN ELIMINATING OR SIGNIFICANTLY MINIMIZING POLLUTANTS IN STORMWATER DISCHARGES FROM THE SITE. THE SWPPP SHALL BE MODIFIED AS NECESSARY TO INCLUDE ADDITIONAL OR MODIFIED BWFS DESIGNED TO CORRECT PROBLEMS IDENTIFIED. REVISIONS TO THE SWPPP SHALL BE COMPLETED WITHIN SEVEN DAYS FOLLOWING INSPECTION.

NEW IMPERVIOUS AREA

WRELESS COMPOUND: 2,500 SQ. FT. GRAVEL ACCESS: 1,480 SQ. FT. \pm TOTAL: 3,980 SQ. FT. \pm

EARTHWORK QUANTITY ESTIMATE

EARTHWORK FOR COMPOUND & SITE ACCESS QUANTITY ESTIMATE: 73 CY's ± (CUT)

TES:
ALL SPOILS TO BE REMOVED FROM THE SITE.
THE DRIVEWAY AND CELL SITE AREAS TO BE
OVER-EXCAVATED PRIOR TO PLACEMENT OF THE
GRAVEL SURFACING, INTENT: MAINTAIN AND/OR
DECREASE THE EXISTING GRADE WITH NO
INCREASE IN ELEVATION.

PPROVED: CITY OF CLE ELUM Date



NOTES	SUBMITTED TO CLIENT			
DATE	10-28-20			
CHKD BY	KAL			
DWN BY	KAL			

ENGINEERING LITCHFIELD





AE, GRADING, TESC & SWPP PALAR COMMUNICATIONS SITCLE ELUM DT, US-WA-5105 CLE ELUM, WA

SHEET **1** of **1**