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A-9 FENCE DETAILS

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PROJECT: INFILL/ROB/GREENFIELD




200 SOUTH PENNSYLVANIA AVE

SITE NUMBER: US-WA-5105

CLE ELUM, WA 98922

LATITUDE 47° 11' 32.69" N (47.192414) **LONGITUDE 120° 56' 12.53" W (-120.936814) GROUND ELEVATION: 1905.6' AMSL**

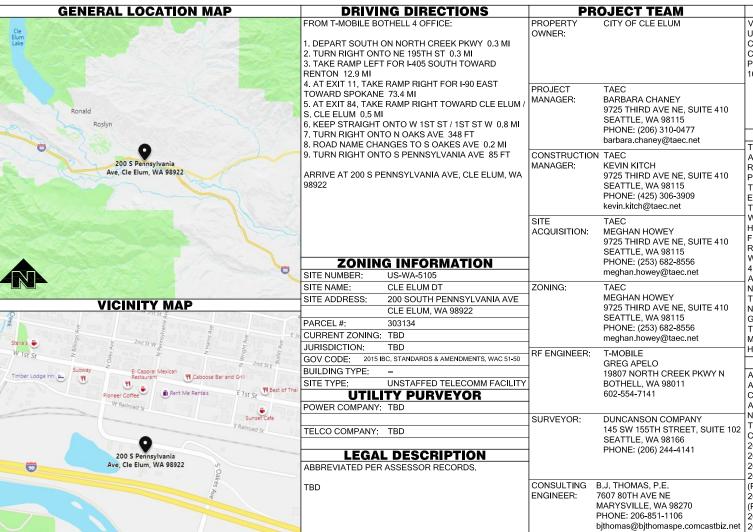

PROJECT DESCRIPTION UNSTAFFED TELECOMMUNICATIONS FACILITY G-1 GENERAL NOTES CONSISTING OF BTS EQUIPMENT LOCATED IN 50' x 50' A-1 OVERALL SITE PLAN CHAIN LINK FENCED COMPOUND ON PRIVATE A-1.1 SITE PLAN PROPERTY WITH ANTENNAS LOCATED ON A NEW A-1 2 FNLARGED SITE PLAN 160' AGL STEEL MONOPOLE. A-2 SITE ELEVATION A-3 BTS EQUIPMENT DETAILS

PROJECT INFORMATION

THIS IS UNSTAFFED AND RESTRICTED EQUIPMENT AND WILL BE USED FOR THE TRANSMISSION OF RADIO SIGNALS FOR THE PURPOSE OF PROVIDING PUBLIC CELLULAR SERVICE. T-MOBILE CERTIFIES THAT THIS TELEPHONE EQUIPMENT FACILITY WILL BE SERVICED ONLY BY

T-MOBILE EMPLOYEES AND THE WORK ASSOCIATED WITH ANY EQUIPMENT CANNOT BE PERFORMED BY HANDICAPPED PERSONS. THIS FACILITY WILL BE FREQUENTED ONLY BY SERVICE PERSONNEL FOR REPAIR PURPOSES. PURSUANT TO THE AMERICANS WITH DISABILITIES ACT (ADA). APPENDIX B SECTION 4.11. (5)(b), THIS FACILITY IS EXEMPT FROM THAT

NO POTABLE WATER SUPPLY IS TO BE PROVIDED AT THIS LOCATION.

NO WASTE WATER OR SOLID WASTE WILL BE GENERATED AT THIS LOCATION.

T-MOBILE MAINTENANCE CREW (ONE PERSON) WILL MAKE AN AVERAGE OF ONE TRIP PER MONTH AT ONE

CODE COMPLIANCE

ALL WORK AND MATERIALS SHALL BE PERFORMED AND INSTALLED IN ACCORDANCE WITH THE CURRENT EDITIONS OF THE FOLLOWING CODES AS ADOPTED BY THE LOCAL GOVERNING AUTHORITIES. NOTHING ON THESE PLANS IS TO BE CONSTRUCTED TO PERMIT WORK NOT CONFORMING TO THESE

2015 IBC, STANDARDS & AMENDMENTS, WAC 51-50 2015 IMC, STANDARDS & AMENDMENTS, WAC 51-52 2015 IEC STANDARDS & AMENDMENTS, WAC 51-54 2015 NEPA 54 - NATIONAL FUEL GAS CODE (PROPANE INSTALLATIONS ONLY) 2014 NFPA 58 - LIQUEFIED PETROLEUM GAS CODE

(PROPANE INSTALLATIONS ONLY) 2015 INTERNATIONAL FIRE CODE 2015 UPC, STANDARDS & AMENDMENTS, WAC 51-56,

2017 NATIONAL ELECTRICAL CODE 2012 NATIONAL ELECTRIC SAFETY CODE LOCAL BUILDING CODE ORDINANCES ANSI / TIA / EIA - 222 - G NFPA-101 - LIFE SAFETY CODE

APPROVAL/SIGN OFF OF CONST DRAWINGS

REVIEWERS SHALL CLEARLY PLACE INITIALS ADJACENT TO EACH REDLINE NOTE AS DRAWINGS ARE BEING REVIEWED.

.	CONSULTANT GROUP SIGN OFF				
כ	LANDLO	RD'S REPR	ESENTATIVE:	DATE:	
	CONSTR	RUCTION MA	ANAGER:	DATE:	
	CONSTR	RUCTION P	ROJECT MANAGER:	DATE:	
	PROJEC	T MANAGE	R:	DATE:	
	SITE AC	QUISITION:		DATE:	
	ZONING	:		DATE:	
	RF ENG	INEER:		DATE:	
			CALL T	WO WORKING DAYS BEFORE YOU DIG	

NATIONAL UTILITIES UNDERGROUND LOCATE ELECTRIC - RED TEL/CATV - ORANGE CONTRACTOR(S) AT ALL
RENCHING IN ACCORDANCE
WITH CURRENT OSHA
STANDARDS SEWER - GREEN PROPOSED - WHITE GAS/OIL - YELLOW WATER - BLUE SURVEY - PINK



=PROJECT INFORMATION:

CLE ELUM DT US-WA-5105

200 SOUTH PENNSYLVANIA AVE **CLE ELUM, WA 98922**

ISSUED FOR:

□REVISION HISTORY:=

BUILDING PERMIT

NO.	DATE:	DESCRIPTION:	CHK. BY:	
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3	3/18/2020	REVISED PER REDLINES	ВЈТ	
2	2/25/2020	UPDATED SURVEY ADDED	ВЈТ	
1	2/12/2020	ISSUED DESIGN REVIEW	ВЈТ	

=PLANS PREPARED BY:=

B. J. THOMAS, P.E. **7607 80TH AVE NE MARYSVILLE, WA 98270** 206-851-1106

DRAWN BY: —СНК. BY:—

=LICENSURE:=



=DRAWING INFORMATION:=

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DRAWING TITLE:

TITLE SHEET

GENERAL NOTES:

- 1. DRAWINGS ARE NOT TO BE SCALED, WRITTEN DIMENSIONS TAKE PRECEDENCE, THIS SET OF DOCUMENTS IS INTENDED TO BE USED FOR DIAGRAMMATIC PURPOSED ONLY. UNLESS NOTED OTHERWISE. THE GENERAL CONTRACTOR'S SCOPE OF WORK SHALL INCLUDE FURNISHING ALL MATERIALS, EQUIPMENT, LABOR AND ANY REQUIREMENTS DEEMED NECESSARY TO COMPLETE INSTALLATION AS DESCRIBED IN THE DRAWINGS AND OWNER'S PROJECT MANUAL
- 2. THE CONTRACTOR IS RESPONSIBLE FOR ALL DIMENSIONS AND STANDARDIZED DETAILS THAT REQUIRE MODIFICATIONS DUE TO ACTUAL FIELD CONDITIONS AND REQUIREMENTS MUST BE SUBMITTED TO AND APPROVED BY, T-MOBILE WIRELESS REPRESENTATIVE PRIOR TO START OF WORK
- 3. PRIOR TO THE SUBMISSION OF BIDS, CONTRACTORS INVOLVED SHALL VISIT THE JOB SITE TO FAMILIARIZE THEMSELVES WITH ALL CONDITIONS AFFECTING THE PROPOSED PROJECT. CONTRACTORS SHALL VISIT THE CONSTRUCTION SITE WITH THE CONSTRUCTION/CONTRACT DOCUMENTS TO VERIEV FIELD CONDITIONS AND CONFIRM THAT THE PROJECT WILL BE ACCOMPLISHED. AS SHOWN PRIOR TO PROCEEDING WITH CONSTRUCTION ANY ERRORS OMISSIONS OR DISCREPANCIES SHALL BE BROUGHT TO THE ATTENTION OF THE ARCHITECT/ENGINEER VERBALLY AND IN WRITING.
- 4. THE GENERAL CONTRACTOR SHALL RECEIVE WRITTEN AUTHORIZATION TO PROCEED WITH CONSTRUCTION PRIOR TO STARTING WORK ON ANY ITEM NOT CLEARLY DEFINED BY THE CONSTRUCTION DRAWINGS/CONTRACT DOCUMENTS.
- 5. THE CONTRACTOR SHALL SUPERVISE AND DIRECT THE PROJECT DESCRIBED IN THE CONTRACT DOCUMENTS. THE CONTRACTOR SHALL BE SOLELY RESPONSIBLE FOR ALL CONSTRUCTION MEANS, METHODS, TECHNIQUES, SEQUENCES, SAFETY, AND PROCEDURES FOR COORDINATING ALL PORTIONS OF THE WORK UNDER THE CONTRACT
- 6. THE CONTRACTOR SHALL INSTALL ALL EQUIPMENT AND MATERIALS ACCORDING TO MANUFACTURER'S/VENDOR'S SPECIFICATIONS UNLESS NOTED OTHERWISE OR WHERE LOCAL CODES OR ORDINANCES TAKE PRECEDENCE
- 7. ALL WORK PERFORMED ON THE PROJECT AND MATERIALS INSTALLED SHALL BE IN STRICT ACCORDANCE WITH ALL APPLICABLE CODES, REGULATIONS, AND ORDINANCES. CONTRACTOR SHALL GIVE ALL NOTICES AND COMPLY WITH ALL LAWS, ORDINANCES, RULES, REGULATIONS AND LAWFUL ORDERS OF ANY PUBLIC AUTHORITY, MUNICIPAL AND UTILITY COMPANY SPECIFICATIONS, AND LOCAL AND STATE JURISDICTIONAL CODES BEARING ON THE PERFORMANCE OF THE WORK.
- 8. GENERAL CONTRACTOR SHALL PROVIDE, AT THE PROJECT SITE, A FULL SET OF CONSTRUCTION DOCUMENTS UPDATED WITH THE LATEST REVISIONS INVOLVED WITH THE PROJECT. THIS SET IS A VALID CONTRACT DOCUMENT ONLY IF THE TITLE SHEET IS STAMPED IN RED INK "FOR CONSTRUCTION" AND EACH SUCCESSIVE SHEET BEARS THE ARCHITECT'S/ENGINEER'S SIGNED WET STAMP
- 9. THE CONTRACTOR IS RESPONSIBLE FOR ADEQUATELY BRACING AND PROTECTING ALL WORK DURING CONSTRUCTION AGAINST DAMAGE, BREAKAGE, COLLAPSE, ETC. ACCORDING TO APPLICABLE CODES, STANDARDS, AND GOOD CONSTRUCTION PRACTICES
- 10. THE CONTRACTOR SHALL MEET ALL OSHA REQUIREMENTS FOR ALL INSTALLATIONS.
- 11. THE CONTRACTOR SHALL BE RESPONSIBLE FOR ALL DAMAGES TO THE EXISTING CONSTRUCTION AND REPAIR ALL DAMAGES TO BETTER THAN NEW CONSTRUCTION. THE CONTRACTOR SHALL NOTIFY THE CONSULTANT OF ANY DAMAGE TO THE BUILDING SITE OR ANY ADJACENT STRUCTURES AROUND THE PROJECT. THE T-MOBILE REPRESENTATIVE SHALL BE SOLE AND FINAL JUDGE AS TO THE QUALITY OF THE REPAIRED CONSTRUCTION. ANY ADDITIONAL MODIFICATIONS WHICH MUST BE MADE SHALL BE MADE AT THE CONTRACTOR'S EXPENSE.
- 12. WHERE NEW PAVING, CONCRETE SIDEWALKS OR PATHS MEET EXISTING CONSTRUCTION, THE CONTRACTOR SHALL MATCH THE EXISTING PITCH, GRADE, AND ELEVATION SO THE ENTIRE STRUCTURE SHALL HAVE A SMOOTH TRANSITION.
- 13. THE CONTRACTOR SHALL MODIFY THE EXISTING FLOORS, WALL, CEILING, OR OTHER CONSTRUCTION AS REQUIRED TO GAIN ACCESS TO AREAS FOR ALL MECHANICAL, PLUMBING, ELECTRICAL, OR STRUCTURAL MODIFICATIONS. WHERE THE EXISTING CONSTRUCTION DOORS. PARTITIONS, CEILING, ETC., ARE TO BE REMOVED, MODIFIED, OR REARRANGED OR WHERE THE EXPOSED OR HIDDEN MECHANICAL, ELECTRICAL, SYSTEMS ARE ADDED OR MODIFIED, THE GENERAL CONTRACTOR SHALL REPAIR, PATCH AND MATCH ALL EXISTING CONSTRUCTION AND FINISHES OF ALL FLOORS WALLS AND CEILINGS. WHERE CONCRETE MASONRY CONSTRUCTION IS MODIFIED, THE CONTRACTOR SHALL TOOTH IN ALL NEW CONSTRUCTION TO MATCH THE EXISTING BOND. WHERE CONCRETE CONSTRUCTION IS MODIFIED. THE CONTRACTOR SHALL VERIFY THE EXACT DETAILS TO BE USED FOR CONSTRUCTION. ALL WORK SHALL BE COVERED UNDER THE GENERAL CONTRACT
- 14. IF CONTRACTOR OR SUBCONTRACTOR FIND IT NECESSARY TO DEVIATE FROM ORIGINAL APPROVED PLANS. THEN IT IS THE CONTRACTOR'S AND THE SUBCONTRACTOR'S RESPONSIBILITY TO PROVIDE THE CONSULTANT WITH 4 COPIES OF THE PROPOSED CHANGES FOR HIS APPROVAL BEFORE PROCEEDING WITH THE WORK. IN ADDITION THE CONTRACTOR AND SUBCONTRACTORS SHALL BE RESPONSIBLE FOR PROCURING ALL NECESSARY APPROVALS FROM THE BUILDING AUTHORITIES FOR THE PROPOSED CHANGES BEFORE PROCEEDING WITH THE WORK. THE CONTRACTOR AND SUBCONTRACTORS SHALL BE RESPONSIBLE FOR PROCURING ALL NECESSARY INSPECTIONS AND APPROVALS FROM BUILDING AUTHORITIES DURING THE EXECUTION OF THE WORK.
- 15. CONTRACTOR TO PROVIDE A PORTABLE FIRE EXTINGUISHER WITH A RATING OF NOT LESS THAN 2-A OR 2-A10BC WITHIN 75 FEET TRAVEL DISTANCE TO ALL PORTIONS OF PROJECT AREA DURING CONSTRUCTION
- 16. THE CONTRACTOR SHALL PERFORM WORK DURING OWNER'S PREFERRED HOURS TO AVOID DISTURBING NORMAL BUSINESS
- 17. SEAL ALL PENETRATIONS THROUGH FIRE-RATED AREAS WITH U.L. LISTED OR FIRE MARSHAL APPROVED MATERIALS AS APPLICABLE TO THIS FACILITY AND OR PROJECT SITE.
- 18. CONTRACTOR SHALL BE RESPONSIBLE FOR UTILITY LOCATES, SCHEDULING, COORDINATING SPECIAL AND BUILDING DEPARTMENT INSPECTIONS.
- 19. CONTRACTOR SHALL BE RESPONSIBLE FOR CONTACTING AND UTILIZING ORIGINAL ROOFING CONTRACTOR AS REQUIRED TO MAINTAIN ANY EXISTING ROOFING WARRANTY.
- 20. ROUTING OF ALL CONDUITS, CABLES, CABLE TRAYS ETC ARE INDICATED AS PROPOSED LOCATION ONLY. CONFIRM THE EXACT LOCATION AND ROUTING WITH THE ON SITE T-MOBILE CONSTRUCTION MANAGER PRIOR TO STARTING WORK

CONCRETE NOTES:

#5 AND SMALLER & WWF11/2 IN.

- 1. ALL CONCRETE WORK SHALL BE IN ACCORDANCE WITH THE ACI 301, ACI 318 AND THE SPECIFICATION CAST-IN-PLACE CONCRETE
- 2. ALL CONCRETE SHALL HAVE A MINIMUM COMPRESSIVE STRENGTH OF 3000 PSI AT 28 DAYS UNO.
- 3. REINFORCING STEEL SHALL CONFORM TO ASTM A 615. GRADE 60. DEFORMED UNLESS NOTED OTHERWISE. WELDED WIRE FABRIC SHALL CONFORM TO ASTM A 185 WELDED STEEL WIRE FABRIC UNLESS NOTED OTHERWISE. SPLICES CLASS "B" AND ALL HOOKS SHALL BE STANDARD UNO.
- 4. THE FOLLOWING MINIMUM CONCRETE COVER SHALL BE PROVIDED FOR REINFORCING STEEL UNLESS SHOWN OTHERWISE ON DRAWINGS: CONCRETE CAST AGAINST EARTH - 3 IN. CONCRETE EXPOSED TO EARTH OR WEATHER: #6 AND LARGER ...
- 5. A 1/2" TROWELED RADIUS SHALL BE PROVIDED AT ALL EXPOSED EDGES OF CONCRETE UNO. HOLES TO RECEIVE EXPANSION/WEDGE ANCHORS SHALL BE 1/8" LARGER IN DIAMETER THAN THE ANCHOR BOLT, DOWEL OR ROD AND SHALL CONFORM TO MFR RECOMMENDATION FOR EMBEDMENT DEPTH OR AS SHOWN ON THE DRAWINGS. AVOID CUTTING EXISTING REBAR WHEN DRILLING HOLES IN THE

6. INSTALLATION OF CONCRETE EXPANSION/WEDGE ANCHOR, SHALL BE PER MANUFACTURER'S WRITTEN RECOMMENDED PROCEDURES.

7. FLOAT SURFACE SHALL BE A SMOOTH FINISH. SURFACE SHALL BE FREE OF ALL OBVIOUS DEPRESSIONS. SURFACE SHALL BE SLOPED AT 2% TO PROMOTE DRAINAGE AWAY FROM EQUIPMENT.

ABBREVIATIONS

ELEVATED SLAB

AC AFF AFG	AIR CONDITIONER ABOVE FINISHED FLOOR ABOVE FINISHED GRADE	JT LAM LF	JOINT LAMINATED LINEAL FOOT
AFS ALUM	AIRCONDITIONEN ABOVE FINISHED FLOOR ABOVE FINISHED GRADE ABOVE FINISHED SLAB ALUMINUM ANCHOR BOLT ANGLE	MANUF MAX MECH	LINEAL FOOT MANUFACTURER MAXIMUM MECHANICAL MANHOLE
ARCH BTS	ÄNGLE ARCHITECTURAL BASE TRANSMISSION SYSTEM BUILDING	MH MM MIN	
BLDG BM BOT	BUILDING BEAM BOTTOM	MISC MPH MTL	MILLINETER MINIMUM MISCELLANEOUS MILES PER HOUR METAL NOT IN CONTRACT
B.O. BOC BOS	BOILDING BEAM BOTTOM BOTTOM OF BOTTOM OF CONCRETE BOTTOM OF STEEL CONTROL JOINT CENTER LINE	NIC NOM NTS	NOT IN CONTRACT NOMINAL NOT TO SCALE
CLG	CONTROL JOINT CENTER LINE CEILING	OC OD OH	NOMINAL NOT TO SCALE ON CENTER OUTSIDE DIAMETER OVERHEAD
CLR CMU COL	CLEAR CONCRETE MASONRY UNIT	OPNG OPP (P)	OVERHEAD OPENING OPPOSITE PROPOSED
CONC	COLOMINO CONCRETE CONSTRUCTION CONTINUOUS CENTER DIAMETER	PĆS P	PERSONAL COMMUNICATION SYSPLATE PAIR
CONT CTR DIA / DTL	CENTER DIAMETER DETAIL	PSI PSF PT	POUNDS PER SQUARE INCH
EA	EXISTING EACH EXPANSION JOINT	RAD RD REINE	PRESSURE TREATED RADIUS ROOF DRAIN REINFORCED/REINFORCING
ELEC	ELECTRIC/ELECTRICAL ELEVATION EQUAL	REQ'D RM R/W	ROOM
EQ EW EXP EXT	EACH WAY EXPANSION EXTERIOR FLOOR DRAIN	SCHED SECT SF	RIGHT OF WAY SCHEDULE SECTION SCHEDULE SECTION SQUARE FOOT SQUARE FOOT STAINLESS STEEL STANDARD STEEL STRUCTURAL TEMPORARY THICK
	FLOOR DRAIN FINISH FINISH FLOOR	SIM	SIMILAR SQUARE FOOT STAINLESS STEEL
FLR FTG GA	FINISH FLOOR FINISH FLOOR FLOOR FOOTING GAUGE	SS STD STL STRUC	STANDARD STEEL STRUCTURAL
GALV GYP GB	GALVANIZED GYPSUM GYPSUM BOARD	TEMP THK T.O.	TEMPORARY THICK TOP OF
HM HOR HR	GAUVANIZED GALVANIZED GYPSUM GYPSUM BOARD HOLLOW METAL HORIZONTAL HOUR	TOS TOC TYP	THICK TOP OF STEEL TOP OF CONCRETE TYPICAL UNLESS NOTED OTHERWISE
HVAC INSUL	HEATING VENTILATION AIR CONDITIONING	ÜNO	VINYL COMPOSITION THE
INT	INSULATION INTERIOR	W/ WWM	VERTICAL WITH WELDED WIRE MESH
. = -	NDO C OVINDOLO		

LEGENDS & SYMBO	DLS
CHAIN LINK FENCE	_ x x x x x
CEDAR FENCE	
POWER	- P — P — P — P — P — P — P —
TELCO	$ \tau \tau \tau \tau \tau \tau \tau -$
POWER/TELCO	- P — T — P — T — P — T —
COAX	- COAX - COAX - COAX - COAX -
OVERHEAD POWER	—ОН——ОН——ОН——ОН——ОН——
CENTERLINE	
REVISION BUG	
ELEVATION VIEW BUG	DETAIL NUMBER
	SHEET NUMBER
	TOP OF XXXXX
ELEVATION VIEW BUG	XXX'-X" AGL
DETAIL BUG	DETAIL NUMBER
	SHEET NUMBER
	DETAIL NUMBER
SECTION BUG	
	SHEET NUMBER

SITE WORK NOTES:

- 1. RUBBISH, STUMPS, DEBRIS, STICKS, STONES AND OTHER REFUSE SHALL BE REMOVED FROM THE SITE AND DISPOSED OF LEGALLY
- 2. THE SITE SHALL BE GRADED TO CAUSE SURFACE WATER TO FLOW AWAY FROM THE PCS FOLIPMENT TOWER AREAS, AND ADJACENT BUILDINGS
- 3. NO FILL OR EMBANKMENT MATERIAL SHALL BE PLACED ON FROZEN GROUND. FROZEN MATERIALS, SNOW OR ICE SHALL NOT BE PLACED IN ANY FILL OR EMBANKMENT.
- 4. THE SUBGRADE SHALL BE COMPACTED AND BROUGHT TO A SMOOTH UNIFORM GRADE PRIOR TO THE CRUSHED STONE APPLICATION
- 5. ALL EXISTING ACTIVE SEWER, WATER, GAS, ELECTRIC, AND OTHER UTILITIES WHERE ENCOUNTERED IN THE WORK SHALL BE PROTECTED AT ALL TIMES AND WHERE REQUIRED FOR THE PROPER EXECUTION OF THE WORK, SHALL BE RELOCATED AS DIRECTED BY ENGINEERS. EXTREME CAUTION SHOULD BE USED BY THE CONTRACTOR WHEN EXCAVATING OR PIER DRILLING AROUND OR NEAR UTILITIES. CONTRACTOR SHALL PROVIDE SAFETY TRAINING FOR THE WORKING CREW.
- 6. ALL EXISTING INACTIVE SEWER, WATER, GAS, ELECTRIC AND OTHER UTILITIES, WHICH INTERFERE WITH THE EXECUTION OF THE WORK, SHALL BE REMOVED AND SHALL BE CAPPED, PLUGGED OR OTHERWISE DISCONTINUED AT POINTS WHICH WILL NOT INTERFERE WITH THE EXECUTION OF THE WORK, SUBJECT TO THE APPROVAL OF
- 7. THE AREAS OF THE CUSTOMER'S PROPERTY DISTURBED BY THE WORK AND NOT COVERED BY THE BUILDING, DRIVEWAY OR CRUSHED STONE, SHALL BE GRADED TO A UNIFORM SLOPE, FERTILIZED, SEEDED, AND COVERED WITH MULCH AS SPECIFIED IN THE SPECIFICATION LANDSCAPE WORK.
- 8. BEDDING MATERIAL FOR UTILITY LINES, CULVERTS AND PIPING: CLEAN SAND, MEDIUM TP COARSE, SUB ROUNDED NATURAL RIVER OR BANK SAND, WASHED, FREE OF SILT OR CLAY, LOAM, FRIABLE OR SOLUBLE MATERIALS, AND ORGANIC MATER; GRADED IN ACCORDANCE WITH THE FOLLOWING GRAIN SIZE DISTRIBUTION:

SIEVE SIZE	PERCENT PASSII
3/8"	100
NO. 4 MESH	60-90
NO. 8 MESH	0-45
NO. 16 MESH	0-25
NO. 100 MESH	0-2
NO. 100 MESH	0-2
NO. 200 MESH	0-2

9. BMP'S FOR TEMPORARY EROSION/SEDIMENTATION CONTROL SHALL BE IMPLEMENTED PER LOCAL, CITY OR COUNTY GUIDELINES AND PER PLAN IF APPLICABLE.

SPECIAL INSPECTIONS:

SPECIAL INSPECTIONS IN ACCORDANCE WITH IBC 2015 SECTION 1704.

SOILS/GEOTECHNICAL:

- ☐ SHORING INSTALLATION AND MONITORING
- □ OBSERVE AND MONITOR EXCAVATION
- ☐ VERIFY SOIL BEARING nsf BEARING
- ☐ SUBSURFACE DRAINAGE PLACEMENT
- □ VERIFY FILL MATERIAL AND COMPACTION □ VERIFY CONDITIONS AS ANTICIPATED
- ☐ PILE PLACEMENT (AUGER CAST/DRIVEN PILE)
- □ OTHER

REINFORCED CONCRETE:

- ☐ REINFORCING STEEL AND CONCRETE PLACEMENT
- □ PRESTRESSED/PRECAST CONCRETE FABRICATION AND ERECTION
- □ BATCH PLANT INSPECTION
- □ SHOTCRETE
- □ GROUTING □ OTHER

STRUCTURAL STEEL:

- ☐ FABRICATION AND SHOP WELDS
- ☐ ERECTION AND FIELD WELDS AND BOLTING
- □ OTHER:

STRUCTURAL ALLIMINUM:

- ☐ FABRICATION AND SHOP WELDS
- ☐ ERECTION AND FIELD WELDS AND BOLTING
- □ OTHER:

STRUCTURAL MASONRY: □ CONTINUOUS

- □ PERIODIC
- □ OTHER:

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ANCHORING TO CONCRETE

- ☐ BOLTS INSTALLED IN CONCRETE
- ☐ POST-INSTALLATION ADHESIVE ANCHORS
- □ POST-INSTALLATION MECHANICAL ANCHORS



==PROJECT INFORMATION:=

CLE ELUM DT US-WA-5105 200 SOUTH PENNSYLVANIA AVE **CLE ELUM. WA 98922**

ISSUED FOR:

BUILDING PERMIT

=REVISION HISTORY:======				
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=PLANS PREPARED BY:====

B. J. THOMAS, P.E. **7607 80TH AVE NE MARYSVILLE, WA 98270** 206-851-1106

ļ	DRAWN BY: CHK. BY:			
		BJ		
	JL	BJ		

LICENSURE:




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GENERAL NOTES

=DRAWING NUMBER:=====





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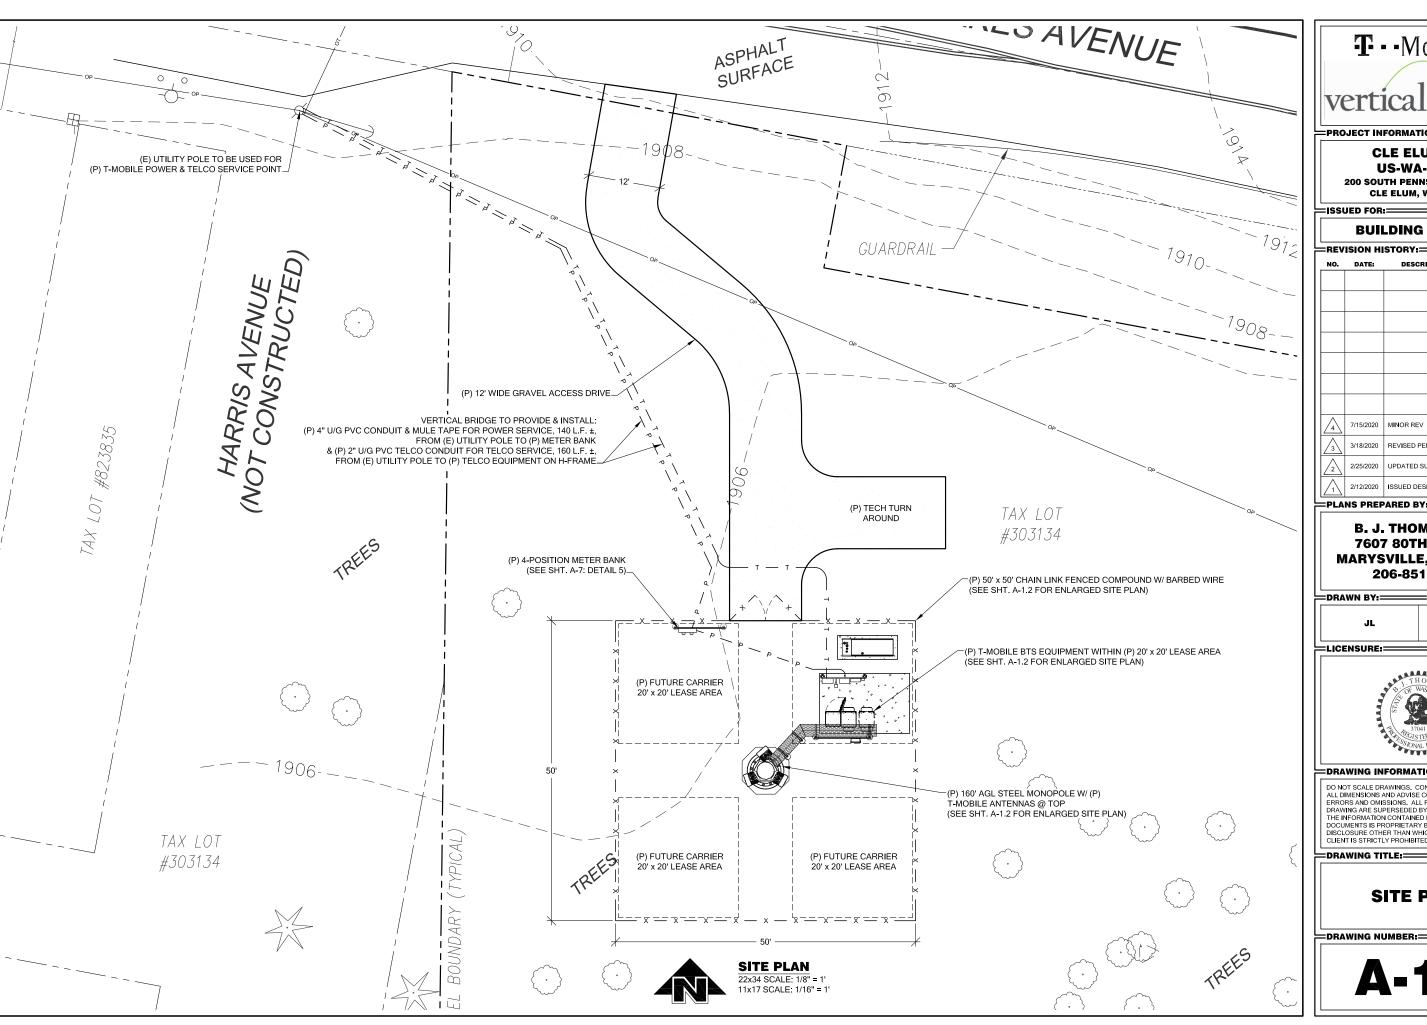

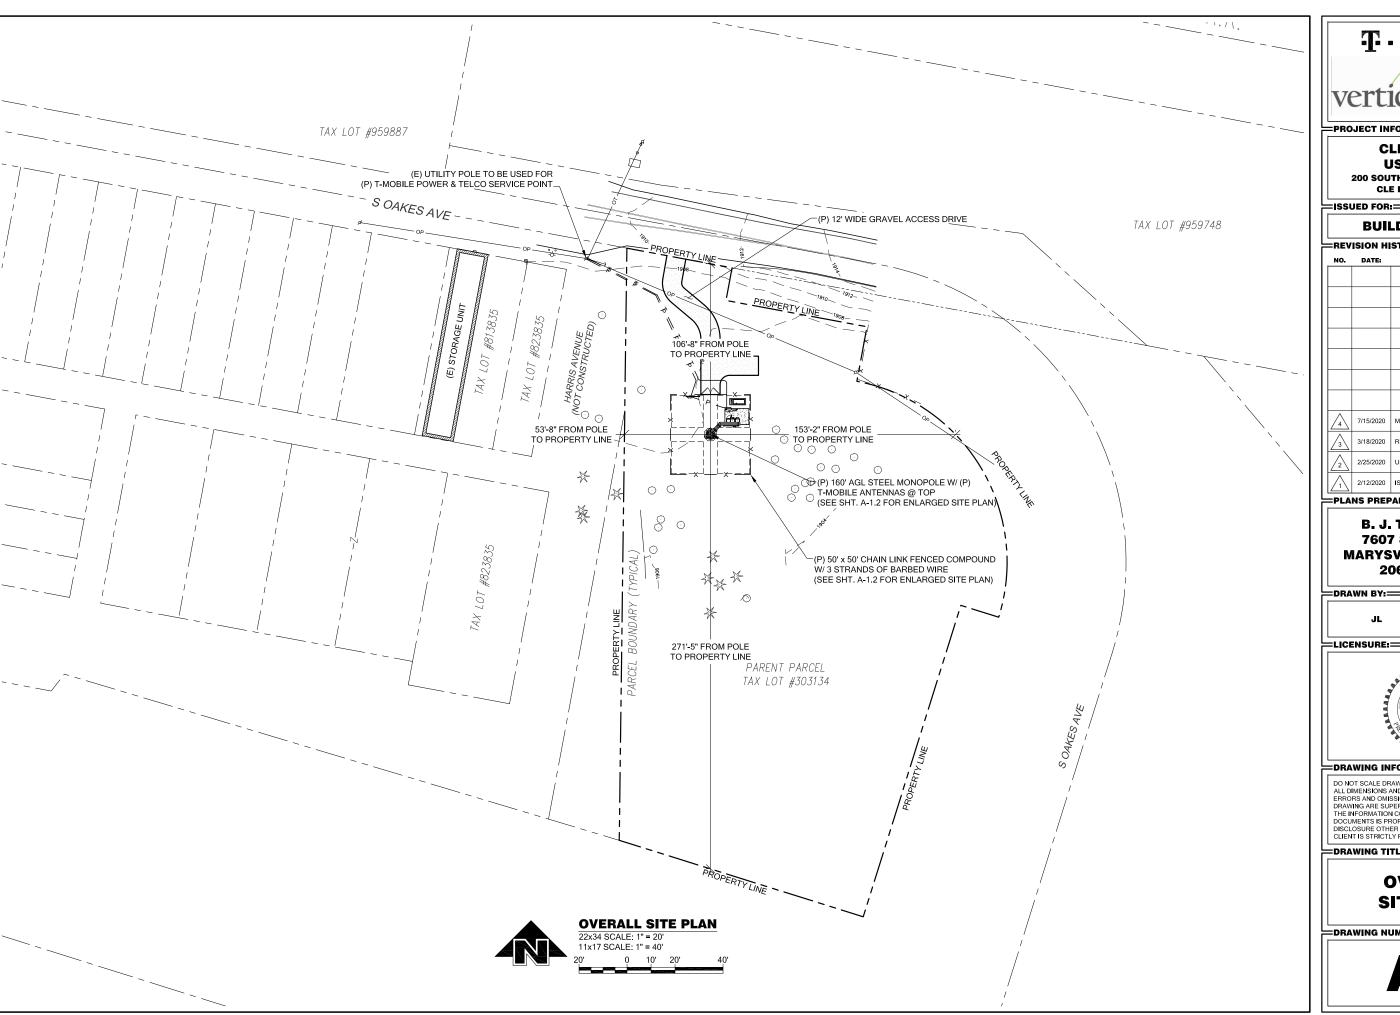
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DRAWING TITLE:

OVERALL SITE PLAN





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200 SOUTH PENNSYLVANIA AVE **CLE ELUM, WA 98922**

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PLANS PREPARED BY:

B. J. THOMAS, P.E. **7607 80TH AVE NE MARYSVILLE, WA 98270** 206-851-1106

DRAWN BY:	—СНК. ВY:——

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LICENSURE:




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DRAWING TITLE:

SITE PLAN



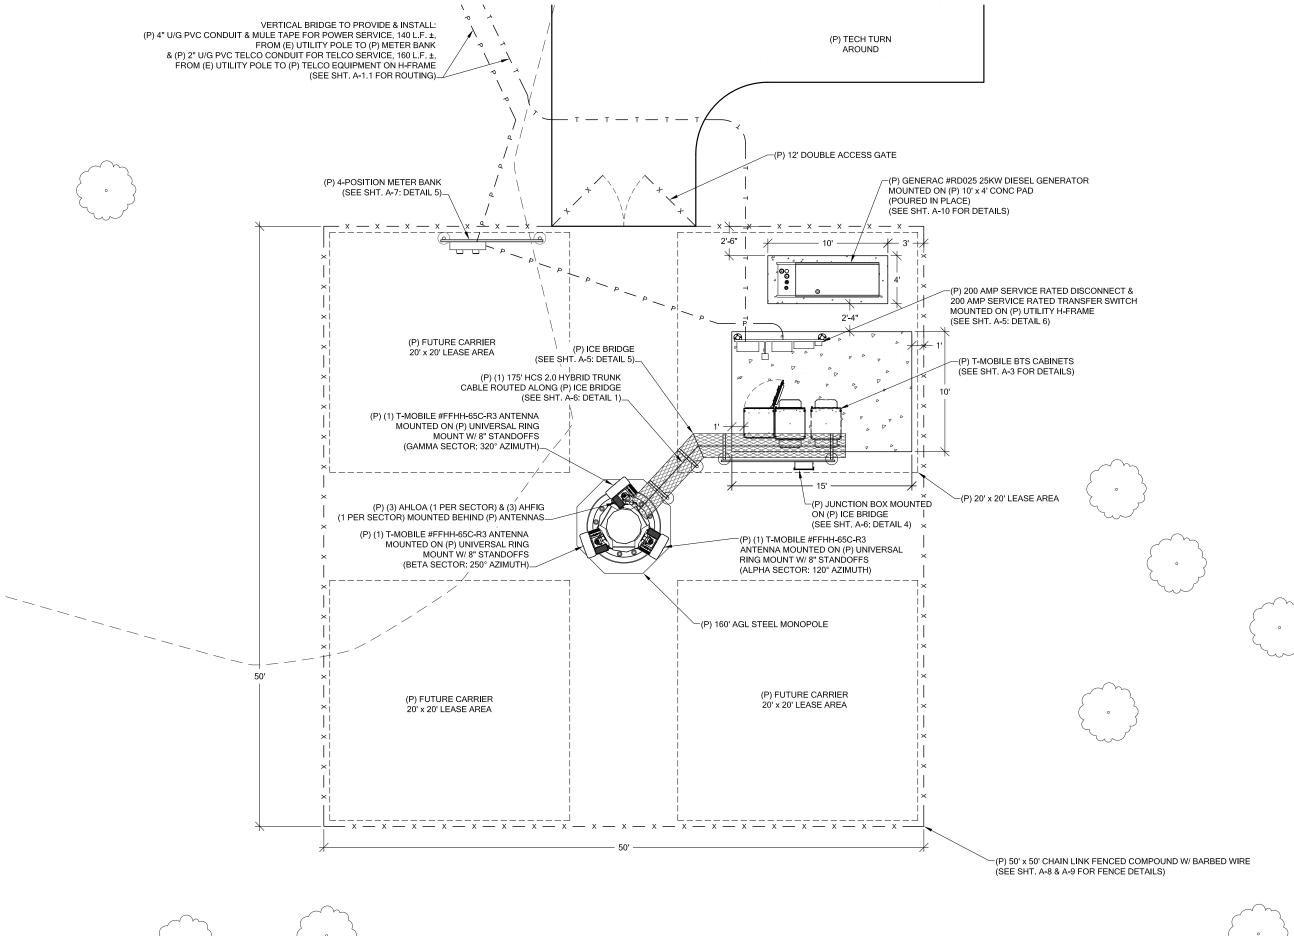

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200 SOUTH PENNSYLVANIA AVE CLE ELUM, WA 98922

ISSUED FOR:=

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JL BJ

LICENSURE:



DRAWING INFORMATION:

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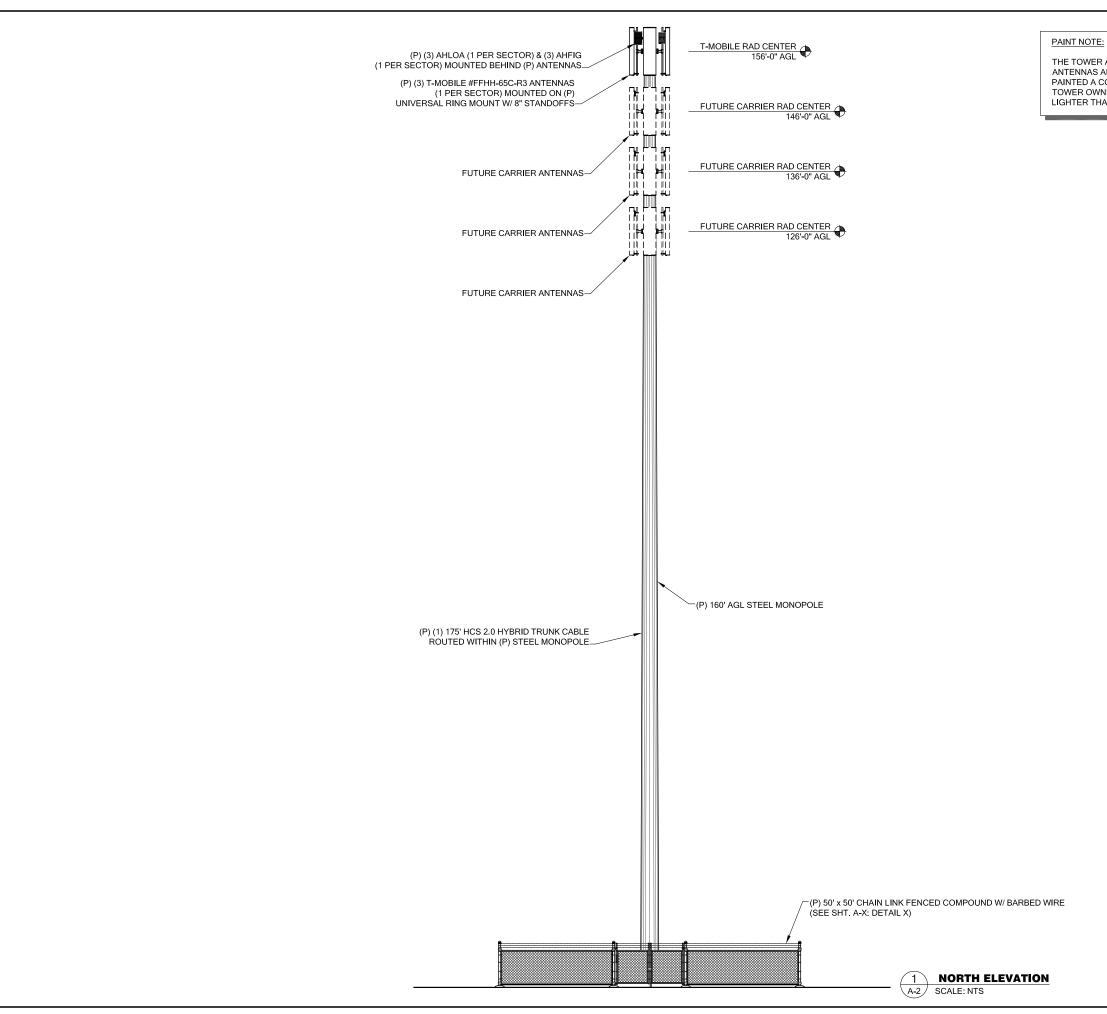
DRAWING TITLE:

ENLARGED SITE PLAN

DRAWING NUMBER:

A-1.2





THE TOWER AND ALL PROPOSED AND FUTURE ANTENNAS AND ATTACHMENTS SHALL BE FACTORY PAINTED A COLOR THAT IS SELECTED BY THE TOWER OWNER AND IS SIMILAR TO, AND NO LIGHTER THAN, SHERWIN WILLIAMS JASPER #6216.



PROJECT INFORMATION:=

CLE ELUM DT US-WA-5105

200 SOUTH PENNSYLVANIA AVE CLE ELUM, WA 98922

ISSUED FOR:=

BUILDING PERMIT

-REV	=REVISION HISTORY:====================================			
NO.	DATE:	DESCRIPTION:	BY:	
4	7/15/2020	MINOR REV	BJT	
3	3/18/2020	REVISED PER REDLINES	BJT	
2	2/25/2020	UPDATED SURVEY ADDED	BJT	
/1\	2/12/2020	ISSUED DESIGN REVIEW	ВЈТ	

PLANS PREPARED BY:

B. J. THOMAS, P.E. **7607 80TH AVE NE MARYSVILLE, WA 98270** 206-851-1106

DRAWN BY: CHK. BY:

LICENSURE:





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DRAWING TITLE:

SITE **ELEVATION**



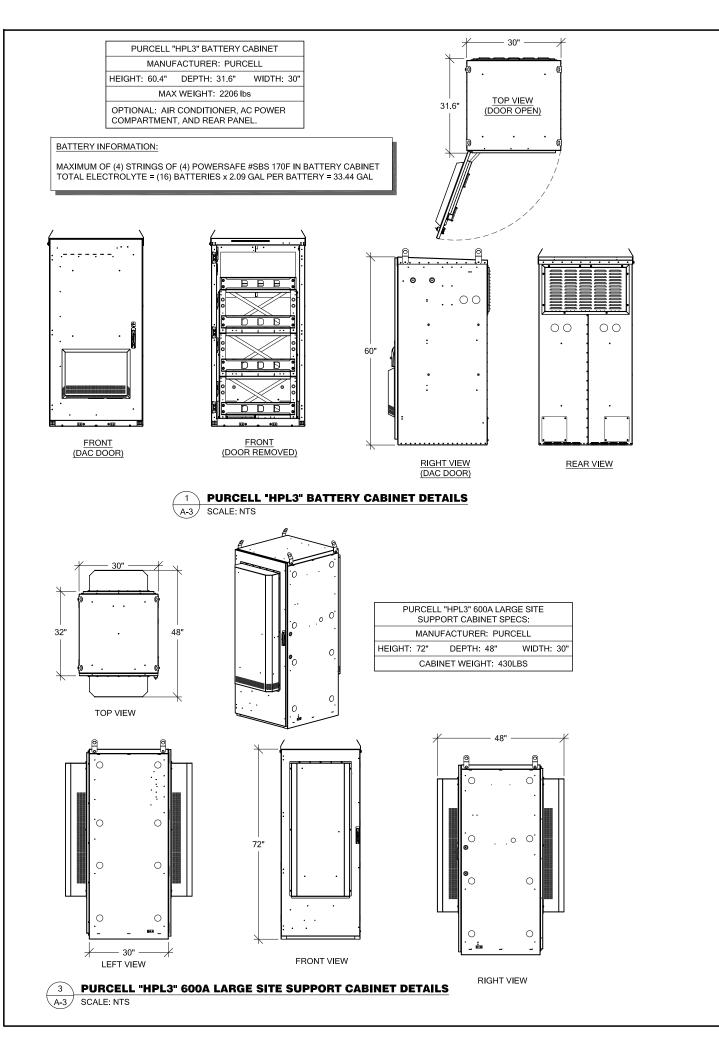

PURCELL "HPL3" EXPANSION CABINET DETAILS

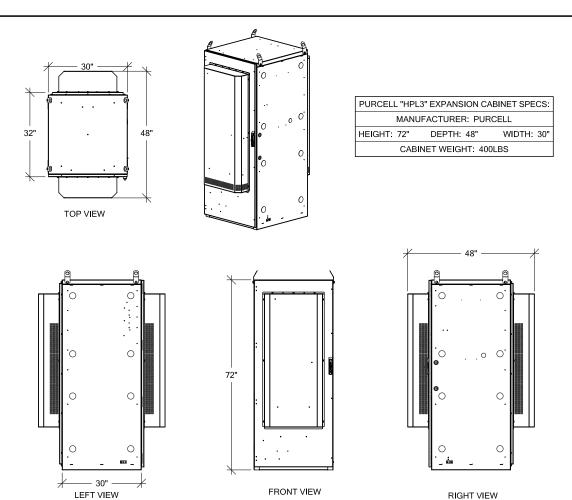A-3 SCALE: NTS



PROJECT INFORMATION:

CLE ELUM DT US-WA-5105

200 SOUTH PENNSYLVANIA AVE CLE ELUM, WA 98922

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\bigwedge	2/12/2020	ISSUED DESIGN REVIEW	BJT

PLANS PREPARED BY:

B. J. THOMAS, P.E. 7607 80TH AVE NE MARYSVILLE, WA 98270 206-851-1106

JL BJ

LICENSURE:



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DRAWING TITLE:

BTS EQUIPMENT DETAILS

DRAWING NUMBER:

A-3

MANUFACTURER: MODEL:


NOKIA ABIA AIR SCALE

DIMENSION (HxWxD)

1.9" x 8.3" x 14.8"


WEIGHT:

4.63 LBS

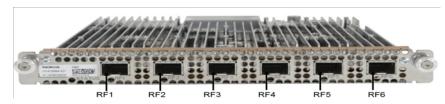



ASIK - Baseband Card

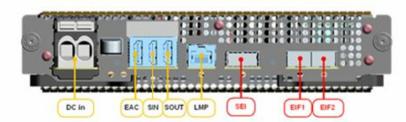

NOKIA ASIK AIR SCALE


DIMENSION (HxWxD) 1.9" x 8.3" x 14.8" WEIGHT:

MANUFACTURER: MODEL:

6.83 LBS

ASIK DETAIL SCALE: NTS


ABIL - Capacity Card

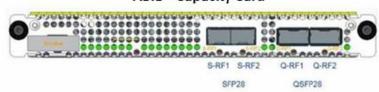


MANUFACTURER: NOKIA ABIL AIR SCALE MODEL:

DIMENSION (HxWxD) 1.9" x 8.3" x 14.8" 4.63 LBS WEIGHT:

ABIL DETAIL SCALE: NTS

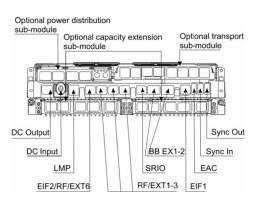


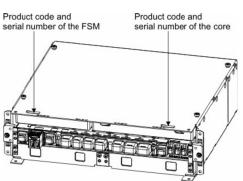


FSMF MODULE		
PROPERTY	VALUE	
HEIGHT	133mm/3U (5.2 in)	
WIDTH	447 mm (17.6 in)	
DEPTH	422 mm (16.5 in)	
WEIGHT W/ CORE MODULE	MAX. 11.5 kg (25.3 lb)	






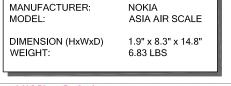

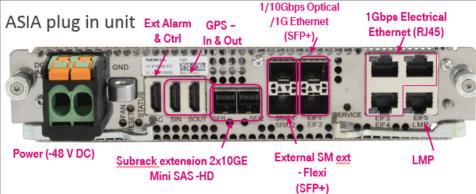


ASIA DETAIL SCALE: NTS

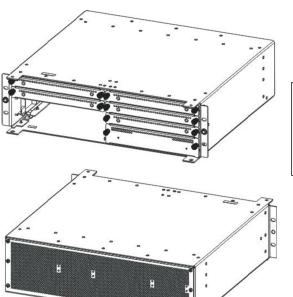

MANUFACTURER: MODEL: AMIA AIRSCALE SUBRACK 5.0" x 17.6" x 15.7" EMPTY: 10.9 LBS DIMENSION (HxWxD) WEIGHT:

WITH BLINDS: 14.8 LBS WITH ALL UNITS: 52 LBS

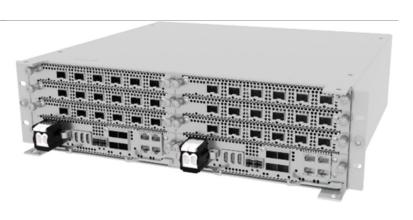

AMIA DETAIL SCALE: NTS



PROJECT INFORMATION:=

CLE ELUM DT US-WA-5105

200 SOUTH PENNSYLVANIA AVE **CLE ELUM, WA 98922**

ISSUED FOR:=

BUILDING PERMIT

FREVISION HISTORY:				
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<u>/</u> 3\	3/16/2020	REVISED PER REDLINES	DJI	
$\sqrt{2}$	2/25/2020	UPDATED SURVEY ADDED	ВЈТ	
<u> </u>				
1	2/12/2020	ISSUED DESIGN REVIEW	BJT	

PLANS PREPARED BY:

B. J. THOMAS, P.E. **7607 80TH AVE NE MARYSVILLE, WA 98270** 206-851-1106

DRAWN BY:----CHK. BY:-

LICENSURE:




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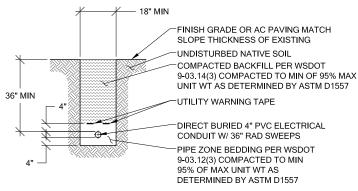
GENERAL DETAILS






1 TELCO SERVICE TRENCH

A-5 SCALE: NTS

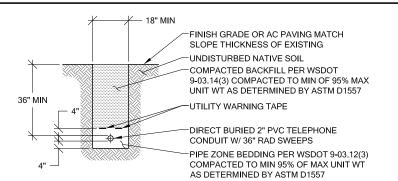

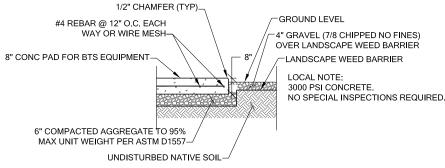






4 SITE SIGNAGE DETAIL
A-5 SCALE: NTS

POWER SERVICE TRENCH A-5 SCALE: NTS

NOTE:


ANCHOR DETAIL- 1/2" DIAMETER ANCHOR BOLTS IF CAST IN PLACE WITH 6" DEPTH OR 5/8" DIAMETER HILTI KWIK HUS-EZ BOLTS IF POST-INSTALLED WITH 6" DEPTH.

PLATE DETAIL- CARRIER CAN ALTERNATELY INSTALL A PRE-MANUFACTURED KIT FROM SITE PRO, SUCH AS THEIR PRODUCT "IB24D" OR IB24B".

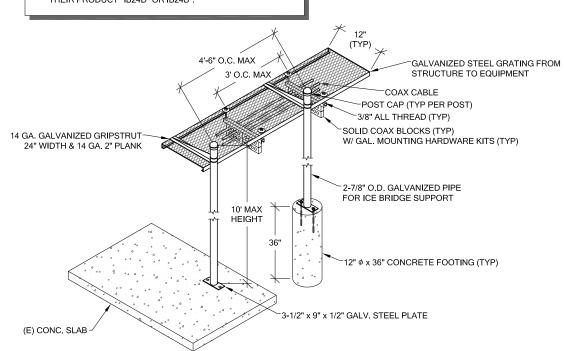

SCALE: NTS



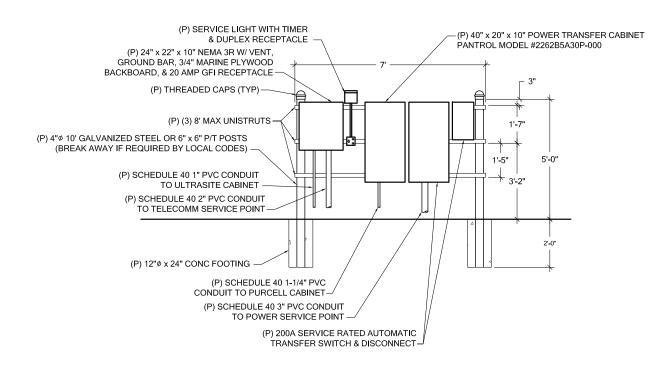

7 EQUIPMENT H-FRAME DETAIL
A-5 SCALE: NTS



PROJECT INFORMATION:

CLE ELUM DT US-WA-5105

200 SOUTH PENNSYLVANIA AVE CLE ELUM, WA 98922

SSUED FOR:=

BUILDING PERMIT

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PLANS PREPARED BY:

B. J. THOMAS, P.E. 7607 80TH AVE NE MARYSVILLE, WA 98270 206-851-1106

ᅡ	=DRAWN BY:====	=: СНК. ВҮ: ====	
	JL	BJ	

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DRAWING TITLE:

GENERAL DETAILS




HELIAX® FiberFeed® Hybrid Trunk Cables

FiberFeed® trunk cable assemblies are factory constructed specifically for the devices listed in this guide ensuring perfect compatibility and trouble free installation. Additional features that ease installation and ensure a long service life include:

- Robust breakout design tailored for specific enclosures
- Integrated rip cords for length management
- Stranded construction for easy bending and maximum fiber protection
 Factory test certificate included with every cable assembly
- Corrugated aluminum shield protects from crush and animal damage

Specifications

Hybrid Trunk Cable 6 AWG power conductor wire 24 Single mode fiber					
FD2606-24S55	6	6	24	24	31/33

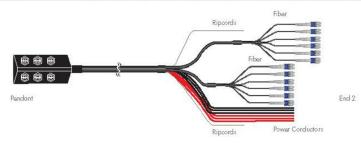

HYBRID TRUNK CABLE DETAIL SCALE: NTS

Hybrid Jumpers for Nokia Radios

Ordering Information

Hybrid Jumpers for Nokia Radios	6	HFT410-4SNOK2-6
End 1: 4 fibers terminated DIC for Nokia RRUs with flush out power cord (red/black conductors).	10	HFT41 0-4\$NOK2-10
End 2: 4 fibers terminated LC and 4 X 10 AVVG	15	HFT41 0-4\$NOK2-15
conductors terminated at hybrid trunk connector (HQLC)	20	HFT41 0-4\$NOK2-20
	25	HFT41 0-4\$NOK2-25
	30	HFT41 0-4\$NOK2-30
	40	HFT41 0-4SNOK2-40
	50	HFT41 0-4\$NOK2-50
	60	HFT41 0-4\$NOK2-60
	70	HFT41 0-4SNOK2-70
	80	HFT41 0-4\$NOK2-80
	90	HFT41 0-4\$NOK2-90
	100	HFT410-4SNOK2-100

Note: Longer lengths are available; contact your CommScope sales representative for details.






RADIO MODULE FOR 600/700MHz RRH

MANUFACTURER: MODEL:

AHLOA

NET WEIGHT: DIMENSION (LxWxD) 83.78 LBS

22.05" x 12.13" x 7.44"

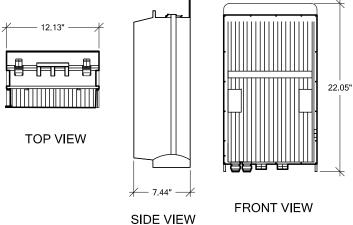

3 AHLOA DETAIL
A-6 SCALE: NTS

MANUFACTURER: MODEL: AHFIG 70.5 LBS WEIGHT: 27.4" x 12.1" x 6.5" DIMENSION (LxWxD)

12.1" ISO FRONT FAN/EAC

AHFIG DETAIL SCALE: NTS

ANT-2

ANT-3


ANT-1

OPT-1

GND

FIBER & POWER JUNCTION BOX W/ OVP

MANUFACTURER: MODEL:	COMMSCOPE FE-16148-OVP-B12
DIMENSION (HxWxD) WEIGHT:	16" x 14" x 8" 23.5lbs

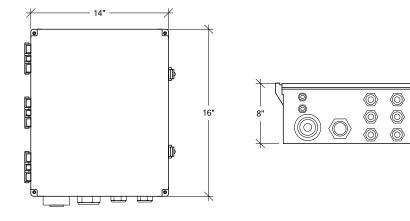






PROJECT INFORMATION:=

CLE ELUM DT US-WA-5105

200 SOUTH PENNSYLVANIA AVE **CLE ELUM, WA 98922**

ISSUED FOR:=

BUILDING PERMIT

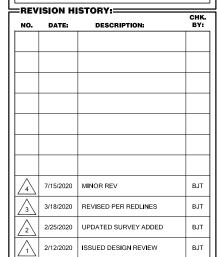

PLANS PREPARED BY:

B. J. THOMAS, P.E. **7607 80TH AVE NE** MARYSVILLE, WA 98270 206-851-1106

DRAWN BY: CHK. BY:

LICENSURE:



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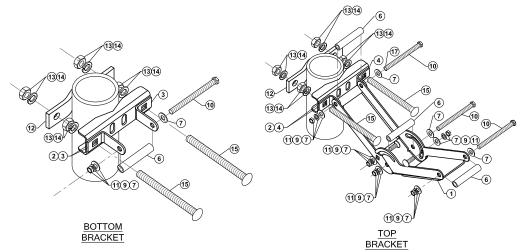
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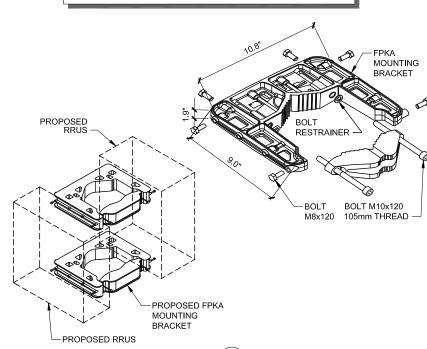









NOTE: -PROPOSED RRUS TO BE MOUNTED VERTICALLY ONLY -MOUNTING PIPE NOT SHOWN FOR CLARITY




4 FPKA DETAIL
A-7 SCALE: NTS

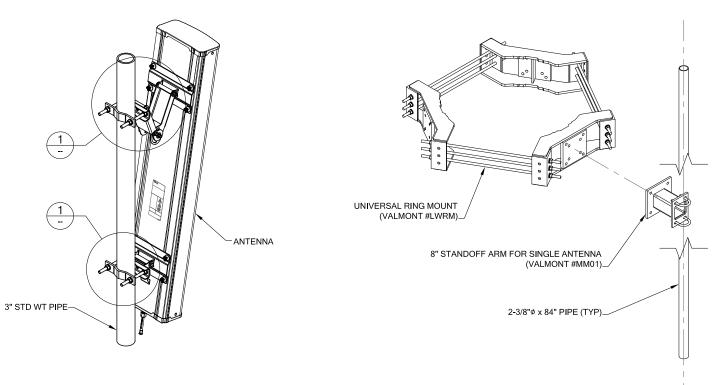

A-7 SCALE: NTS

3 UNIVERSAL RING MOUNT & 8" STANDOFF DETAIL SCALE: NTS

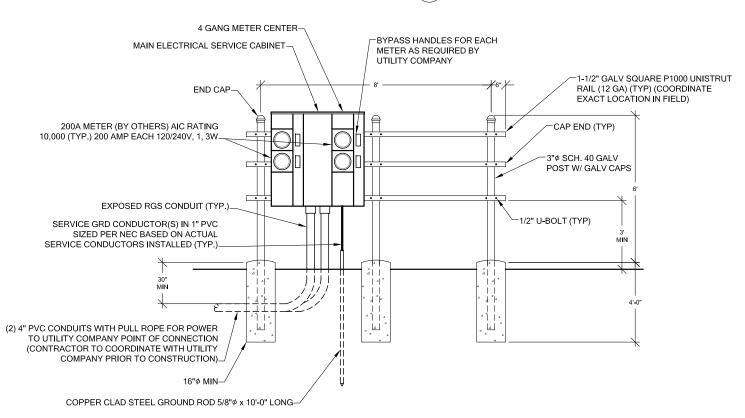





PROJECT INFORMATION:

CLE ELUM DT US-WA-5105

200 SOUTH PENNSYLVANIA AVE CLE ELUM, WA 98922

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ı	=DRAWN BY:====	=СНК. ВҮ:	
	JL	BJ	

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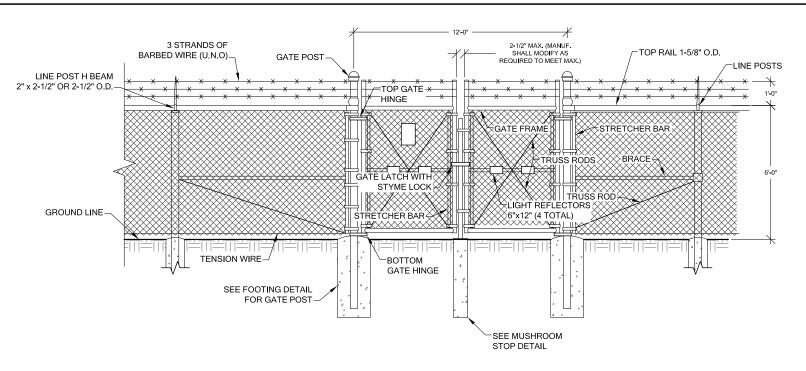
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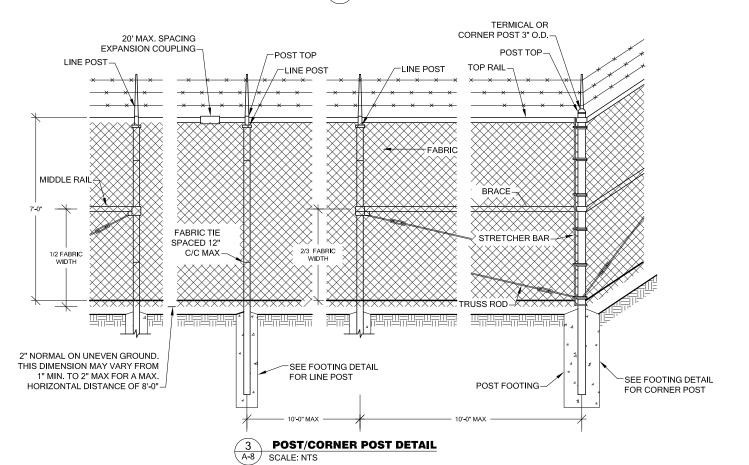
DRAWING TITLE:

GENERAL DETAILS





1 CHAIN LINK DETAIL A-8 SCALE: NTS




CENTER GATE STOP

METAL MUSHROOM STOP.
INSTALL WITH SLOT PARALLEL
WITH GATE CLOSED

MUSHROOM STOP DETAIL

A-8 SCALE: NTS

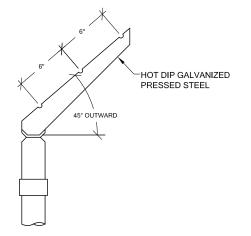

4 BARBED WIRE ARM OF LINE POST
A-8 SCALE: NTS



5 INSTALLATION AT CORNERS
A-8 SCALE: NTS



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PLANS PREPARED BY:

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DRAWN BY:	—СНК. ВҮ:
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DRAWING TITLE:

FENCE DETAIL

DRAWING NUMBER:

A-8

NOTES:

ZINC COATING - THE WEIGHT OF THE COATING SHALL NOT BE LESS THAN 1.2 OUNCES PER SQUARE FOOT OF ACTUAL SURFACE COVERED. ALL FERROUS METALS USED AS PART OF THE FENCE INSTALLATION SHALL BE HOT DIP GALVANIZED OR STAINLESS STEEL. ALL SCREWS, BOLTS, LOCK WASHERS, NUTS, ETC. SHALL BE HOT DIP GALVANIZED OR MADE OF STAINLESS STEEL.

FABRIC - STANDARD INDUSTRIAL GRADE #9 GAUGE WITH 2 INCH MESH ZINC COATED CHAIN LINK WITH A BREAKING STRENGTH OF NOT LESS THAN 1290 POUNDS SHALL BE USED. THE FABRIC SHALL BE ZINC COATED BY THE HOT DIP PROCESS AFTER

METAL POSTS - METAL POSTS (LINE, CORNER, TERMINAL, GATE POSTS, MIDDLE RAILS, BRACES AND TOP RAIL) SHALL BE HOT DIP GALVANIZED SCHEDULE 40 TUBULAR STEEL WITH AN OUTSIDE DIAMETER AS INDICATED ON THE DRAWING. A POST TOP FITTING OF GALVANIZED STEEL WILL BE INSTALLED TO EXCLUDE MOISTURE.

POSTS CAPS - ALL POST CAPS TO USE THE BARBED WIRE OUTRIGGER BRACKET AND SHALL BE ATTACHED TO THE POST WITH TAMPER RESISTANT SCREWS, BRADS, OR BOLTS.

TOP RAIL - A MINIMUM OF ONE COUPLING IN EACH STRAIGHT RUN OF TOP RAIL, SHALL HAVE A HEAVY SPRING INSERTED WITHIN THE COUPLING TO TAKE UP EXPANSION AND CONTRACTION OF THE TOP RAIL. THE TOP RAIL SHALL BE FASTENED TO TERMINAL

MIDDLE RAIL - THE MIDDLE RAIL SHALL BE OF THE SAME MATERIAL AS THE TOP RAIL AND INSTALLED WITH HOT DIP GALVANIZED

BRACE RAIL - BRACE RAIL MATERIAL SHALL BE OF THE MATERIAL AS THE TOP RAIL AND LOCATED 2/3 OF THE DISTANCE UP FROM THE BOTTOM OF THE FABRIC. BRACE RAILS SHALL BE SECURELY FASTENED TO POSTS BY SUITABLE PRESSED STEEL

TRUSS RODS - SHALL BE 3/8" ROUND GALVANIZED STEEL RODS WITH GALVANIZED TURNBUCKLES. THE ZINC COATING SHALL BE NOT LESS THAN 1.2 OUNCES PER SQUARE FOOT OF SURFACE.

TENSION WIRE - THE TENSION WIRE SHALL BE OF #7 GAUGE HOT DIP GALVANIZED SPRING TENSION WIRE WITH A BREAKING STRENGTH OF NOT LESS THAN 1900 POUNDS. THIS WIRE SHALL BE KEPT TAUT WITH GALVANIZED TURNBUCKLES AND ATTACHED TO POSTS WITH GALVANIZED HARDWARE OR CABLE CLAMPS.

FABRIC TIES - THE FABRIC TIES SHALL BE ALUMINUM WIRE, NOT LESS THAN #9 GAGE.

STRETCHER BARS - THE STRETCHER BARS SHALL BE FLAT GALVANIZED STEEL BARS NOT LESS THAN 5/16" x 3/4" AND NOT LESS THAN 2" SHORTER THAN THE FABRIC. STRETCHER BAR BANDS SHALL BE FLAT GALVANIZED STEEL BARS NOT LESS THAN 5/16" x 1-1/2" WITH 5/16" DIAMETER GALVANIZED CARRIAGE BOLT.


BARBED WIRE - BARBED WIRE OF GALVANIZED STEEL (OR ALUMINUM) CONSISTING OF 12 1/2 GAUGE WIRE WITH 4-POINT BARBS OF 14 GAUGE WIRE SPACED 5 INCHES APART.

GATE FRAMES SHALL BE CONSTRUCTED OF 2-1/2 INCH OUTSIDE DIAMETER HEAVY DUTY GALVANIZED STEEL PIPE. THE GATES SHALL BE ASSEMBLED USING CORNER FITTINGS OF HEAVY PRESSED STEEL OR MALLEABLE CASTINGS OR MAY BE WELDED IF THE ENTIRE GATE FRAME IS HOT DIP GALVANIZED AFTER THE WELDING. ALL GATES SHALL BE EQUIPPED WITH HEAVY DUTY GALVANIZED STEEL TYPE HINGES WITH LARGE BEARING SURFACES OF ADEQUATE STRENGTH TO SUPPORT THE GATE. THE HINGES SHALL NOT TWISTED OR TURN UNDER THE ACTION OF THE GATE. GATES WILL PROVIDE A FULL RANGE OF MOTION AND BE EASILY OPENED AND CLOSED BY ONE PERSON. GATE LATCH SHALL BE CARGO PROTECTORS, INC. MODEL FL-100. LATCH SHALL BE EQUIPPED TO RECEIVE A PADLOCK.

METHOD OF FASTENING


STRETCHER BAR TO POST

PROVIDE R.F. WARNING SIGNAGE ON ALL GATES.

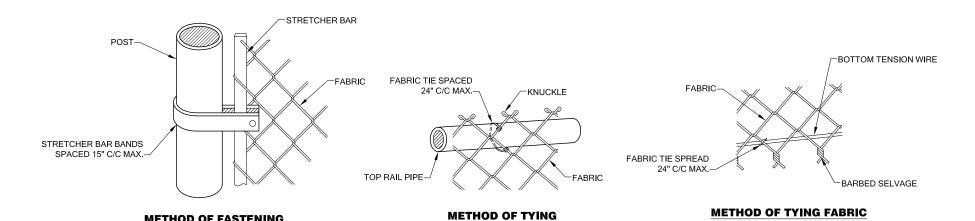

FABRIC TO PIPE



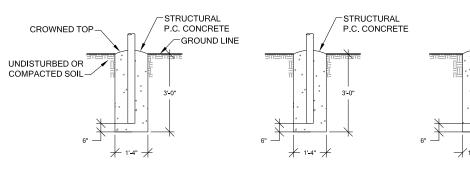

FOOTING FOR TERMINAL OR CORNER POST

FOOTING FOR GATE POST

FOOTING FOR LINE POST

GROUND LINE

POST FOOTING DETAIL SCALE: NTS

TO TENSION WIRE



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CLE ELUM DT US-WA-5105

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ř	=DRAWN BY:====	—СНК. BY:———
ı	JL	BJ

LICENSURE:




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=DRAWING TITLE:===

FENCE DETAILS





ANCHOR NOTE:

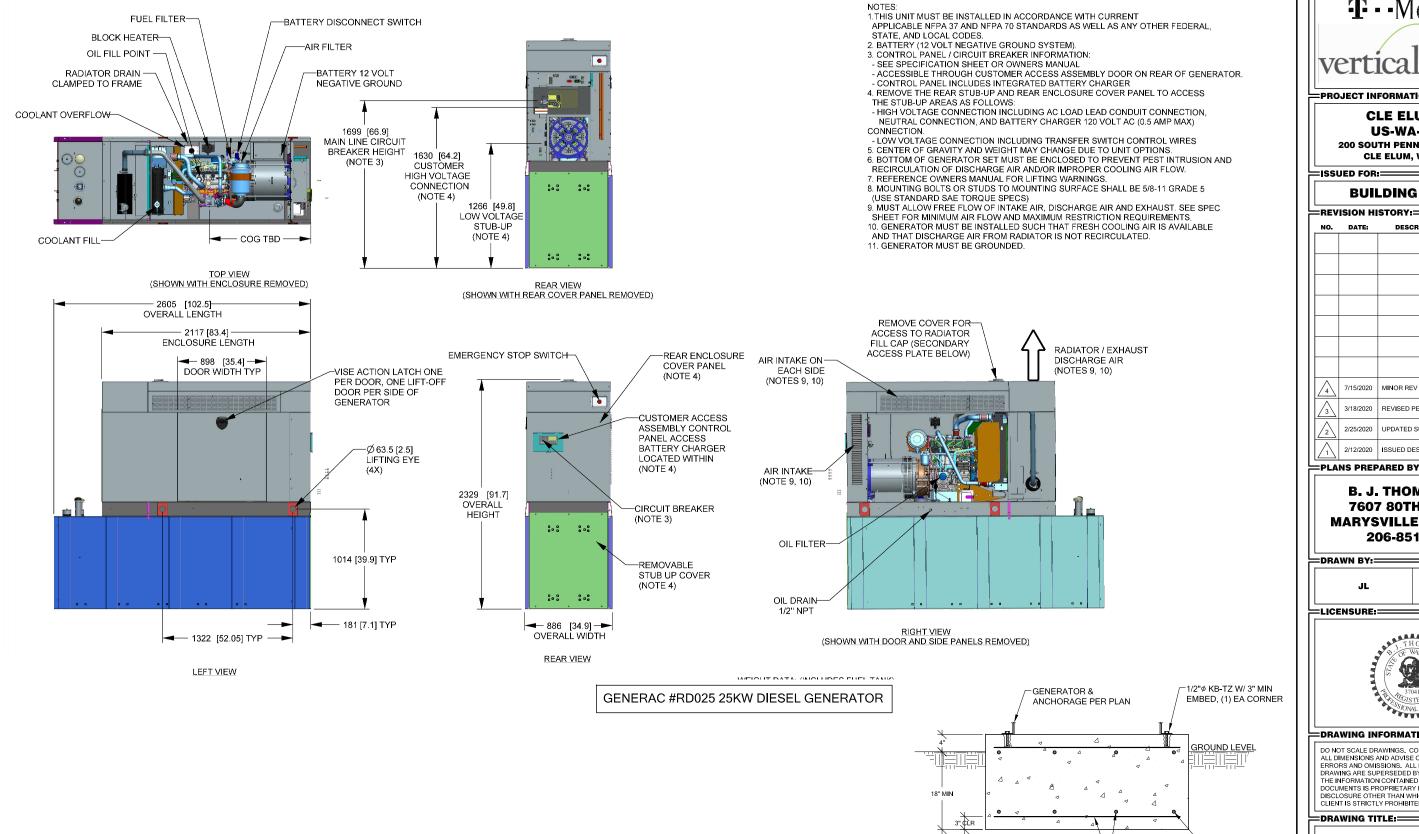1/2" KWIK BOLT TZ W/ 3"

EMBEDMENT AT EACH CORNER.




=PROJECT INFORMATION:=

CLE ELUM DT US-WA-5105

200 SOUTH PENNSYLVANIA AVE CLE ELUM, WA 98922

SSUED FOR:

BUILDING PERMIT

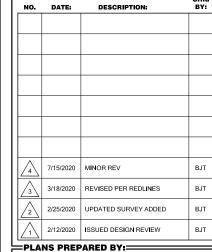

B. J. THOMAS, P.E. **7607 80TH AVE NE MARYSVILLE, WA 98270** 206-851-1106

DRAWN BY: —СНК. ВY:—

ВJ

LICENSURE:



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DRAWING TITLE:

REINF PER PLAN


-#4 REBAR @ 10" O.C.

GENERATOR PAD DETAIL

A-10 SCALE: NTS

TOP & BOTTOM, EA WAY

GENERATOR DETAILS

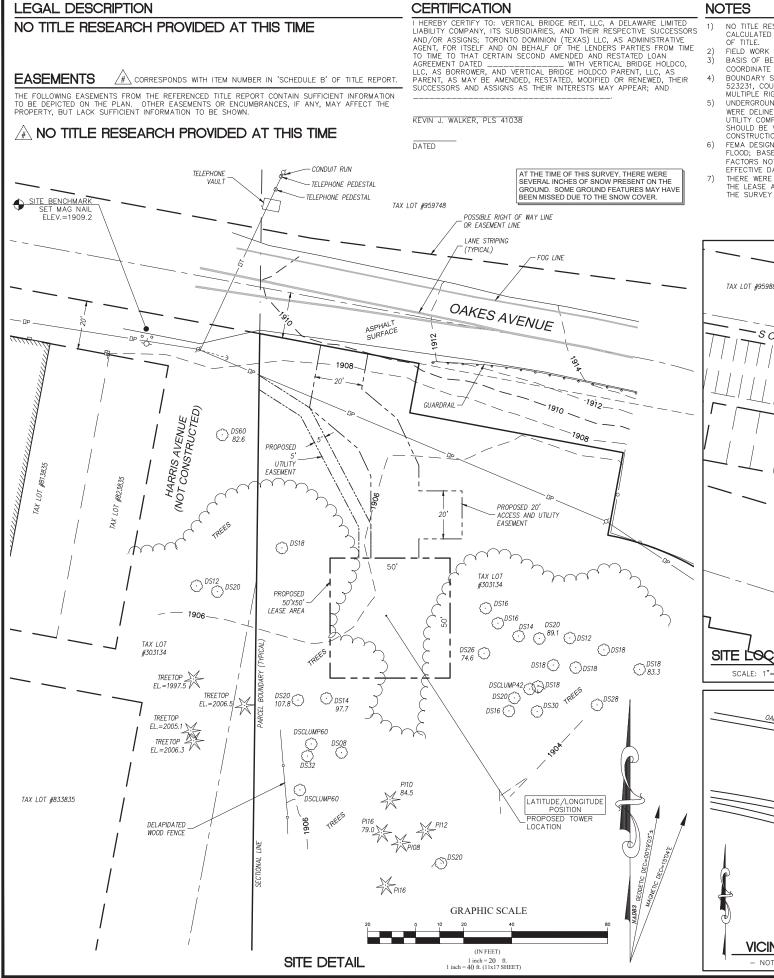

NOTES

- NO TITLE RESEARCH PROVIDED AT THIS TIME. CALCULATED BOUNDARY MAY CHANGE UPON RECEIPT OF TITLE.
- FIELD WORK CONDUCTED IN JANUARY, 2020. BASIS OF BEARING: WASHINGTON STATE PLANE
- COORDINATE SYSTEM, SOUTH ZONE (NAD83).
 BOUNDARY SHOWN BASED ON RECORD OF SURVEY NO. 523231, COUNTY INFORMATION INDICATES POSSIBLE MULTIPLE RIGHTS HAVE THE SAME TAX LOT NUMBER. UNDERGROUND UTILITIES SHOWN HEREON, IF ANY,
- UNDERGROUND UTILITIES SHOWN HEREON, IF ANY, WERE DELINEATED FROM SURFACE EVIDENCE AND/OR UTILITY COMPANY RECORDS. CRITICAL LOCATIONS SHOULD BE VERIFIED PRIOR TO DESIGN AND CONSTRUCTION.
 FEMA DESIGNATION: ZONE A (AREAS OF 100—YEAR FLOOD; BASE FLOOD ELEVATIONS AND FLOOD HAZARD
- FLOOD; BASE FLOOD ELEVATIONS AND FLOOD HAZARD FACTORS NOT DETERMINED) PANEL 5300960001B, EFFECTIVE DATE MAY, 1981.

 THERE WERE NO VISIBLE ENCROACHMENTS AFFECTING THE LEASE AREA OR OTHER EASEMENTS AT THE TIME THE SURVEY WAS COMPLETED.

LATITUDE/LONGITUDE POSITION

COORDINATE DATA AT PROPOSED TOWER LOCATION:

NAD 83 LAT - 47*11'32.69" N LONG - 120*56'12.53" W

LONG - 120.936814* W


NAVD 88 ELEV.= 1905.6 FEET 47.192414* N BENCHMARK IS BASED ON

> ELEVATION DERIVED USING GPS. ACCURACY MEETS OR EXCEEDS

1A STANDARDS AS DEFINED ON THE FAA ASAC INFORMATION SHEET 91:003.

WSRN REFERENCE NETWORK

TAX LOT #95988 -SOAKESAVE-TAX LOT #618936 PARENT PARCEL TAX LOT #303134 LATITUDE/LONGITUDE POSITION PROPOSED TOWER INTERSTATE HWY 90 SITE L'OCATION

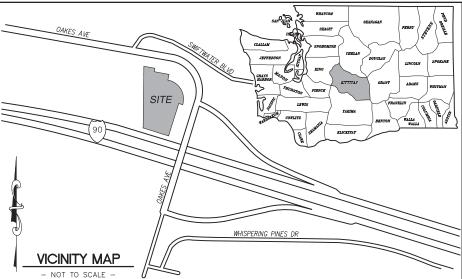

LEGEND

	SUBJECT BOUNDARY LINE
	- RIGHT-OF-WAY CENTERLINE
	RIGHT-OF-WAY LINE
	- ADJACENT BOUNDARY LINE
· ·	- SECTIONAL BREAKDOWN LIN
——————————————————————————————————————	- OVERHEAD POWER LINE
	- BURIED POWER LINE
——————————————————————————————————————	- BURIED GAS LINE
	- OVERHEAD TELEPHONE LINE
UT	- BURIED TELEPHONE LINE
v	- BURIED WATER LINE
	- BURIED SANITARY SEWER
SD	- BURIED STORM DRAIN
	- DITCH LINE/FLOW LINE
~~~~~~~~~~~~~~~~~~~~~~~~~~~~~~~~~~~~~~~	
$\bigcirc \bigcirc $	\ VEGETATION LINE
o	- CHAIN LINK FENCE
	- WOOD FENCE
x	- BARBED WIRE/WIRE FENCE
△ TRANSFORMER	-Q- FIRE HYDRANT
X LIGHT STANDARD	⋈ GATE VALVE
P POWER VAULT	₩ WATER METER
☑ UTILITY BOX	Q FIRE STAND PIPE
Ø UTILITY POLE	IRRIGATION CONTROL
← POLE GUY WIRE	☐ CATCH BASIN, TYPE
DOI GAS VALVE	CATCH BASIN, TYPE

# ABOVE GROUND LEVEL (AGL) AND ARE ACCURATE TO \$\frac{1}{2}\$. O.5 FEET OR \$\pm\$ 1% OF TOTAL HEIGHT, WHICHEVER IS GREATER.

O GAS METER

TEL. MANHOLE

T TELEPHONE VAULT



TELEPHONE RISER .234.21 SPOT ELEVATION

1) ALL FLEVATIONS SHOWN ARE ABOVE MEAN SEA LEVEL (AMSL) AND ARE REFERENCED TO THE NAVD88 DATUM

2) ALL TOWER, TREE AND APPURTENANCE HEIGHTS ARE

BOLLARD

□ MAIL BOX

CH=CHERRY

EVERGREEN TREE CF=CFDAR DF=DOUGLAS FIR HE=HEMLOCK PI=PINE EVG=EVERGREEN

HEIGHT AGL IF MEASURED

NOIE:
TREE DRIP LINES ARE NOT TO SCALE. TREE SYMBOLS
REFERENCE TRUNK LOCATION ONLY. TRUNK DIAMETERS
WERE APPROXIMATED AT 3.5' TO 4' ABOVE GROUND LEVEL.
TREES SHOWN ARE FOR REFERENCE ONLY AND OTHER
TREES AND VEGETATION MAY EXIST.

#### SITE INFORMATION

303134 MAP #20-15-26034-0002 TAX LOT NUMBER

SITE CONTACT PHONE NUMBER ZONING

67 SERVICES GOVERNMENTAL (CITY OF CLE ELUM) TO BE DETERMINED 2500 S.F.

TOTAL LOT AREA

#### SURVEY REFERENCE

- RECORD OF SURVEY PER A.F. NO. 523231, RECORDS OF KITTITAS COUNTY.
- RECORD OF SURVEY PER A.F. NO. 200412170002, RECORDS OF KITTITAS COUNTY

#### **BOUNDARY DISCLAIMER**

THIS PLAN DOES NOT REPRESENT A BOUNDARY SURVEY. SUBJECT AND ADJACENT PROPERTY LINES ARE DEPICTED USING FIELD—FOUND EVIDENCE AND RECORD INFORMATION.

#### CAUTION!

UNDERGROUND UTILITIES EXIST IN THE AREA AND UTILITY INFORMATION SHOWN MAY BE INCOMPLETE ONE—CALL UTILITY LOCATE SERVICE AT LEAST 48
HOURS BEFORE STARTING ANY CONSTRUCTION.

1-800-424-5555



VERTICAL BRIDGE HOLDINGS, LLC 750 PARK OF COMMERCE DRIVE. BOCA RATON FL 33487

SURVEY PREPARED BY



DUNCANSON Company, Inc.

145 SW 155th Street, Suite 102 Seattle, Washington 98166 Phone 206.244.4141 Fax 206.244.4455

B.J. THOMAS. PE

#### CLE ELUM DT US-WA-5105

S 1/2 S 26 T20N R15F WM CLE ELUM, WA 98922 KITTITAS COUNTY

THIS DRAWING WAS CREATED FOR THE COLUSIVE USE OF THE CLIENT NAMED HEREON ND IS NOT TO BE USED IN WHOLE OR IN PART WITHOUT WRITTEN AUTHORIZATION FROM


SAID CLIENT. ©2019, DUNCANSON COMPANY, INC.

FLD. CREW:	CR/CB
FLD. BOOK:	543/98
DRAWN BY:	LAC
JOB #:	01808.1634
DATE:	02/03/20

REVISIONS				
DATE	DESCRIPTION	BY		
2/24/20	ADD LEASE AND ACCESS UTILITY EASEMENTS	KJW		
410.5s				

SHEET TITLE EXISTING SITE SURVEY SEC 26, TWP 20 N, RNG 15 E, WM

> SHEET NUMBER SV₁

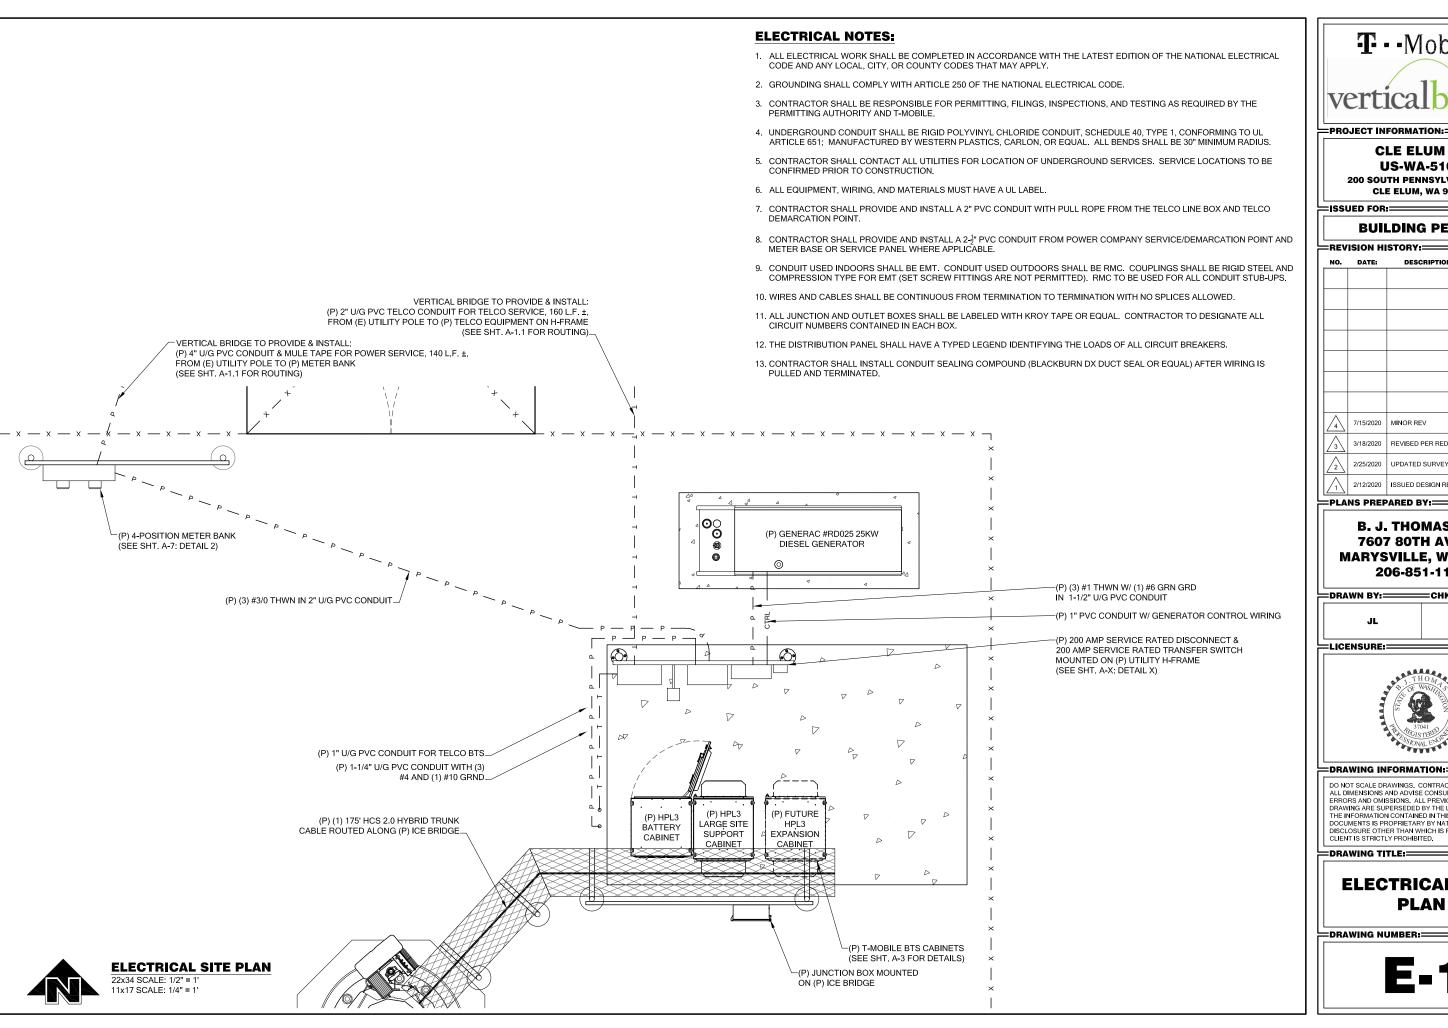



==PROJECT INFORMATION:=

#### **CLE ELUM DT** US-WA-5105

200 SOUTH PENNSYLVANIA AVE CLE ELUM, WA 98922

#### =ISSUED FOR:=

#### **BUILDING PERMIT**

-nev	=REVISION HISTORY:=		
NO.	DATE:	DESCRIPTION:	BY:
4	7/15/2020	MINOR REV	BJT
3	3/18/2020	REVISED PER REDLINES	ВЈТ
2	2/25/2020	UPDATED SURVEY ADDED	BJT
/1	2/12/2020	ISSUED DESIGN REVIEW	BJT

B. J. THOMAS, P.E. **7607 80TH AVE NE** MARYSVILLE, WA 98270 206-851-1106

DRAWN BY: CHK. BY:

=LICENSURE:=




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#### ==DRAWING TITLE:====

# **ELECTRICAL SITE PLAN**

=DRAWING NUMBER:====




#### LOAD CALCS:

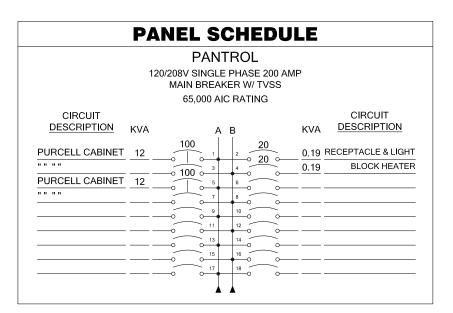(5) 3 KW RECTIFIERS = 15 KVA

RECEPTACLE & LIGHT = 0.19 KVA

BLOCK HEATER = 0.19 KVA

TOTAL 15.38 KVA
64 AMPS

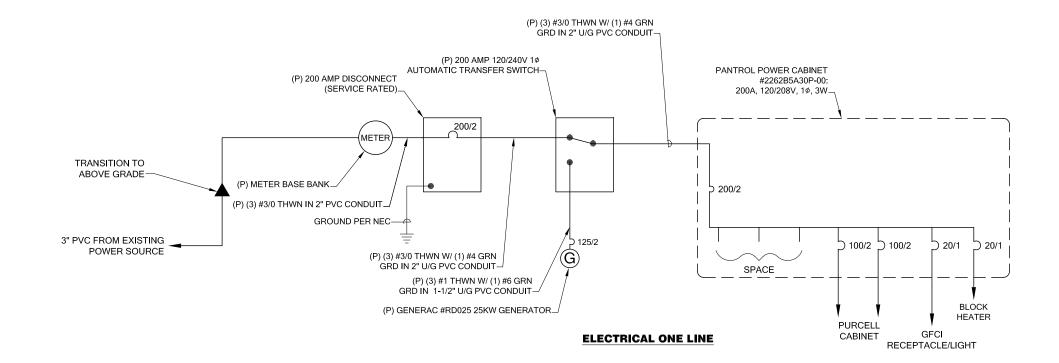



PROJECT INFORMATION:

#### CLE ELUM DT US-WA-5105

200 SOUTH PENNSYLVANIA AVE CLE ELUM, WA 98922

ISSUED FOR:

#### BUILDING PERMIT

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/1\	2/12/2020	ISSUED DESIGN REVIEW	ВЈТ

PLANS PREPARED BY:

B. J. THOMAS, P.E. 7607 80TH AVE NE MARYSVILLE, WA 98270 206-851-1106

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LICENSURE:



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DRAWING TITLE:

# ELECTRICAL DETAILS

DRAWING NUMBER:

E-1.1

# BOND GATE POST TO (P) SITE GROUND RING. BOND GATE POST TO GATE -BOND H-FRAME POSTS AND MOUNTED (P) GROUND INSPECTION WELL EQUIPMENT TO (P) GROUND RING-(P) MECHANICAL CONNECTION (TYP) (SEE GROUNDING NOTES #4 & #6) BOND H-FRAME POSTS AND MOUNTED EQUIPMENT TO (P) GROUND RING-(P) GROUND INSPECTION WELL (SEE SHT. E-3, DETAIL 4). (P) #2 SOLID BARE TINNED COPPER WIRE (SITE GROUND RING). BOND BTS EQUIPMENT TO (P) MGB W/ #2 GREEN STRANDED THWN (TYP) (SEE SHT. E-4, DETAIL 5) (P) AGB AT TOP OF POLE DIRECTLY BELOW ANTENNA ARRAY (SEE GROUNDING NOTE #5)_ BOND (P) MGB AT BOTTOM OF POLE TO (P) MGB NEAR BTS EQUIPMENT (P) MGB AT BOTTOM OF POLE (SEE GROUNDING NOTE #5) BOND (P) AGB TO (P) MGB (P) #2 SOLID BARE TINNED COPPER (POLE GROUND RING) (P) GROUND RODS (TYP OF 3) AROUND (P) POLE GROUND RING-BOND (4) CORNER FENCE POST (P) CADWELD BOND (TYP) TO (P) SITE GROUNDING (SEE GROUNDING NOTE #4) (SEE SHT. E-3 FOR ADDITIONAL INFORMATION)

#### **SYMBOL LEGEND:**

MGB
MASTER GROUND BAR 1/4"x4"x24"
COPPER

AGB ACCESSORY GROUND BAR 1/4"x4"x12" OR 1/4"x4"x20" COPPER

EXPOSED WIRING

---- UNDERGROUND WIRING

- CADWELD
- MECHANICAL CONNECTION
- 5/8"x8' COPPER CLAD STEEL GROUND ROD

(INSPECTION POR

■ -- EXOTHERMIC (CADWELD) BELOW GROUND

ot GROUND

BOND FROM (P) GENERATOR TO (P) MGB

(P) MGB NEAR BTS EQUIPMENT MOUNTED TO ICEBRIDGE (SEE GROUNDING NOTE #5)

BOND (P) MGB TO (P) SITE GROUND RING

#### **GROUNDING NOTES:**

- GROUNDING SHALL COMPLY WITH LATEST EDITION OF THE NATIONAL ELECTRICAL CODE.
- 2. MINIMUM BENDING RADIUS FOR GROUND CONDUCTOR IS 8".
- 3. NO SPLICES PERMITTED IN GROUND CONDUCTORS.
- ALL GROUNDING CONNECTORS TO BE CLEAN AND FREE OF PAINT AT THEIR MATING SURFACES AND INSTALLED PER MANUFACTURER'S RECOMMENDATIONS. USE PENETROX OR EQUIVALENT ANTIOXIDANT GREASE.
- 5. ALL GROUND BAR CONNECTIONS ARE TO BE 2 HOLE LUG COMPRESSION TYPE. STACKED CONNECTIONS ARE NOT ACCEPTABLE. BACK TO BACK CONNECTIONS ON OPPOSITE SIDES OF THE GROUND BAR WILL BE PERMITTED.
- 6. ENSURE ALL MECHANICAL CONNECTORS ARE TORQUED TO THE MANUFACTURER'S SPECIFIED VALUES.
- 7. MULTIPLE BONDS ON GROUND RODS TO BE SEPARATED BY ATLEAST 6".
- 8. MAXIMUM RESISTANCE OF THE COMPLETED GROUND SYSTEM SHALL NOT EXCEED A RESISTANCE OF 5 OHMS TO EARTH.
- 9. GROUND WIRES SHALL NOT BE INSTALLED THROUGH HOLES IN ANY METAL OBJECTS OR SUPPORTS; TO PRECLUDE ESTABLISHING A "CHOKE" POINT
- 10. GROUND BARS SHALL NOT BE FIELD MODIFIED.
- 11. GROUND RING BURIAL DEPTH SHALL BE 30".
- 12. A CERTIFIED CONTRACTOR WILL MAKE ALL MEASUREMENTS REQUIRED TO TEST THE GROUNDING SYSTEM USING A MEGGER OR EQUIVALENT. THE ACCEPTABLE RESISTANCE MEASURED FOR THE GROUNDING SYSTEM WILL NOT EXCEED 5 OHMS RESISTANCE. THREE DISTANCES SHALL BE USED: 1 AT 100 FEET, 1 AT 70 FEET, AND 1 AT 35 FEET. THESE DISTANCES ARE SUBJECT TO A SITE BY SITE BASIS. T-MOBILE-WTS SHALL BE GIVEN 24 HOURS NOTICE. ALL COSTS ASSOCIATED WITH GROUND TESTING WILL BE AT THE EXPENSE OF THE CONTRACTOR.



=PROJECT INFORMATION:=

CLE ELUM DT
US-WA-5105
200 SOUTH PENNSYLVANIA AVE

CLE ELUM, WA 98922

ISSUED FOR:=

REVISION HISTORY:=

BUILDING PERMIT

NO. DATE: DESCRIPTION:		DESCRIPTION:	BY:
4	7/15/2020	MINOR REV	BJT
3	3/18/2020	REVISED PER REDLINES	BJT
2	2/25/2020	UPDATED SURVEY ADDED	BJT
1	2/12/2020	ISSUED DESIGN REVIEW	BJT

PLANS PREPARED BY:

B. J. THOMAS, P.E. 7607 80TH AVE NE MARYSVILLE, WA 98270 206-851-1106

DRAWN BY:	<b>=СНК. ВҮ:</b> ===
JL	BJ

=LICENSURE:=



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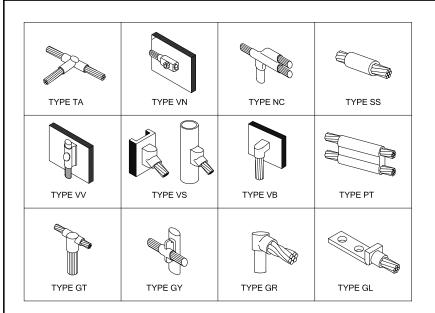
ELECTRICAL GROUNDING PLAN

DRAWING NUMBER:

**E-2** 


1 ELECTRICAL GROUNDING PLAN
E-2 22x34 SCALE: 1/2" = 1'

11x17 SCALE: 1/4" = 1'




TYPICAL CADWELD CONNECTIONS

E-3 N.T.S.

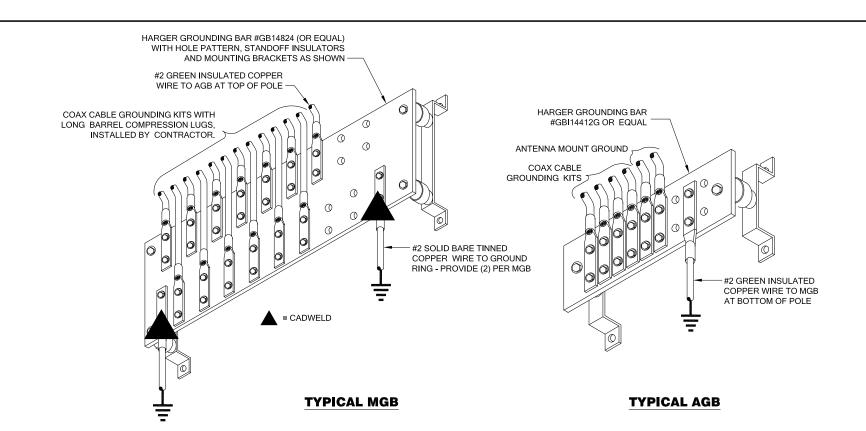





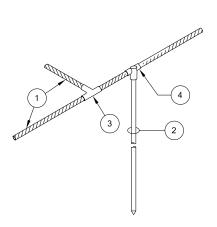

- 1 MAIN CONDUCTOR, COPPER CABLE
- 2 5/8"x8' COPPER CLAD STEEL GROUND ROD
- 3 CADWELD TYPE "TA"
- 4 CADWELD TYPE "GT"



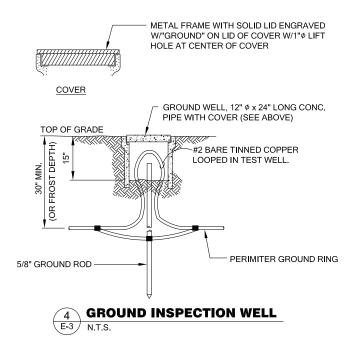

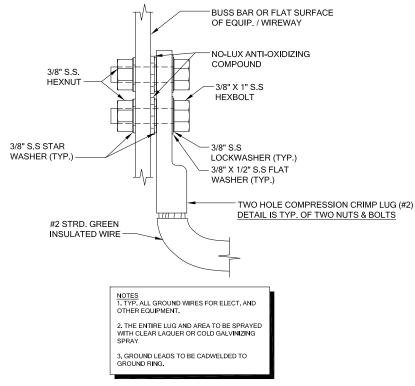

**TYPICAL CABINET GROUNDING DETAIL** 

T - Mobile-

PROJECT INFORMATION:

#### CLE ELUM DT US-WA-5105

200 SOUTH PENNSYLVANIA AVE CLE ELUM, WA 98922

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PLANS PREPARED BY:

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i	=DRAWN BY:====	<b>≕СНК. ВҮ:</b>
	JL	BJ

LICENSURE:=



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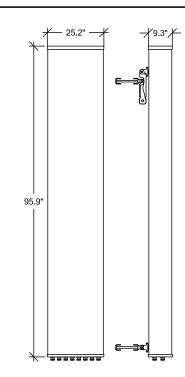
# ELECTRICAL GROUNDING DETAILS

DRAWING NUMBER:

**E-3** 

#### SITE LOADING CHART

SECTOR	COLOR	ANTENNA MODEL #	VENDOR	AZIMUTH (TN)	MECHANICAL DOWNTILT	ELECTRICAL DOWNTILT	RADIATION CENTER	HYBRID CABLE LENGTH	COAX CABLES
ALPHA	RED	FFHH-65C-R3	COMMSCOPE	120°	0°	TBD	156'-0" AGL		
BETA	GREEN	FFHH-65C-R3	COMMSCOPE	250°	0°	TBD	156'-0" AGL	(1) 175' HCS 2.0 HYBRID TRUNK CABLE	N/A
GAMMA	BLUE	FFHH-65C-R3	COMMSCOPE	320°	0°	TBD	156'-0" AGL		



CON	/MS	C	OPE	ΑI	NTENN	A DA	<b>T</b> A	1	
MECHANICAL SPECIFICATIONS									
PART NUMBER		HEIGHT		WIDTH	DEP	DEPTH		WEIGHT	
FFHH-65C-R3		95	.9 in		25.2 in	9.3 in		127.6 lbs	
CONNECTORS	NDA	DARD MOUNTING HARD			WARE				
(8) 7-16 DIN	INCL	.UDED							
ELECTRICAL S	SPECI	FIC	ATION	ıs					
FREQUENCY	POLARIZATION GAIN AZIMUTH B.					W.			
617-2360 MHz	±45°	±45° 15.			8-19.6 dBi	55°- 67°			
	VSW	7	MAX II	NPU	T POWER	ELEVA	TION	IB.V	٧.
	<1.5:1		300 W	ATT	S	4.4° - 1	0.2°		

**T** - Mobile-

PROJECT INFORMATION:

#### CLE ELUM DT US-WA-5105

200 SOUTH PENNSYLVANIA AVE CLE ELUM, WA 98922

ISSUED FOR:

#### BUILDING PERMIT

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$\Lambda$	2/12/2020	ISSUED DESIGN REVIEW	BJT

PLANS PREPARED BY:

B. J. THOMAS, P.E. 7607 80TH AVE NE MARYSVILLE, WA 98270 206-851-1106

BJ

Ų	<b>⊟DRAWN</b>	BY	 снк.	BY

LICENSURE:



#### DRAWING INFORMATION:


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**RF DETAILS** 

DRAWING NUMBER:

RF-1



T - - Mobile -
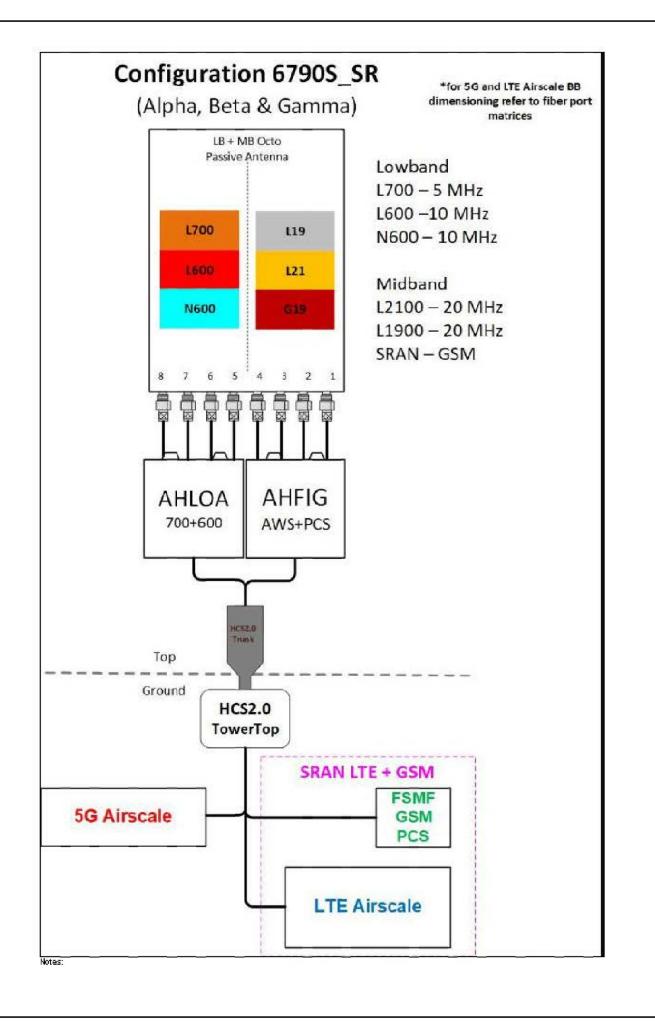
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200 SOUTH PENNSYLVANIA AVE CLE ELUM, WA 98922

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DRAWING NUMBER:

**RF-2**