BLUELINE 25 CENTRAL WAY, SUITE 400, KIRKLAND, WA 98033 P: 425.216.4051 F: 425.216.4052 WWW.THEBLUELINEGROUP.COM AS NOTED PROJECT MANAGER: BRETT K. PUDISTS, PE PROJECT ENGINEER: LYNDSEY FEDAK, PE CHRIS WISCOMB 1/5/2021

PROJECT TEAM

**OWNER/APPLICANT** CITY HEIGHTS HOLDINGS, LLC 116 1/2 S. WASHINGTON STREET

CIVIL ENGINEER

25 CENTRAL WAY, SUITE 400 KIRKLAND, WA 98033 (425) 216–4051

CONTACT: TED SCHEPPER CONTACT: BRETT PUDISTS, PE

WETLAND CONSULTANT SEWALL WETLAND CONSULTING, INC FALL CITY, WA 98024

CITY HEIGHTS IS AN APPROVED PLANNED MIXED USE DEVELOPMENT (PMU) SUBJECT TO APPROVED DEVELOPMENT AGREEMENT VESTING THE PROJECT TO SPECIFIED STANDARDS.

SURVEYOR

407 SWIFTWATER BLVD

CONTACT: MARC KIRKPATRICK

12220 113TH AVE NE, SUITE 130

CLE ELUM, WA 98922

(509) 674-7433

GEOTECH

TERRA ASSOCIATES

(425) 821-7777

ENCOMPASS

- REFER TO CITY ORDINANCE 1353 (PLANNED ACTION ORDINANCE) AND THE NOVEMBER 2011 CITY HEIGHTS ANNEXATION AND DEVELOPMENT AGREEMENT FOR DETAILS.
- REFER TO MASTER SITE PLAN IN D.A. FOR DEVELOPMENT PODS.
- THE CITY HEIGHTS PROJECT IS APPROVED TO BE BUILT OUT IN PHASES OVER
- BASE MAP INFO UNLESS OTHERWISE NOTED, BASE MAP INFO SHOWN IS PER FILES PROVIDED BY ENCOMPASS ENGINEERING AND SURVEYING.

### EXISTING UTILITY NOTE

EXISTING UTILITIES ARE SHOWN IN THE APPROXIMATE LOCATION. THERE IS NO GUARANTEE THAT ALL UTILITY LINES ARE SHOWN, OR THAT THE LOCATION, SIZE AND MATERIAL IS ACCURATE. THE CONTRACTOR SHALL UNCOVER ALL INDICATED PIPING WHERE CROSSING, INTERFERENCES, OR CONNECTIONS OCCUR PRIOR TO TRENCHING OR EXCAVATION FOR ANY PIPE OR STRUCTURES, TO DETERMINE ACTUAL LOCATIONS, SIZE AND MATERIAL. THE CONTRACTOR SHALL MAKE THE APPROPRIATE PROVISION FOR PROTECTION OF SAID FACILITIES. THE CONTRACTOR SHALL NOTIFY ONE CALL AT 8-1-1 (WASHINGTON811.COM) AND ARRANGE FOR FIELD LOCATION OF EXISTING FACILITIES BEFORE CONSTRUCTION.

CITY HEIGHTS NOTES

K. PUD WASHING
37925 SONAL ENG

1/5/21

JOB NUMBER:

19-349

SHEET NAME: CV-01

\_ of \_**23** 


្ងី 🧟 ដ 📗 **© 2021 BLUELINE** 


 SD PIPE FLOW *TO BE SAVED* DECIDUOUS TREE STORM CLEANOUT **♦** STORM DRAIN STUB ASPHALT ⇒ STORM CULVERT END ○ SEWER MANHOLE CONCRETE SEWER CLEANOUT GRAVEL SS PIPE FLOW ♦ SEWER STUB **₩ETLAND** SEPTIC LID ≥40% SLOPE **⊞** WATER METER ⋈ GATE VALVE

60' WDE 70' WIDE

> ALLOWED UNITS PER DEVELOPMENT POD ALLOWED PROPOSED REMAINING DEVELOPMENT DENSITY AREA DENSITY DENSITY 215 ERUs 50 ERUs

NOTE: ALLOWED DENSITY PER APPENDIX A OF DA.

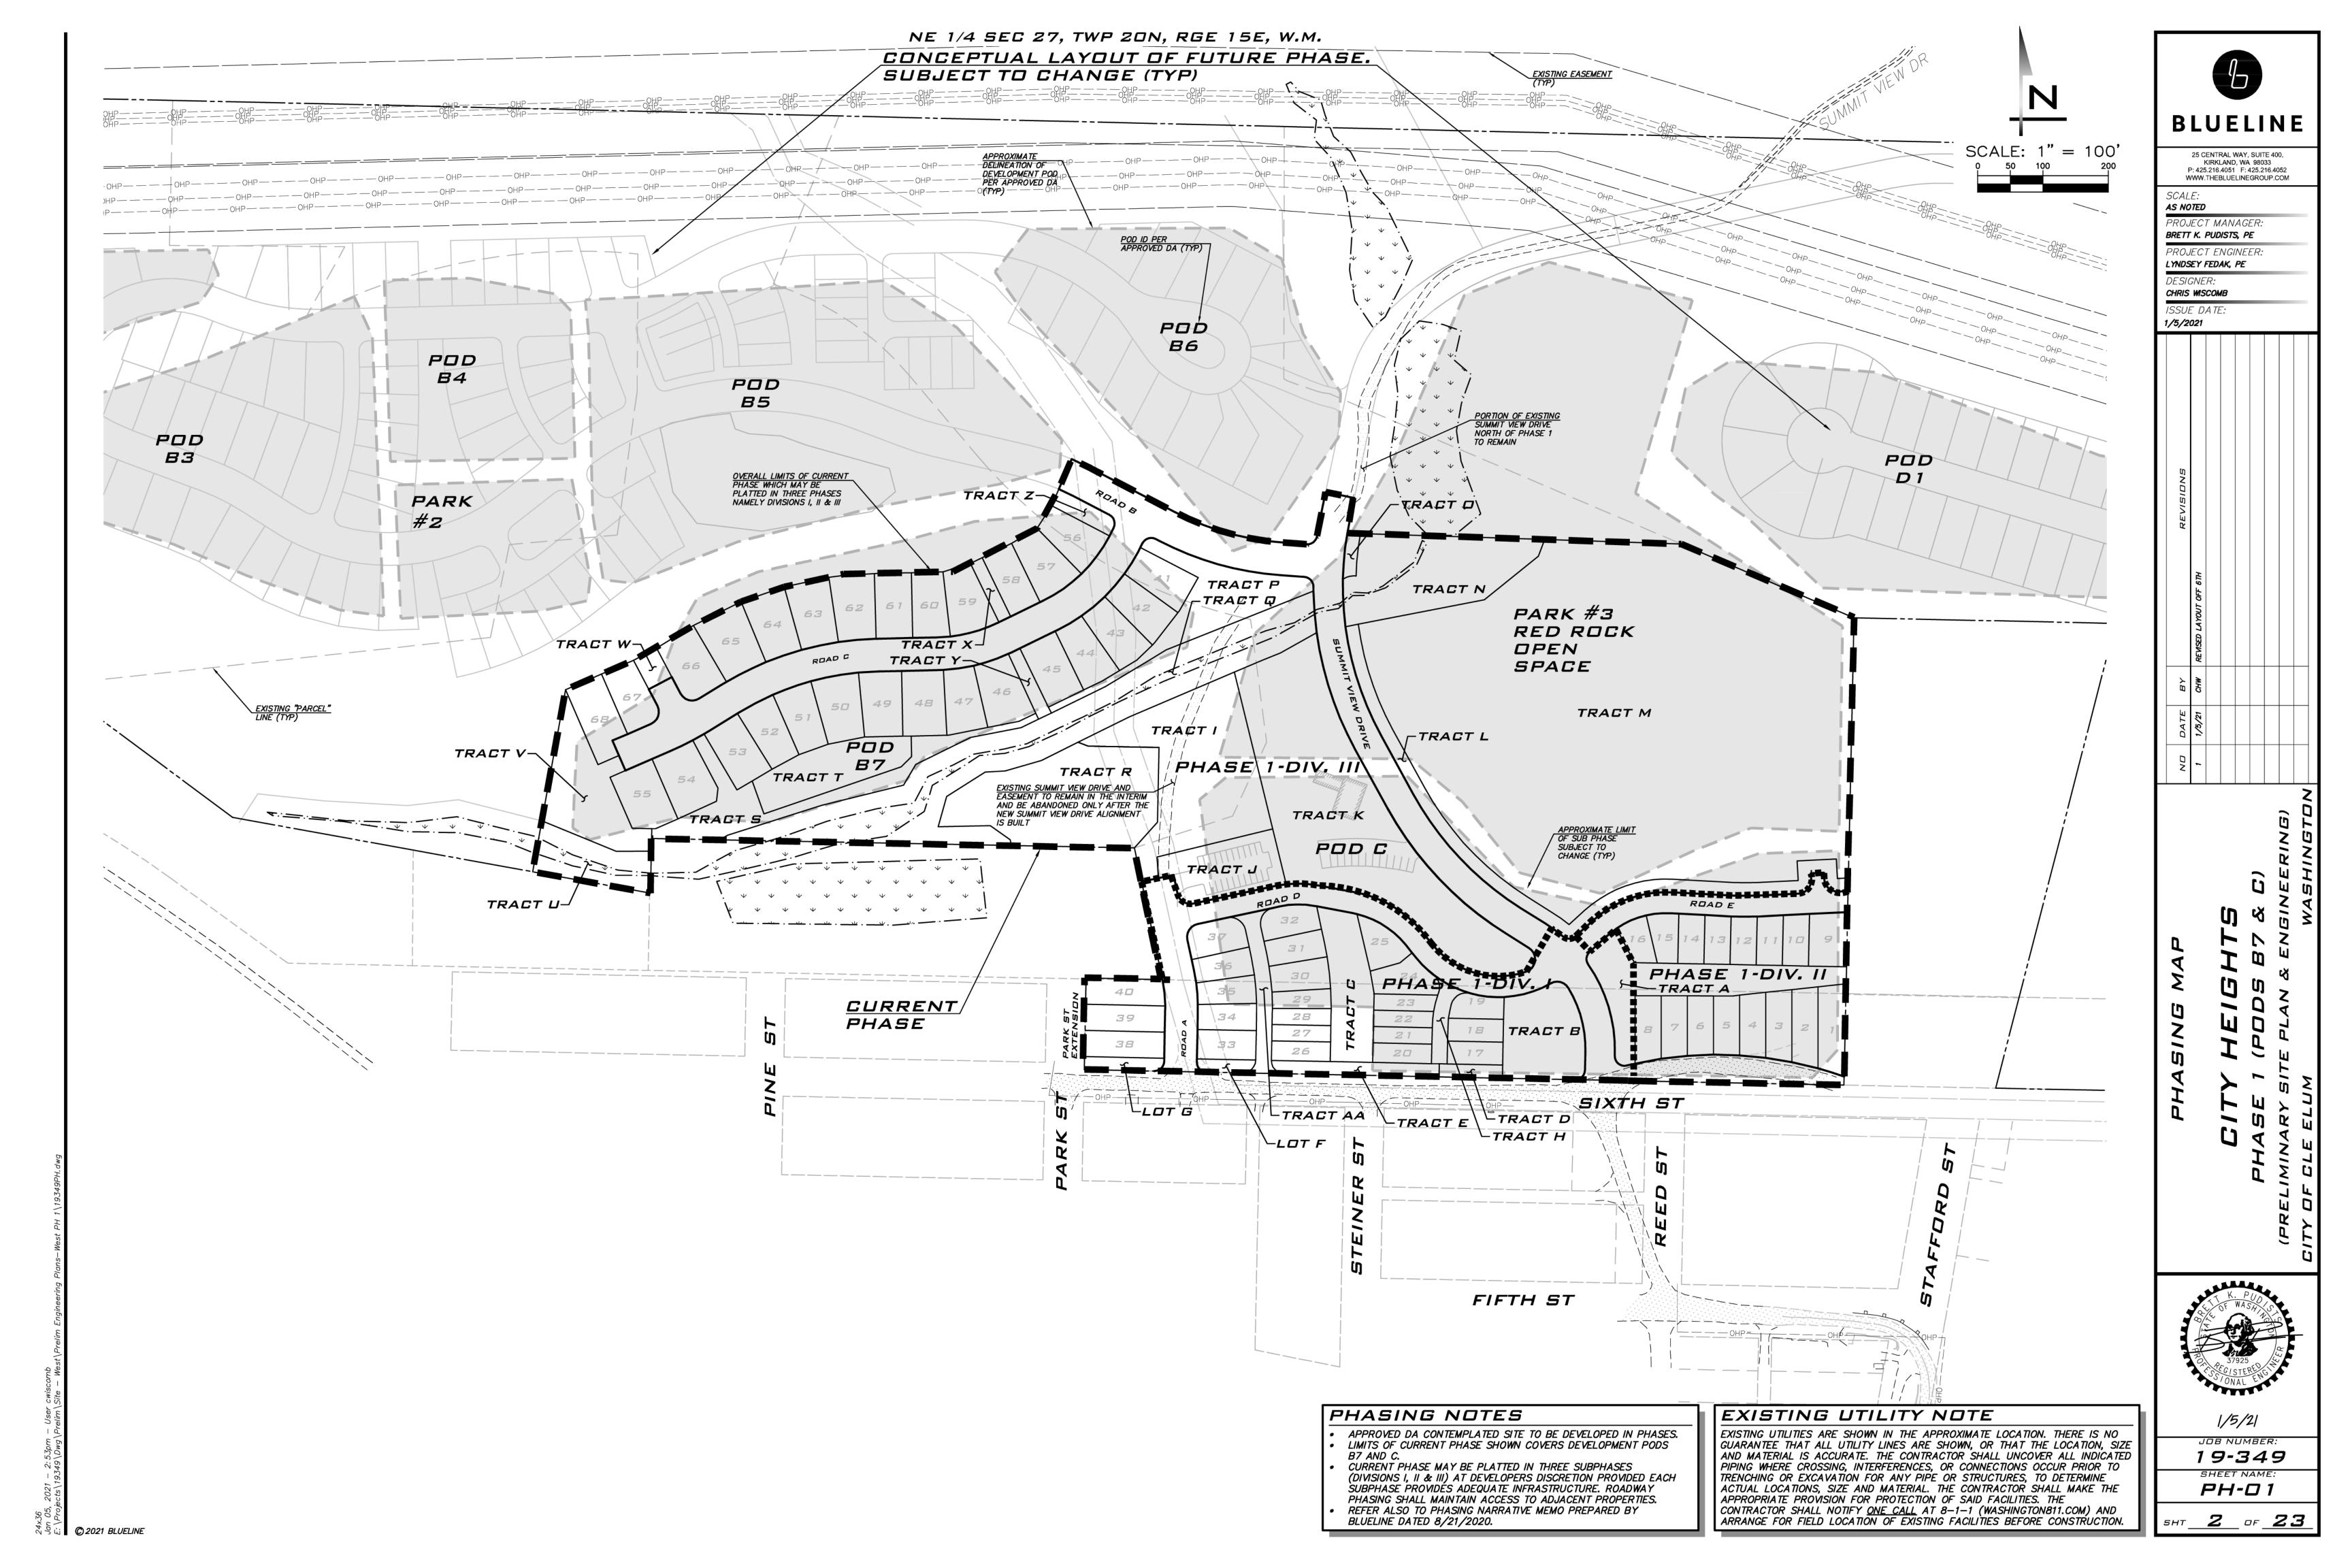

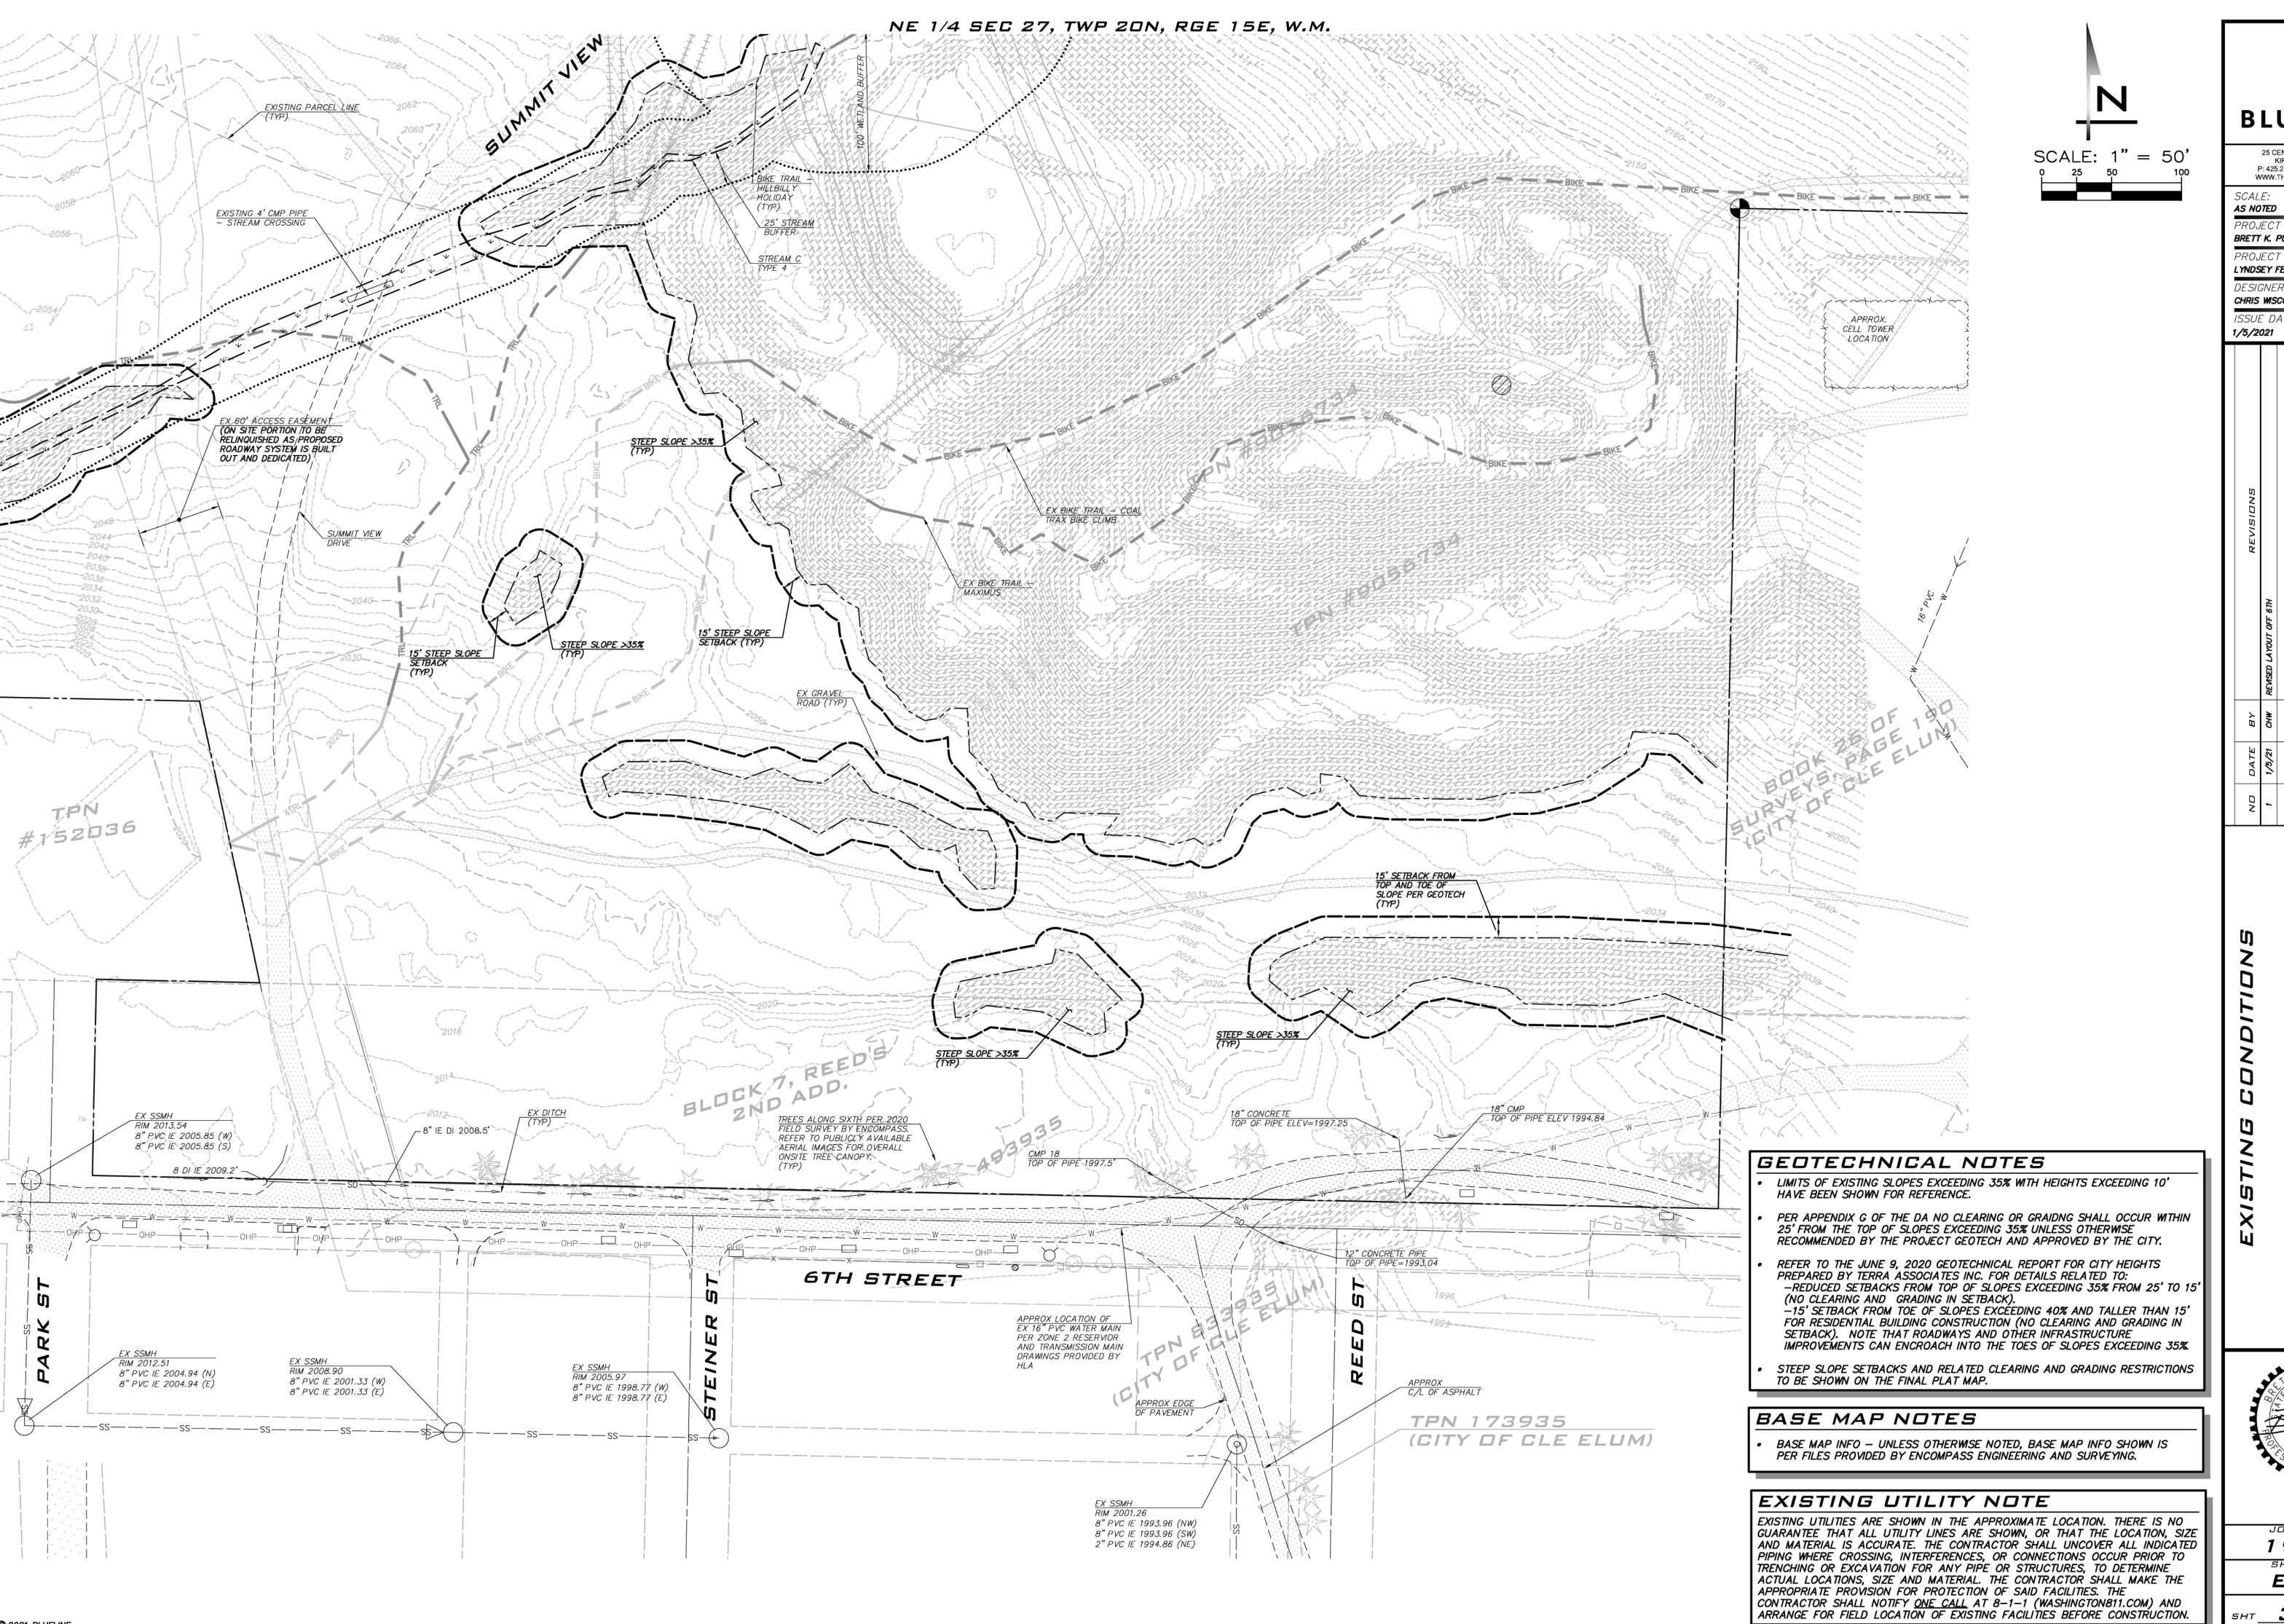

BLUELINE

25 CENTRAL WAY, SUITE 400, KIRKLAND, WA 98033 P: 425.216.4051 F: 425.216.4052 WWW.THEBLUELINEGROUP.COM

PROJECT MANAGER: BRETT K. PUDISTS, PE


PROJECT ENGINEER: LYNDSEY FEDAK, PE

CHRIS WISCOMB

1/5/21

19-349 EC-01

<u>3</u> of <u>23</u>

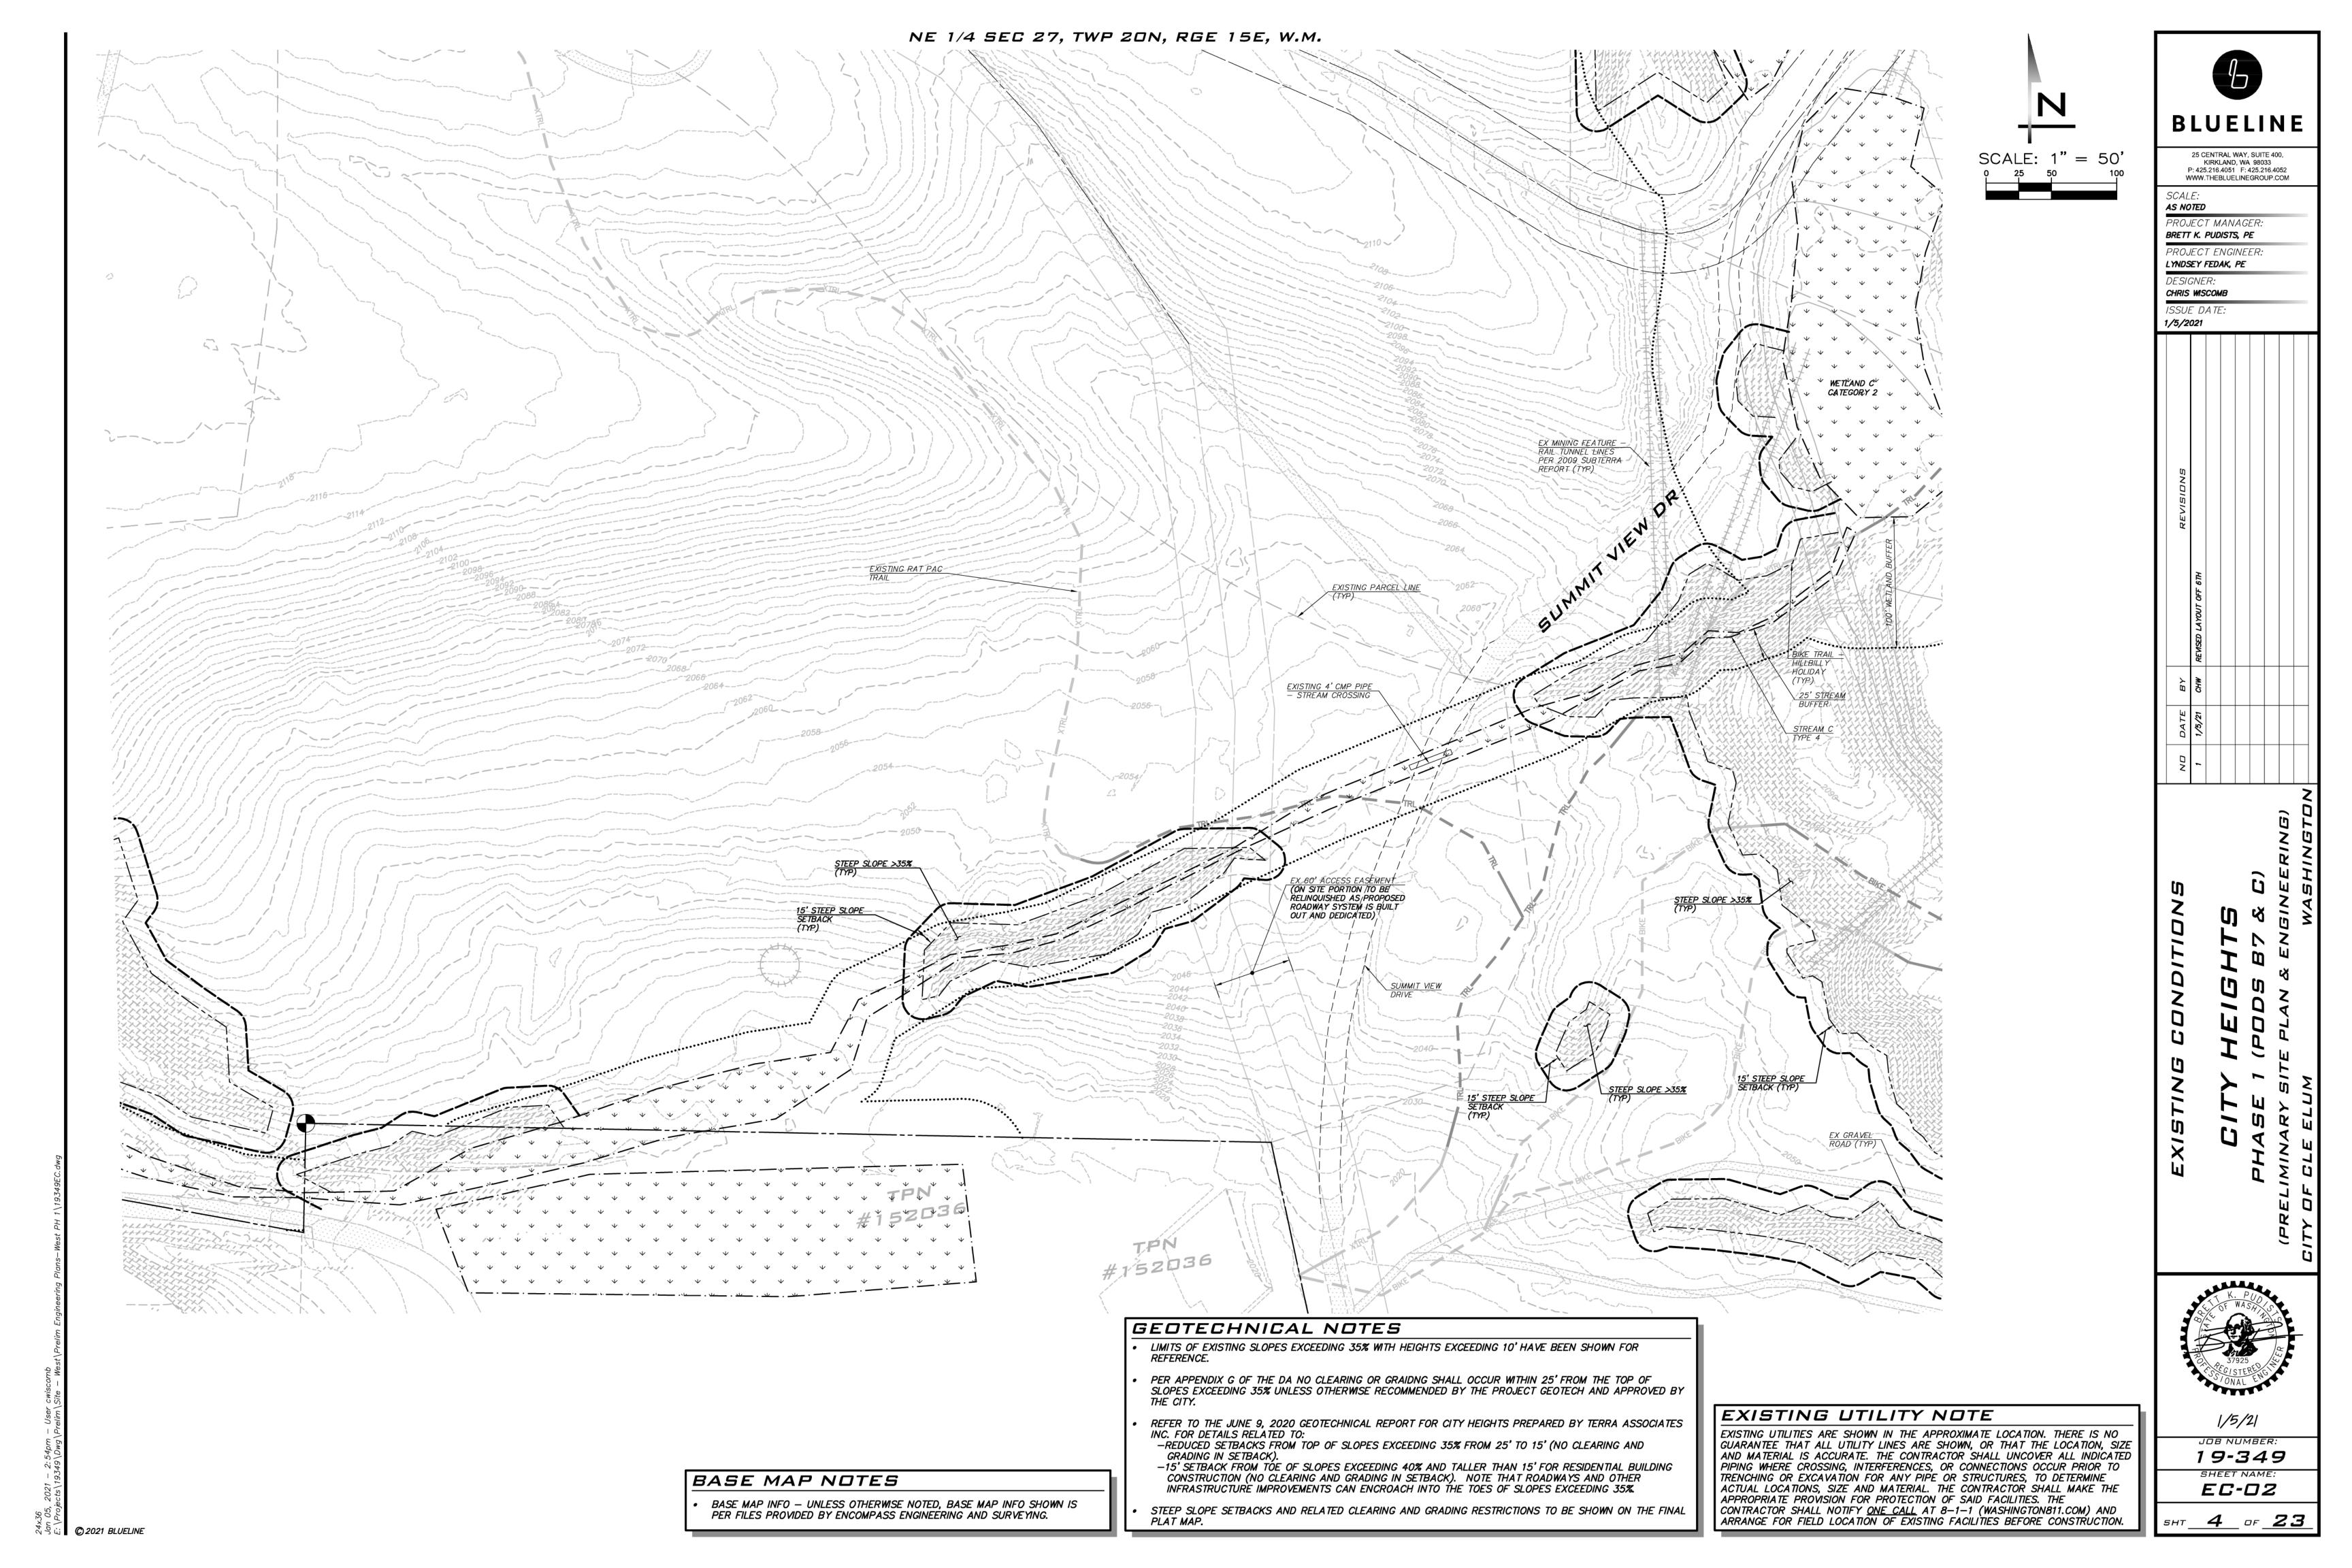

TRACT TABLE LOT AREAS DESCRIPTION AREA AREA LOT# 5,538 SF 22,661 SF (0.52 AC) 4,708 SF PRIVATE ACCESS 6,363 SF (0.15 AC) 4,214 SF AND UTILITY TRACT OPEN SPACE 3,835 SF 16,384 SF (0.38 AC) (PRIVATE) 3,616 SF OPEN SPACE 14,660 SF (0.34 AC) 3,627 SF 3,755 SF OPEN SPACE/NATURAL BUFFER 1,940 SF (0.04 AC) 3,997 SF OPEN SPACE/NATURAL BUFFER 4,773 SF 5,056 SF (0.12 AC) 3,137 SF OPEN SPACE/NATURAL BUFFER 1,666 SF (0.04 AC) 3,024 SF (PRIVATE) 2,944 SF OPEN SPACE/NATURAL BUFFER 2,391 SF (0.05 AC) 2,972 SF 13 PRIVATE ACCESS 3,024 SF 3,123 SF (0.07 AC) AND UTILITY TRACT 3,116 SF 15 OPEN SPACE 42,546 SF (0.98 AC) (PRIVATE) 2,797 SF DAY USE PARKING 17 2,975 SF 14,412 SF (0.33 AC) (PUBLIC) 2,972 SF 18 AMENITY AREA 78,148 SF (1.79 AC) 2,888 SF (PRIVATE) 2,700 SF 20 OPEN SPACE 21,904 SF (0.50 AC) (PRIVATE) 2,250 SF OPEN SPACE 2,263 SF 22 322,862 SF (7.41 AC (PUBLIC) 2,356 SF CRITICAL AREA TRACT 29,468 SF (0.68 AC) 4,565 SF 24 (PRIVATE) 3,972 SF OPEN SPACE 25 1,338 SF (0.03 AC) (PRIVATE) 2,700 SF 26 OPEN SPACE 19,184 SF (0.44 AC) 27 2,250 SF 2,283 SF CRITICAL AREA 63,233 SF (1.45 AC) 2,493 SF 29 STORM WATER 4,004 SF 39,888 SF (0.92 AC) 3,690 SF OPEN SPACE 18,213 SF (0.42 AC) 3,922 SF 32 4,050 SF 33 STORM WATER 14,953 SF (0.34 AC) 3,589 SF CRITICAL AREA 11,425 SF (0.26 AC) *3*5 3,473 SF 3,588 SF 18,682 SF (0.43 AC) (PRIVATE) 4,393 SF 4,879 SF OPEN SPACE 38 2,003 SF (0.05 AC) (PRIVATE) 4,879 SF 2,000 SF (0.05 AC) 4,833 SF 40 (PRIVATE) 5,459 SF OPEN SPACE 2,285 SF (0.05 AC) 5,552 SF 42 OPEN SPACE 5,719 SF 2,814 SF (0.06 AC) 5,487 SF 11.91 AC \* OPEN SPACE TRACT AREA: 6,000 SF 45 \*\* CRITICAL AREA TRACT AREA: 2.39 AC 6,623 SF \*\*\* FUTURE AMENITY TRACT AREA: 1.79 AC 5,396 SF 16.09 AC (55.25% OF CURRENT PHASE) TO BE PLACED IN OPEN 6,557 SF SPACÉ, CRITICAL AREA TRACTS 6,226 SF AND FUTURE AMENITY TRACT. 6,577 SF 5,481 SF 5,474 SF 6,100 SF 7,102 SF 6,757 SF 55 5,664 SF NATURAL BUFFER NOTE 6,100 SF TRACTS D, E, F AND G ARE TO BE MINIMUM 20' WIDE TO 5,000 SF PROVIDE AN EXISTING NATURAL BUFFER ALONG THE SOUTH PROPERTY LINE. THESE TRACTS MAY BE 6,154 SF AESTHETICALLY ENHANCED UTILIZING VEGETATION 5,302 SF MANAGEMENT AND/OR INSTALLATION OF SUPPLEMENTAL 60 LANDSCAPING AT APPLICANTS DISCRETION. TRACTS A, 5,638 SF B, AND C ARE ALSO DESIGNATED AS OPEN SPACE AND WILL PROVIDE ADDITIONAL OPPORTUNITIES FOR 6,365 SF 62 6,330 SF 63 6,330 SF 64 7,371 SF 65 6,736 SF 5,602 SF 6,872 SF


### RECREATIONAL TRAILS NOTE

RECREATIONAL TRAILS NOT LOCATED IN PUBLIC TRACTS ARE TO BE PLACED IN 15' WIDE PUBLIC ACCESS EASEMENT FOR PUBLIC USE AND MAINTENANCE. REFER TO NOTES ON SHEET OS-01 FOR DETAILS.

TOTAL LOT AREA: 7.14 AC

#### EXISTING UTILITY NOTE

EXISTING UTILITIES ARE SHOWN IN THE APPROXIMATE LOCATION. THERE IS NO GUARANTEE THAT ALL UTILITY LINES ARE SHOWN, OR THAT THE LOCATION, SIZE AND MATERIAL IS ACCURATE. THE CONTRACTOR SHALL UNCOVER ALL INDICATED PIPING WHERE CROSSING, INTERFERENCES, OR CONNECTIONS OCCUR PRIOR TO TRENCHING OR EXCAVATION FOR ANY PIPE OR STRUCTURES, TO DETERMINE ACTUAL LOCATIONS, SIZE AND MATERIAL. THE CONTRACTOR SHALL MAKE THE APPROPRIATE PROVISION FOR PROTECTION OF SAID FACILITIES. THE CONTRACTOR SHALL NOTIFY ONE CALL AT 8-1-1 (WASHINGTON811.COM) AND ARRANGE FOR FIELD LOCATION OF EXISTING FACILITIES BEFORE CONSTRUCTION.

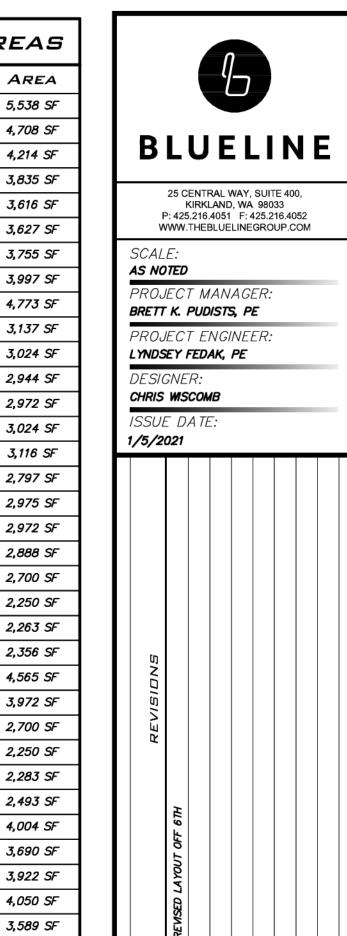

Y HEIGHTS 1 (PODS B7 & C)

PHASE 1 (PDD (PRELIMINARY SITE PLAN



1/5/21

JOB NUMBER:
19-349
SHEET NAME:
SP-01

5 of **23** 


<sup>₹</sup> <sup>9</sup> ii **© 2021 BLUELINE** 

PROVIDE 5' EASEMENT (NOT SHOWN) FOR SNOW PLOWING AND STORAGE

ALONG LOTS FRONTING ALL OTHER ONSITE ROADS.

янт <u>6</u> оғ <u>23</u>

CONTRACTOR SHALL NOTIFY ONE CALL AT 8-1-1 (WASHINGTON811.COM) AND ARRANGE FOR FIELD LOCATION OF EXISTING FACILITIES BEFORE CONSTRUCTION.

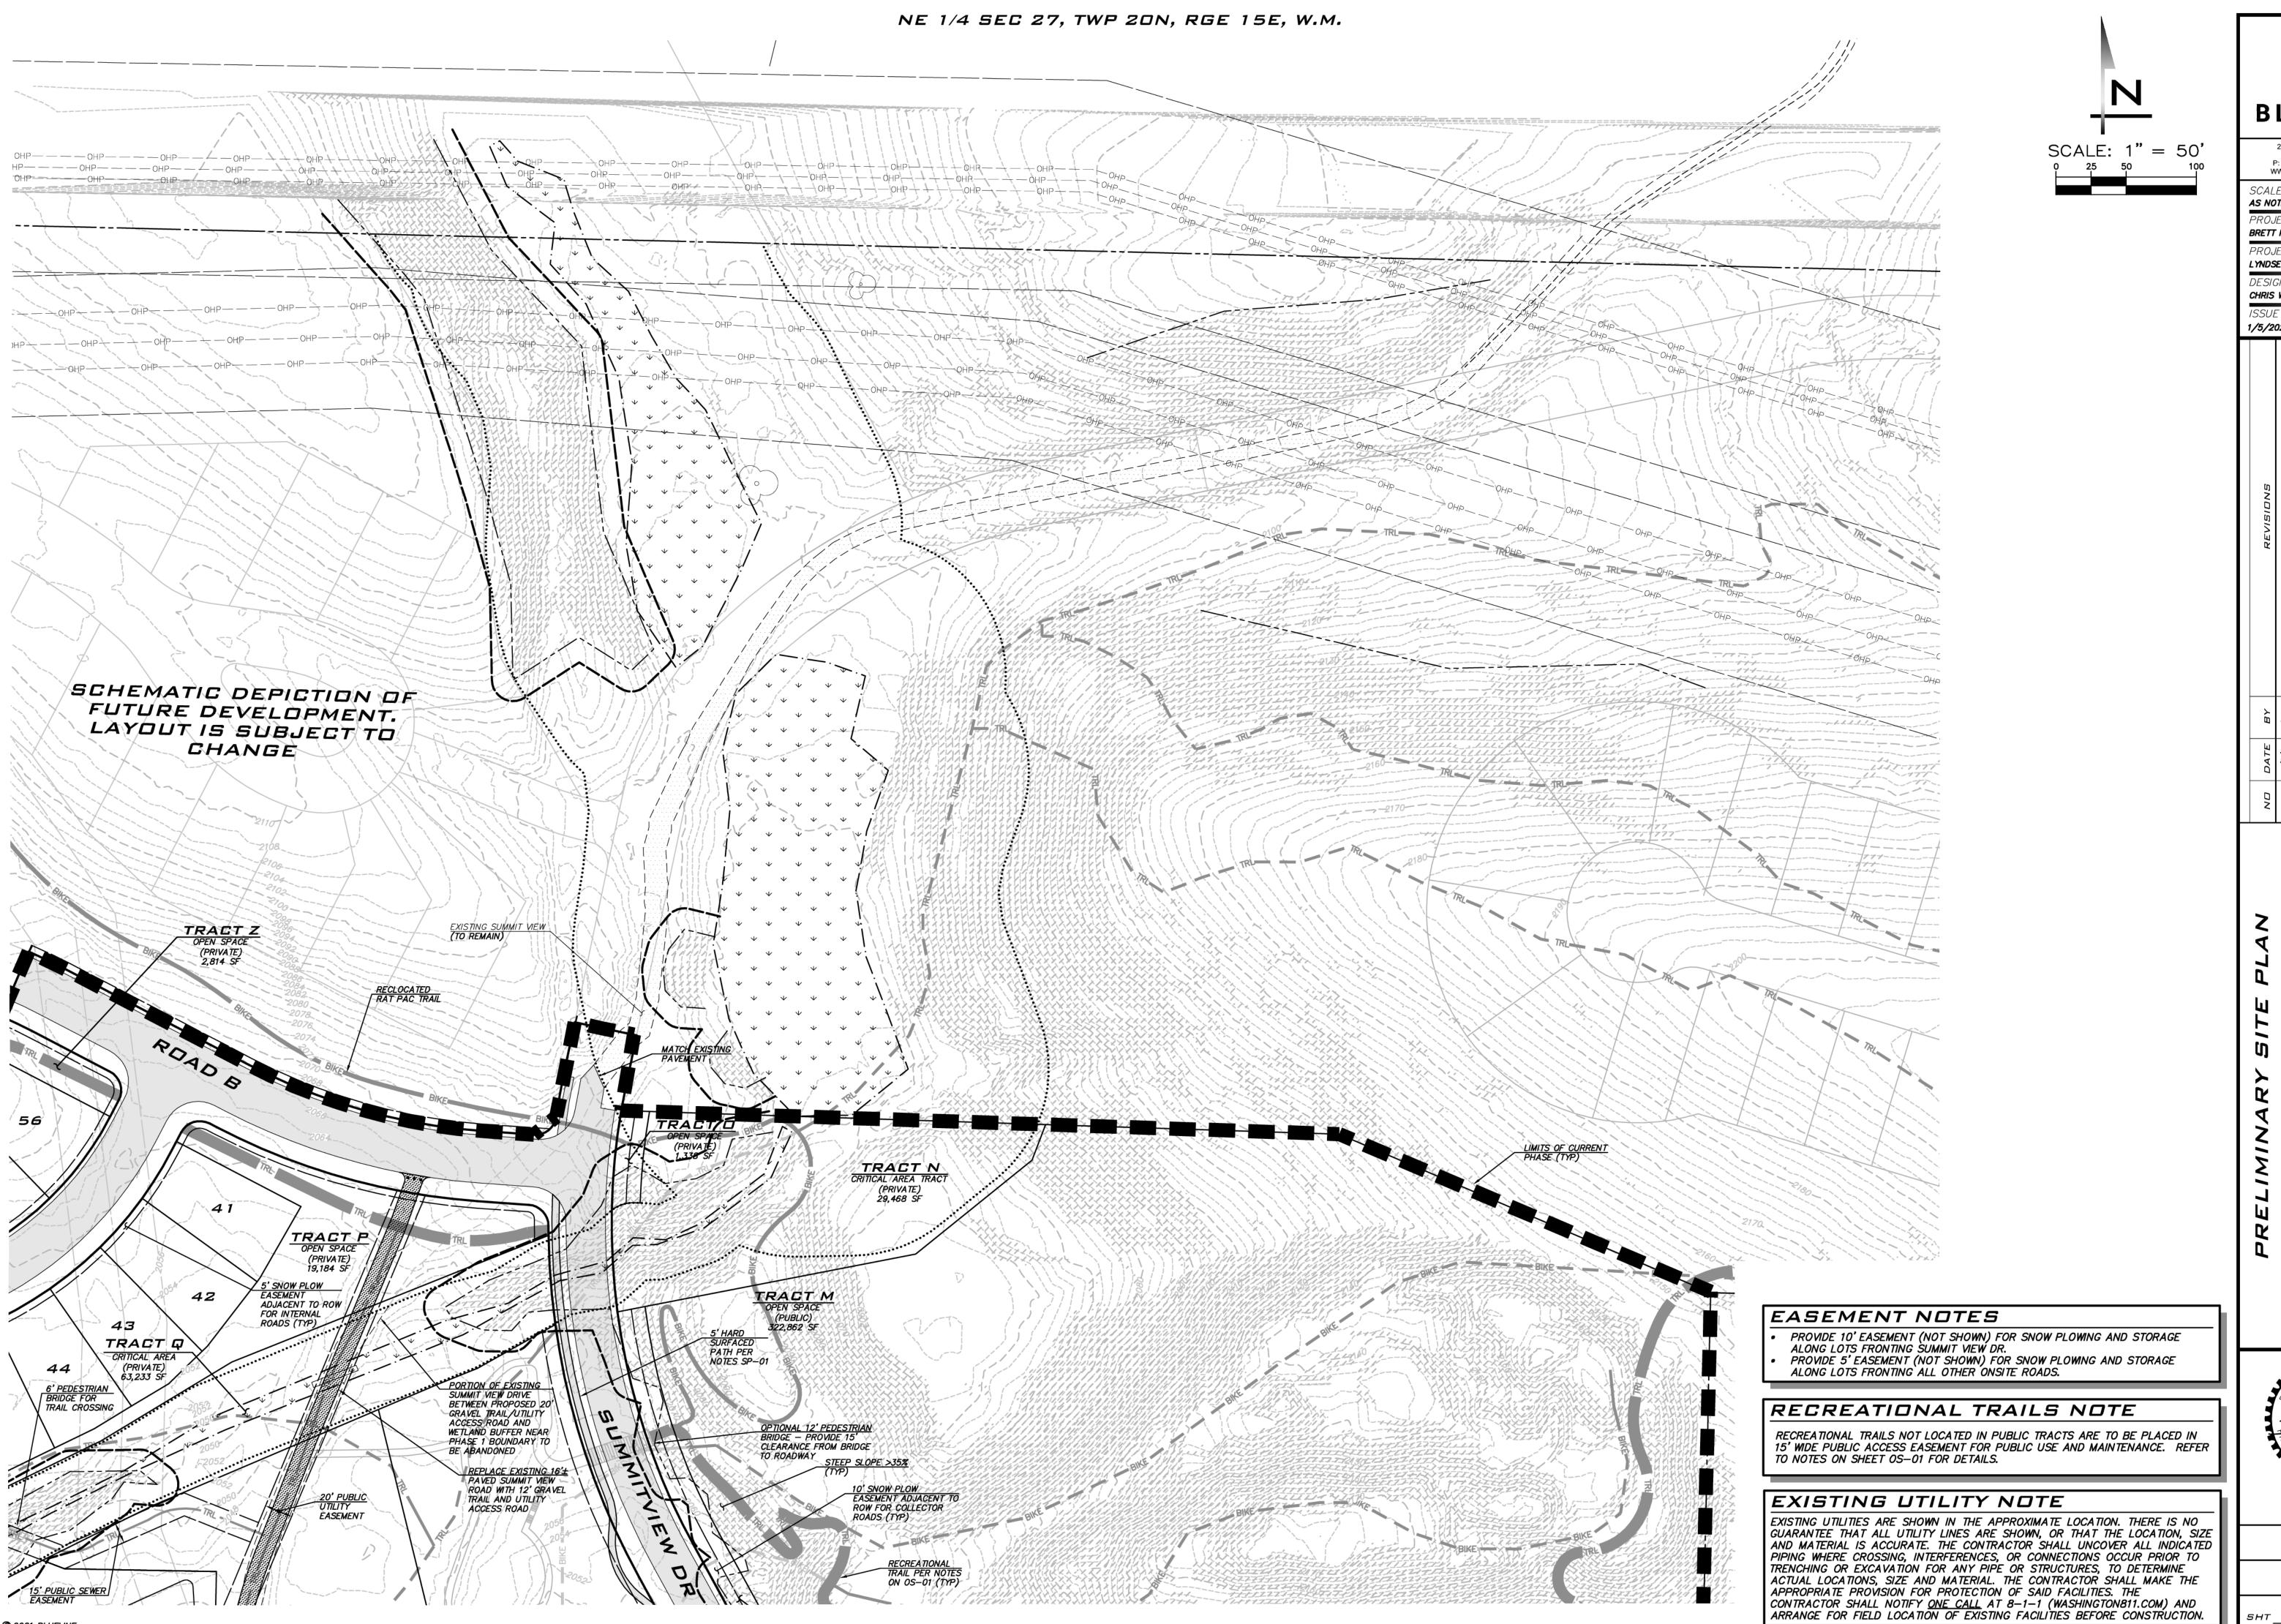




25 CENTRAL WAY, SUITE 400, KIRKLAND, WA 98033 P: 425.216.4051 F: 425.216.4052 WWW.THEBLUELINEGROUP.COM

AS NOTED

PROJECT MANAGER: BRETT K. PUDISTS, PE


PROJECT ENGINEER: LYNDSEY FEDAK, PE

CHRIS WISCOMB

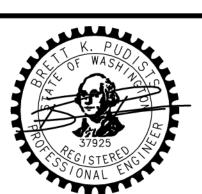


19-349 SP-03

7\_ of <u>23</u>

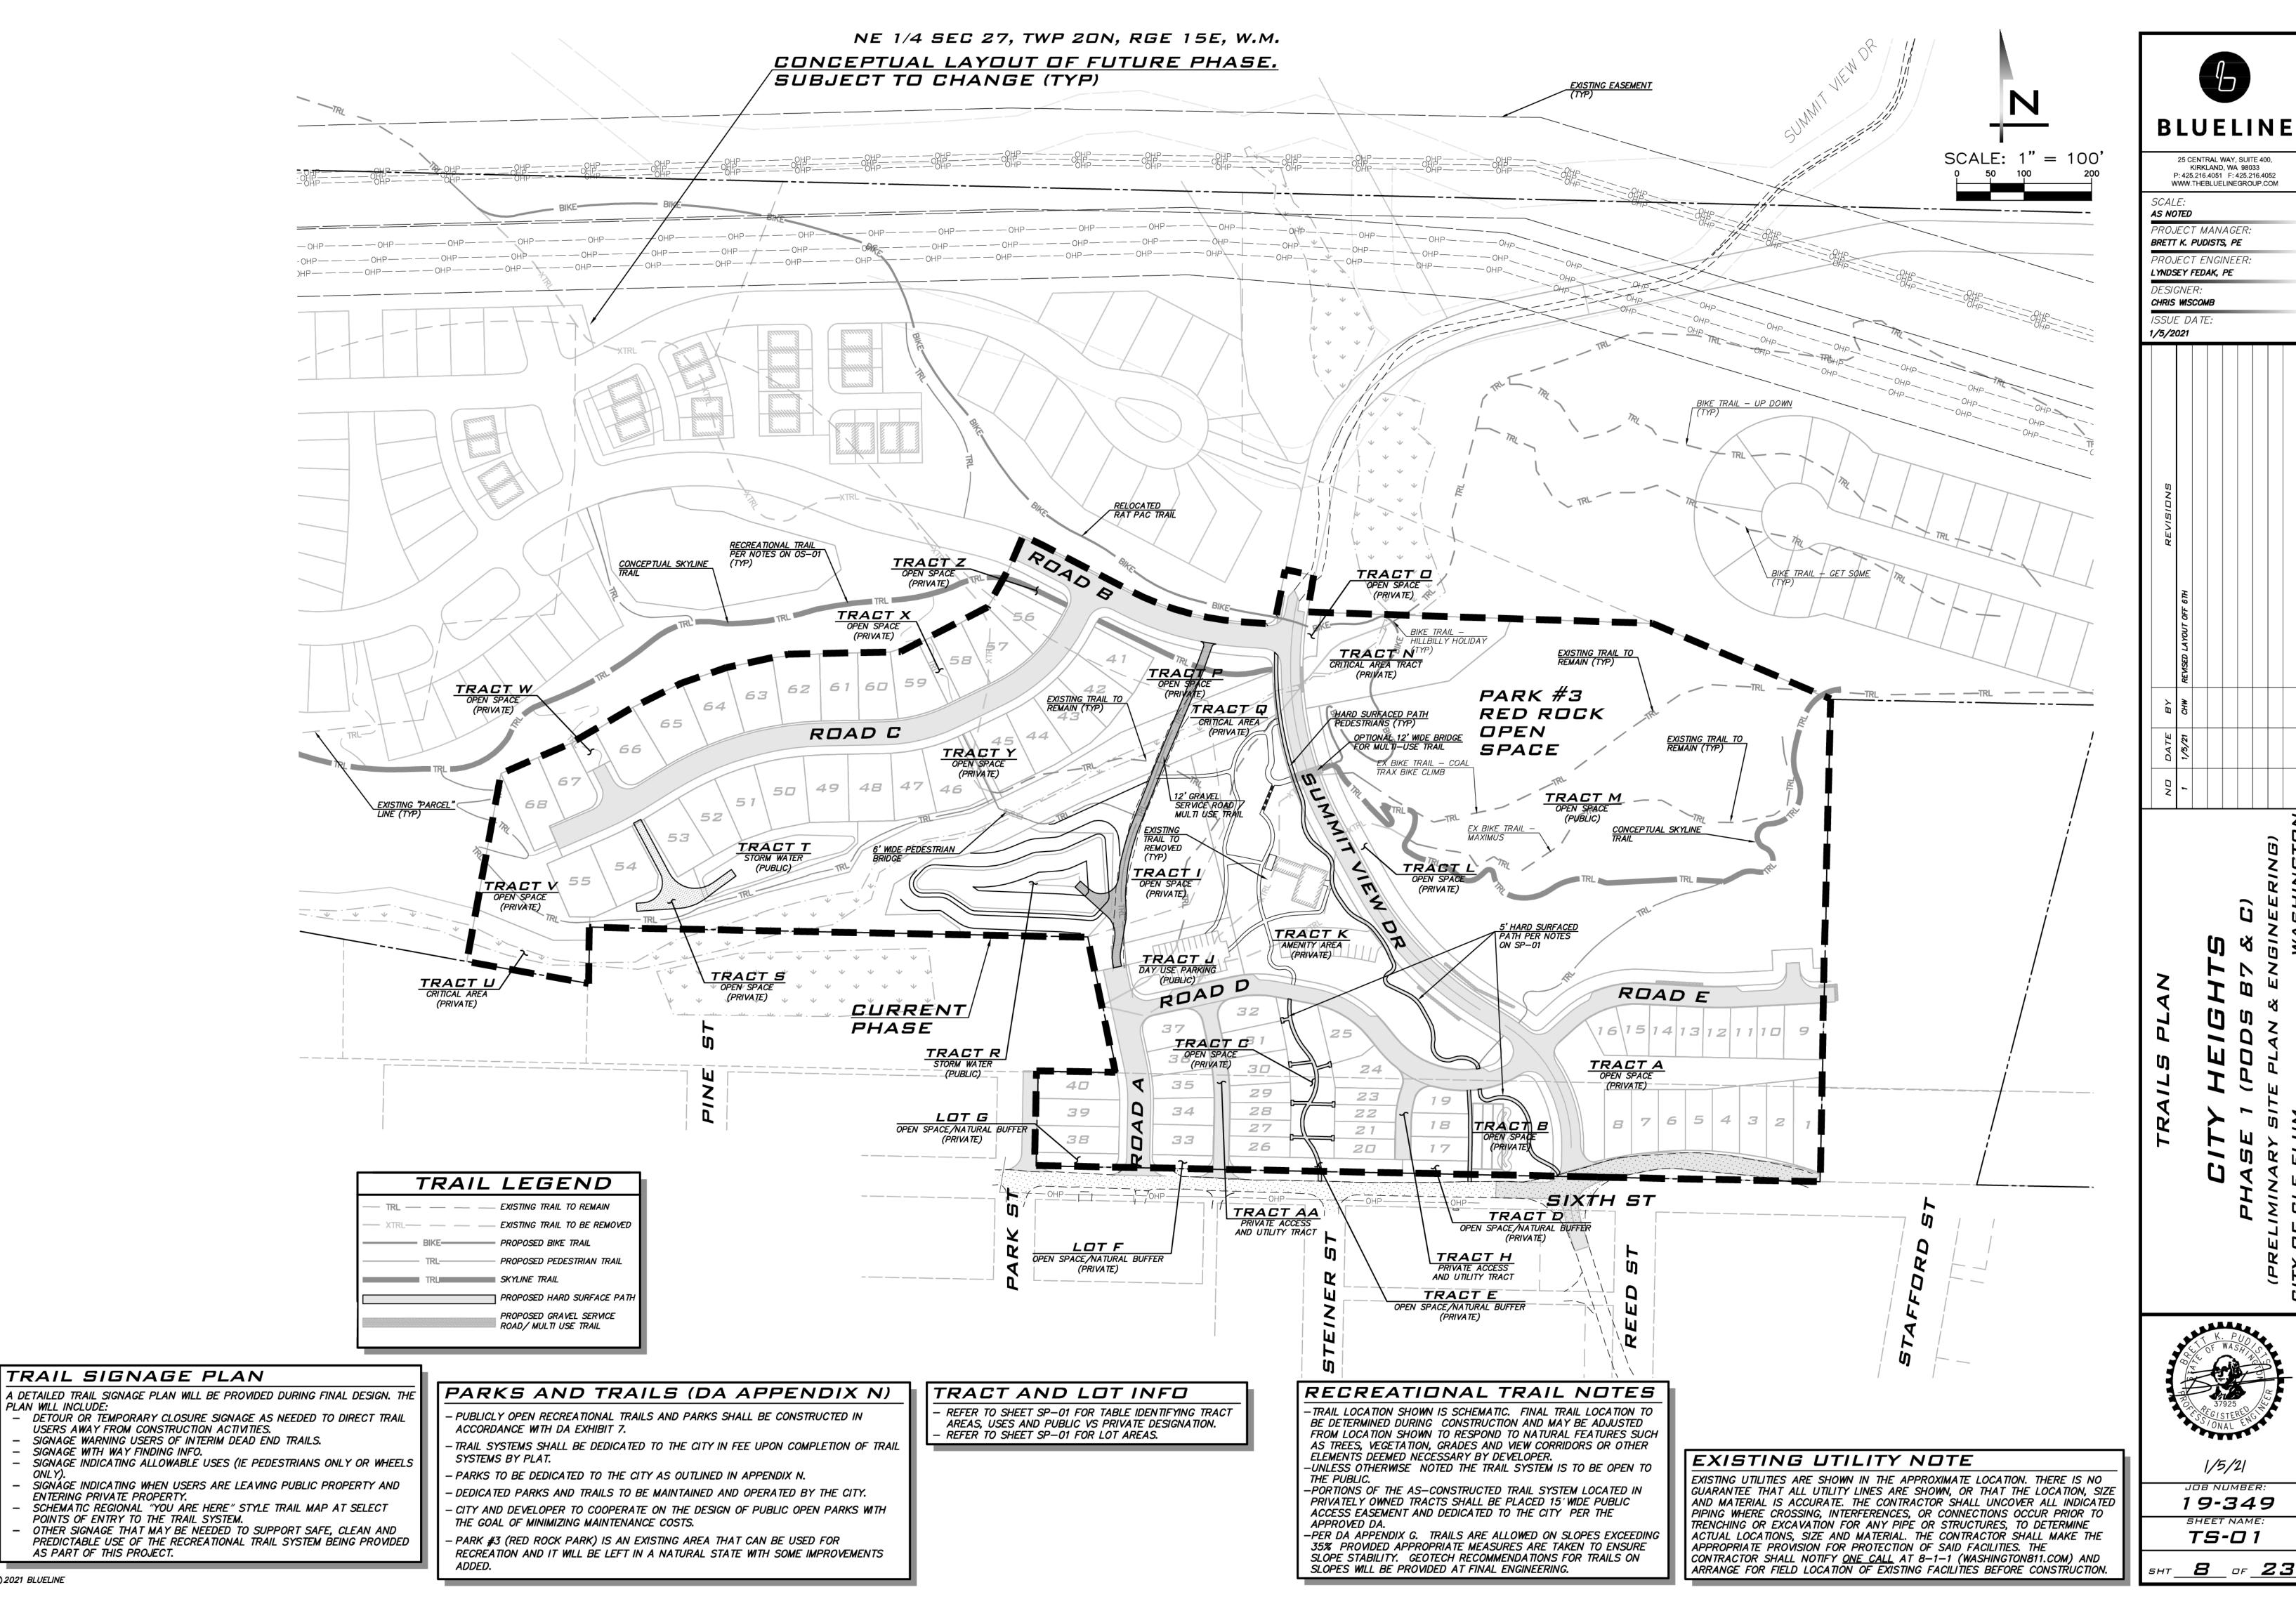


្កីខ៊ីដi **©2021 BLUELINE** 

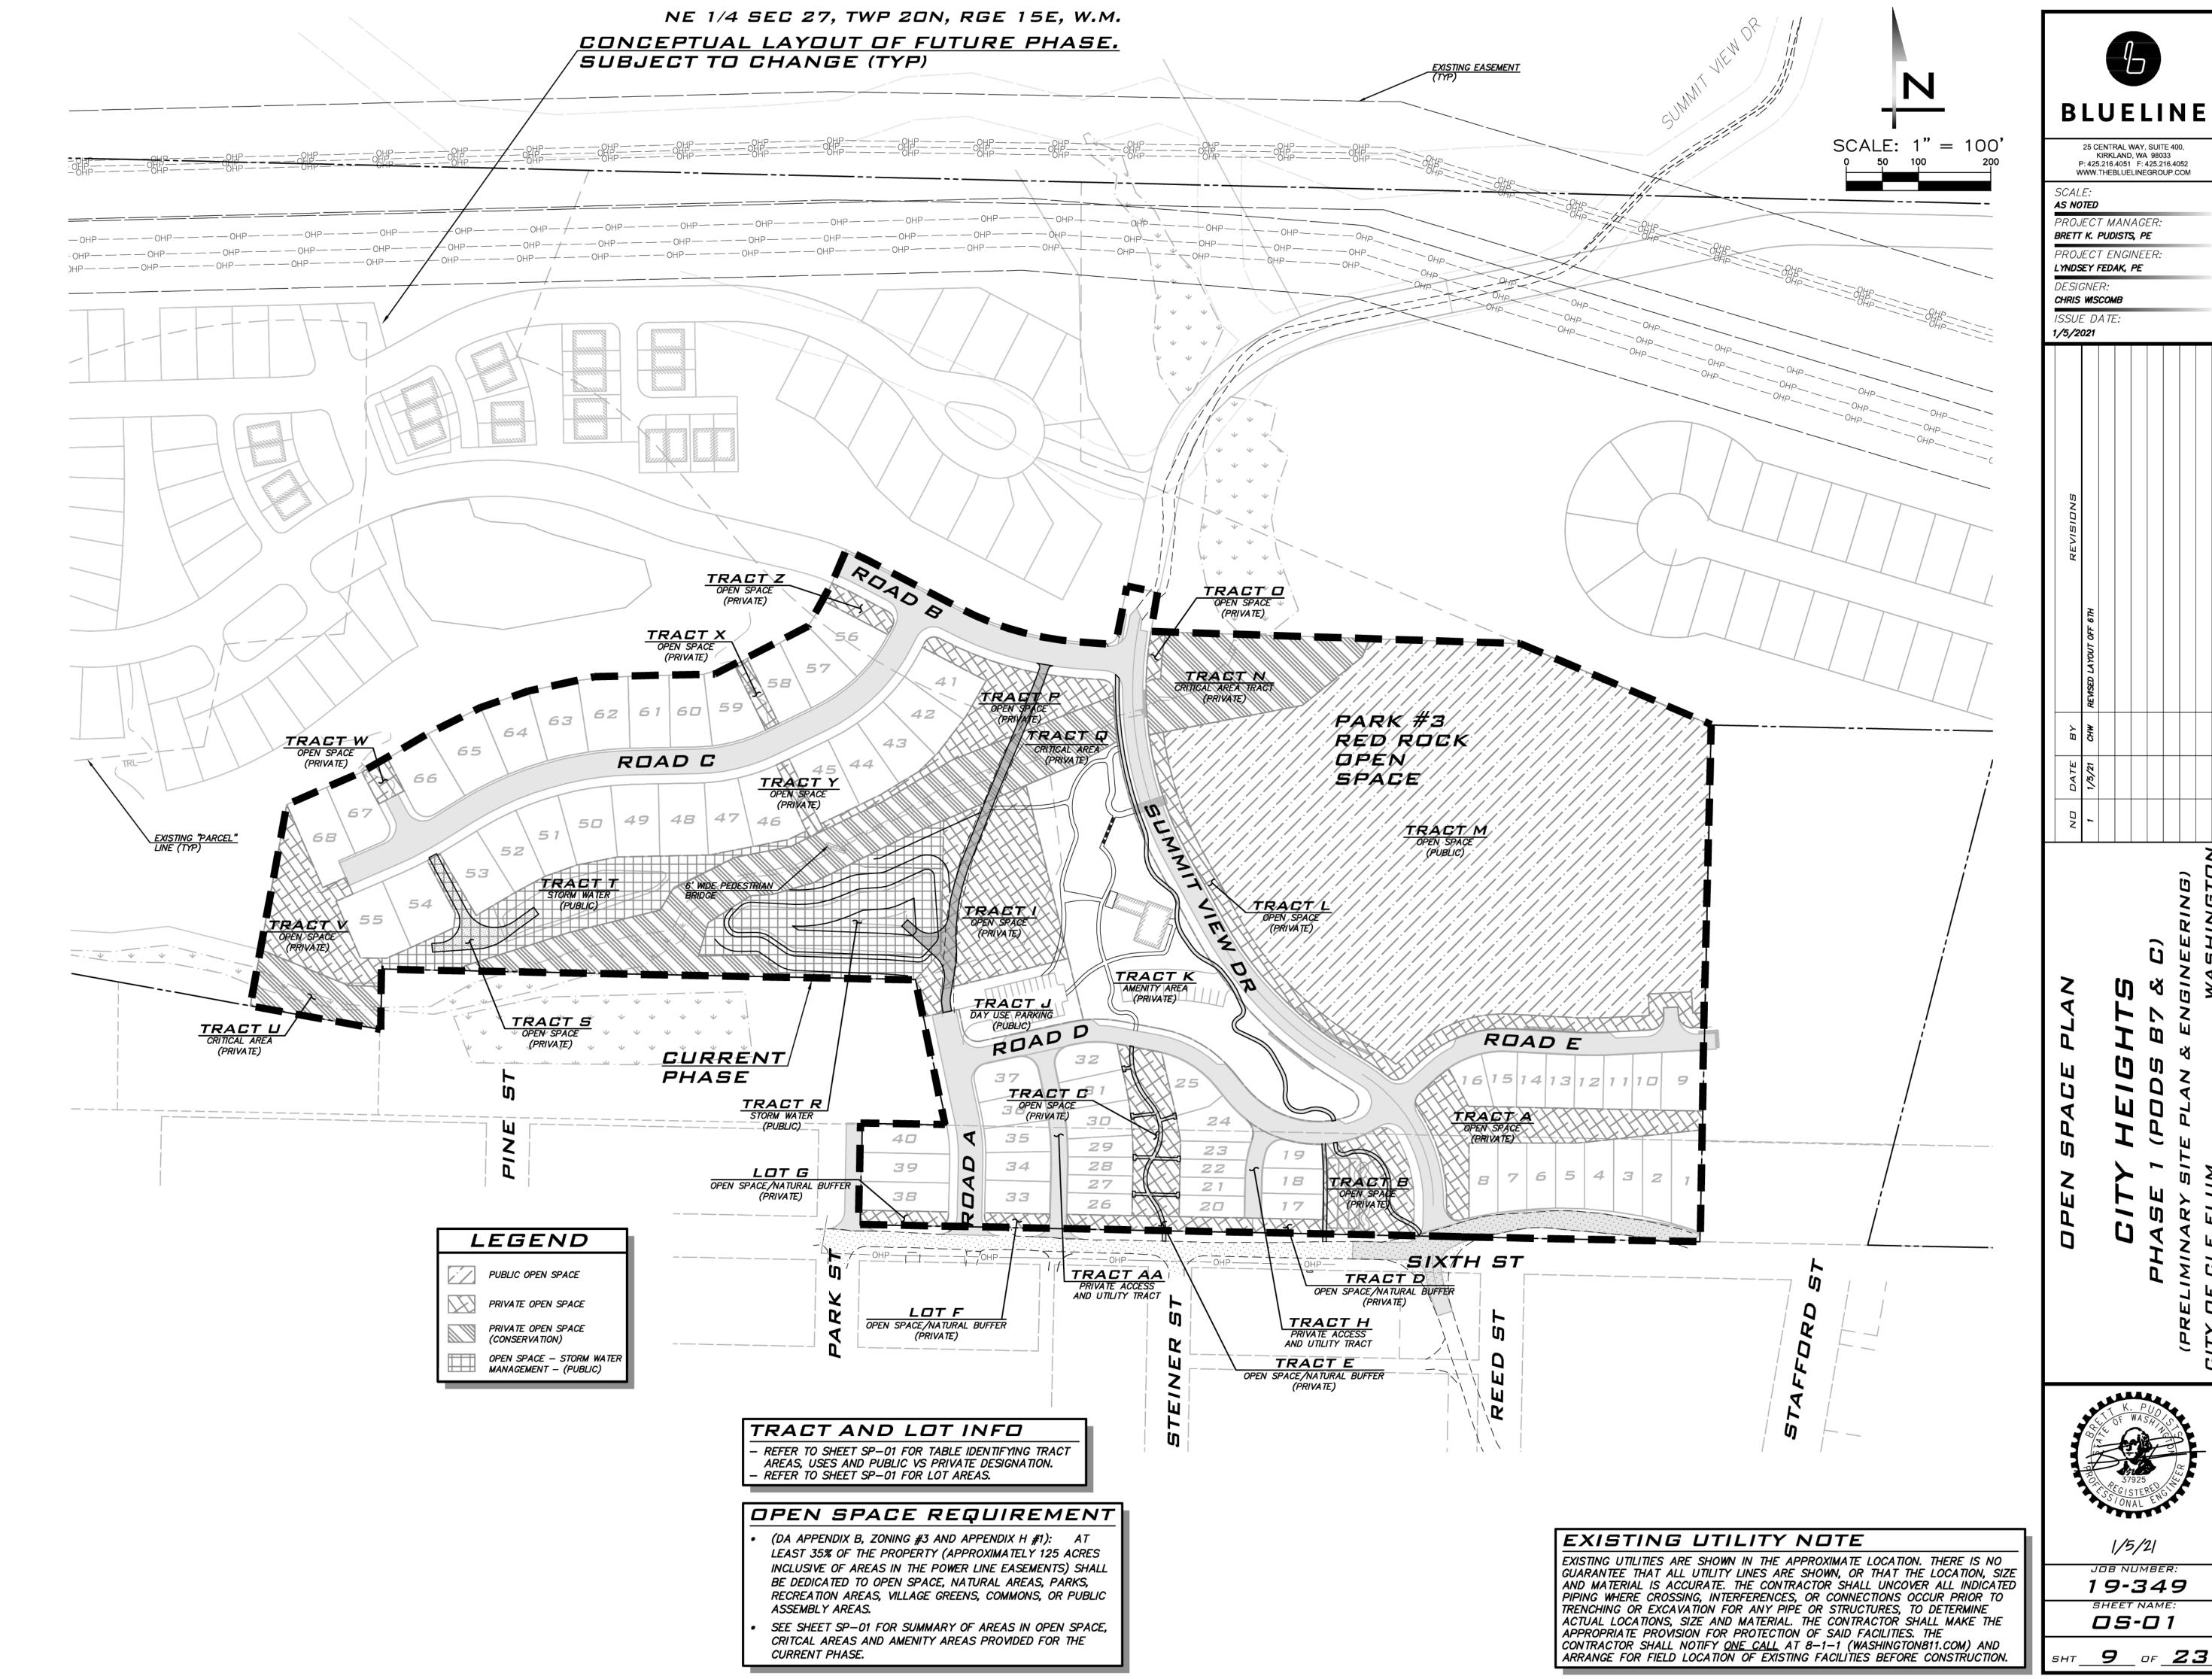

BLUELINE

19-349

<sup>₹</sup> <sup>9</sup> ii **© 2021 BLUELINE** 

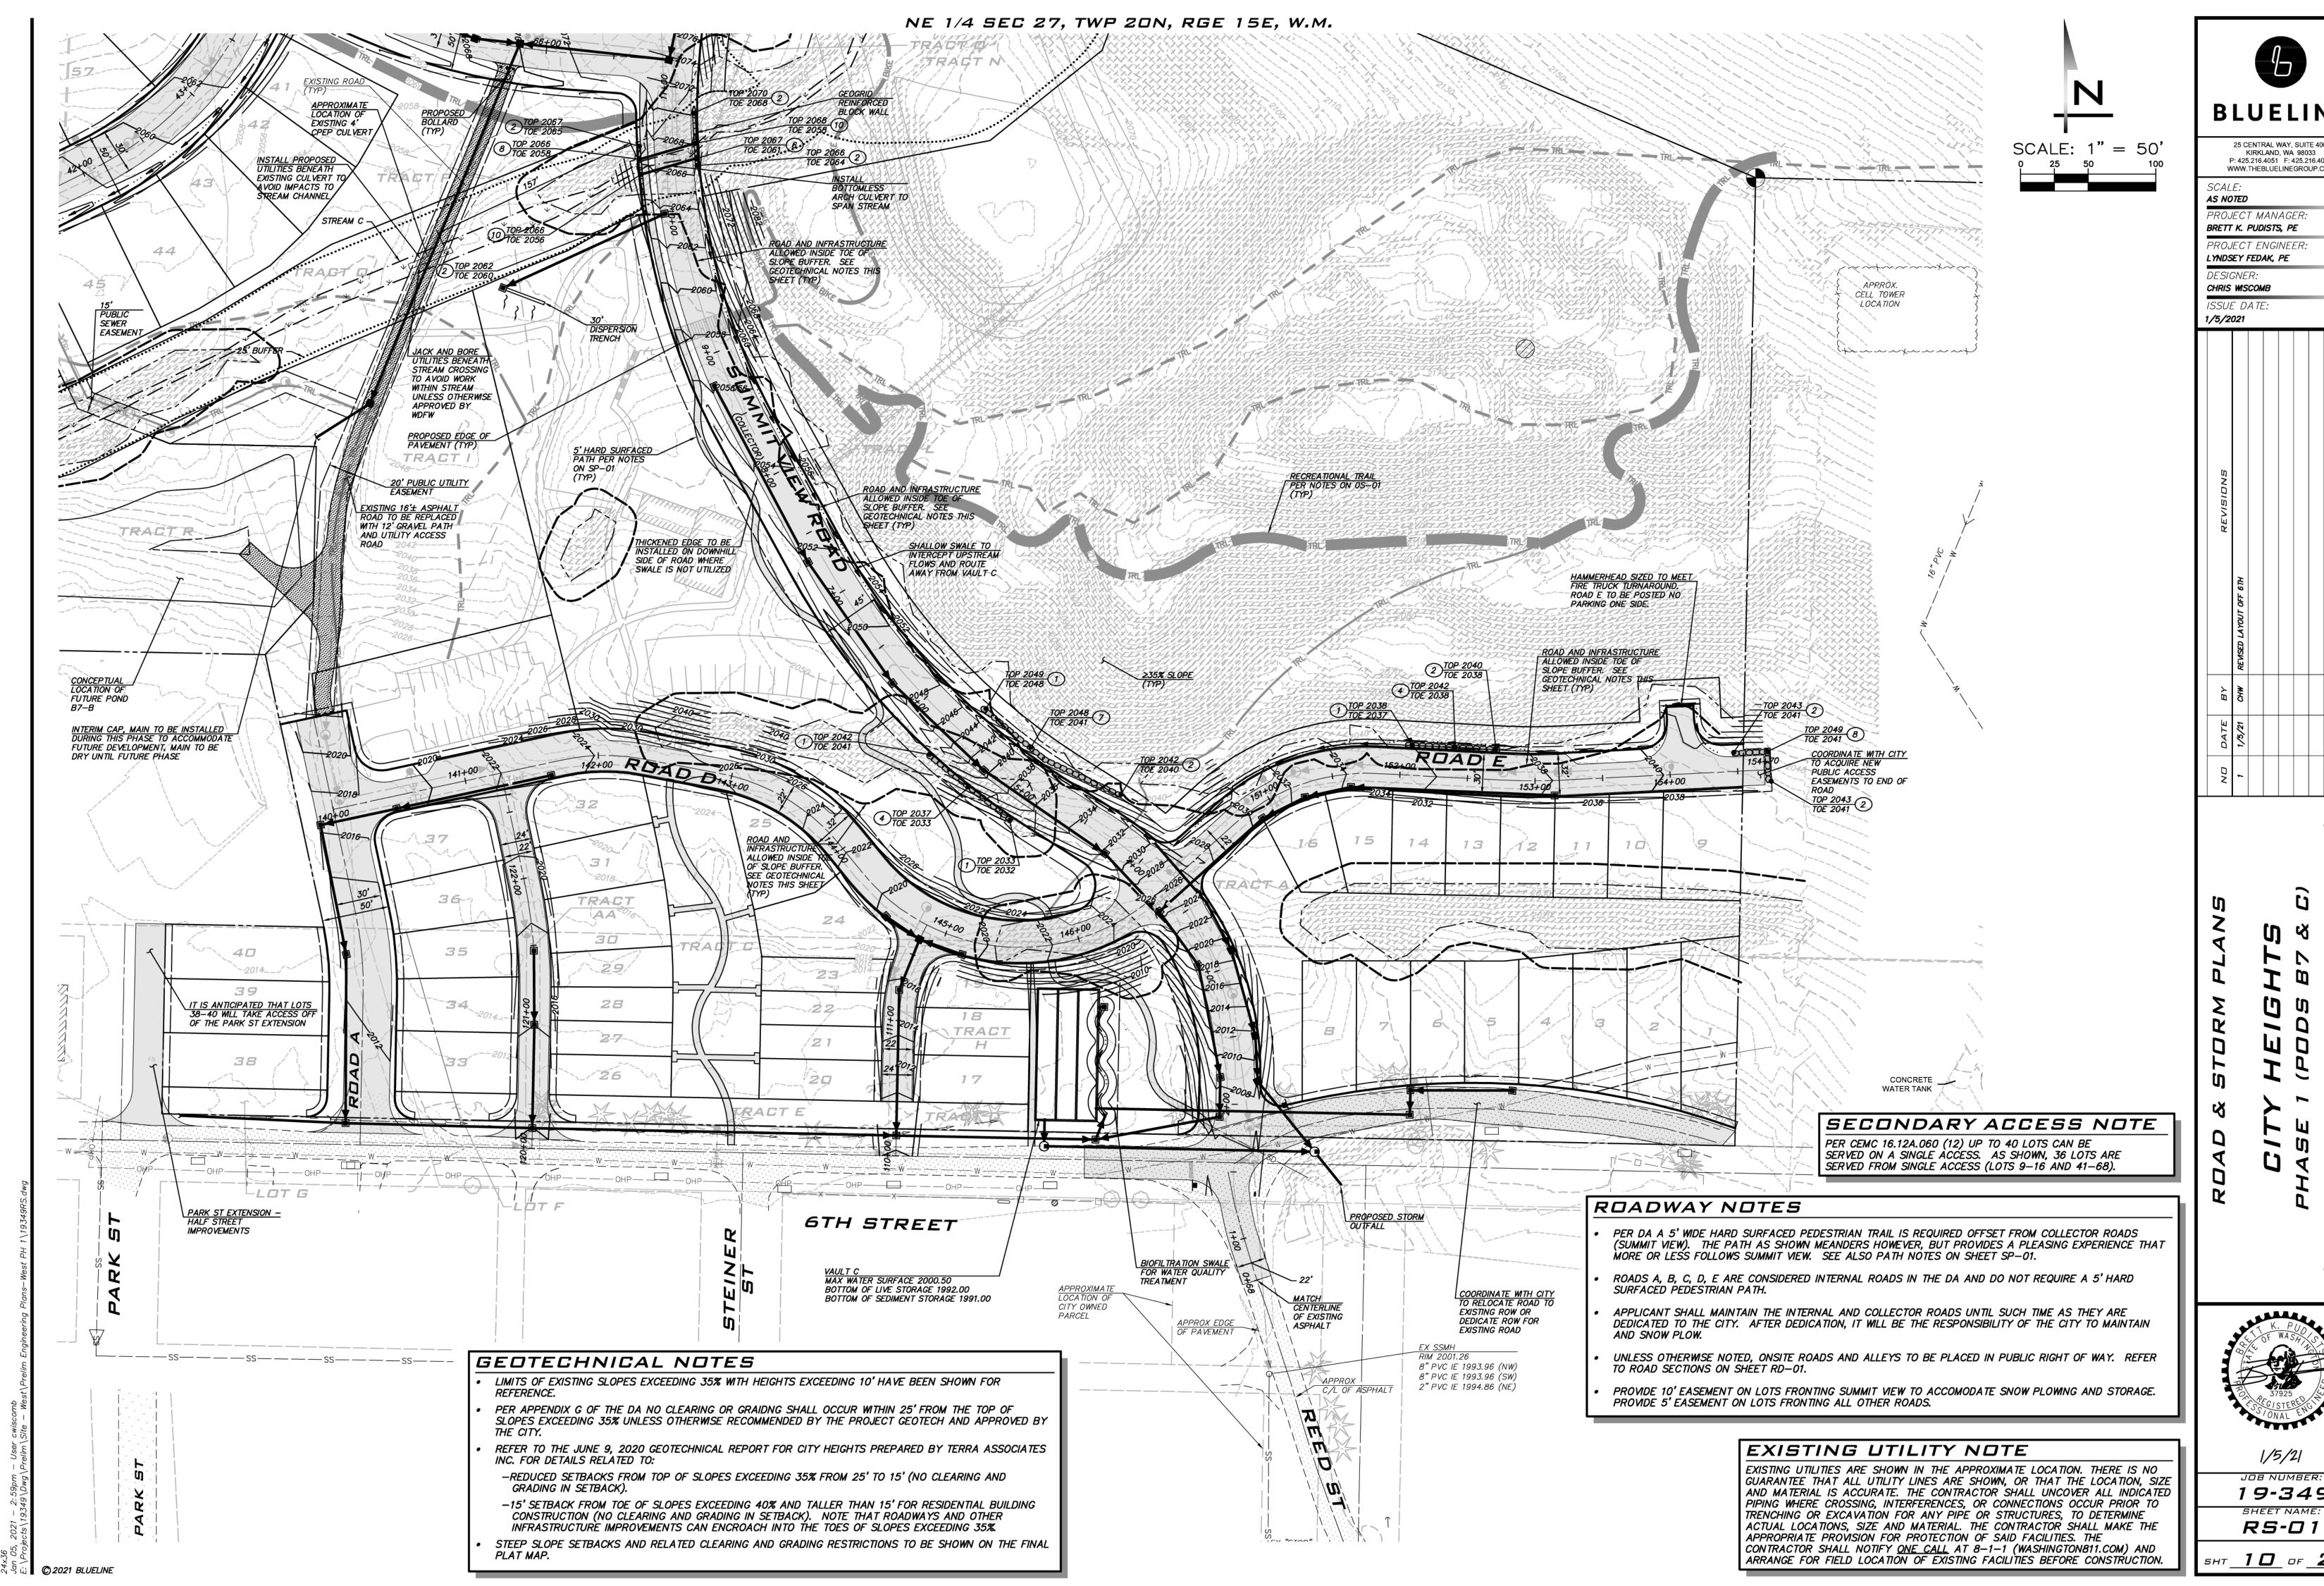

**BLUELINE** 


25 CENTRAL WAY, SUITE 400, KIRKLAND, WA 98033 P: 425.216.4051 F: 425.216.4052

WWW.THEBLUELINEGROUP.COM

PROJECT MANAGER. BRETT K. PUDISTS, PE

PROJECT ENGINEER: LYNDSEY FEDAK, PE


CHRIS WISCOMB

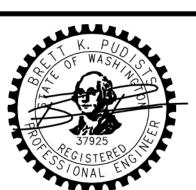



1/5/21

19-349

sнт\_**10**\_ of **\_23** 

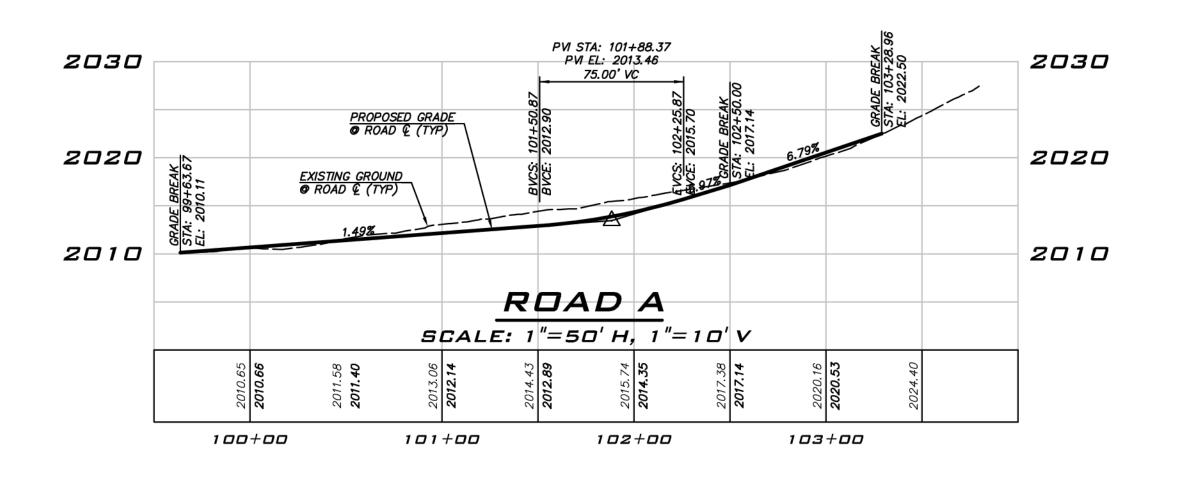

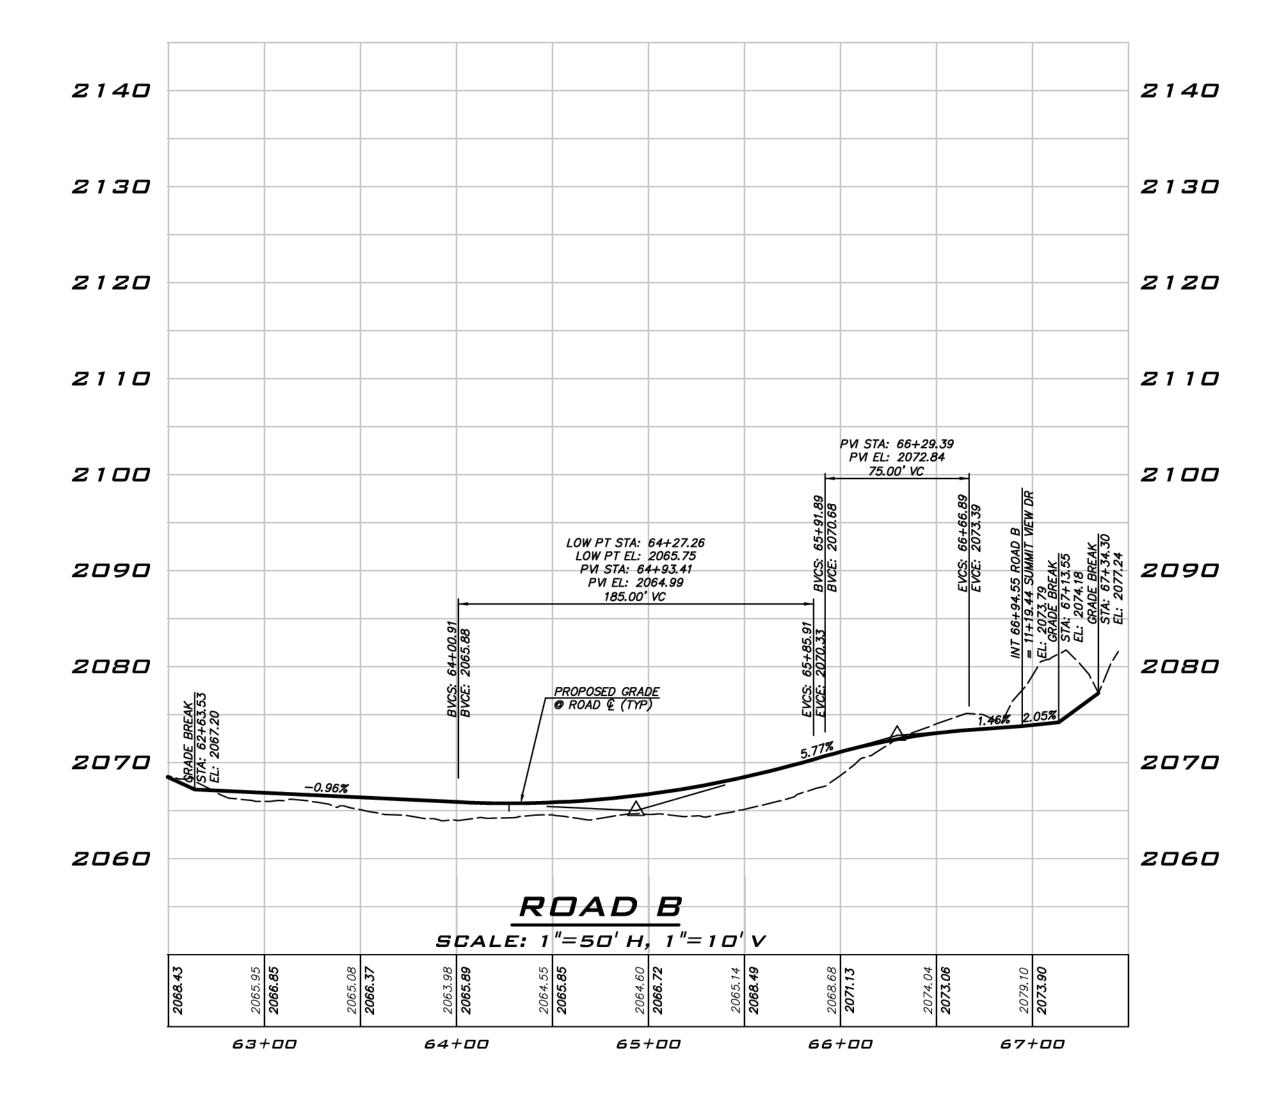

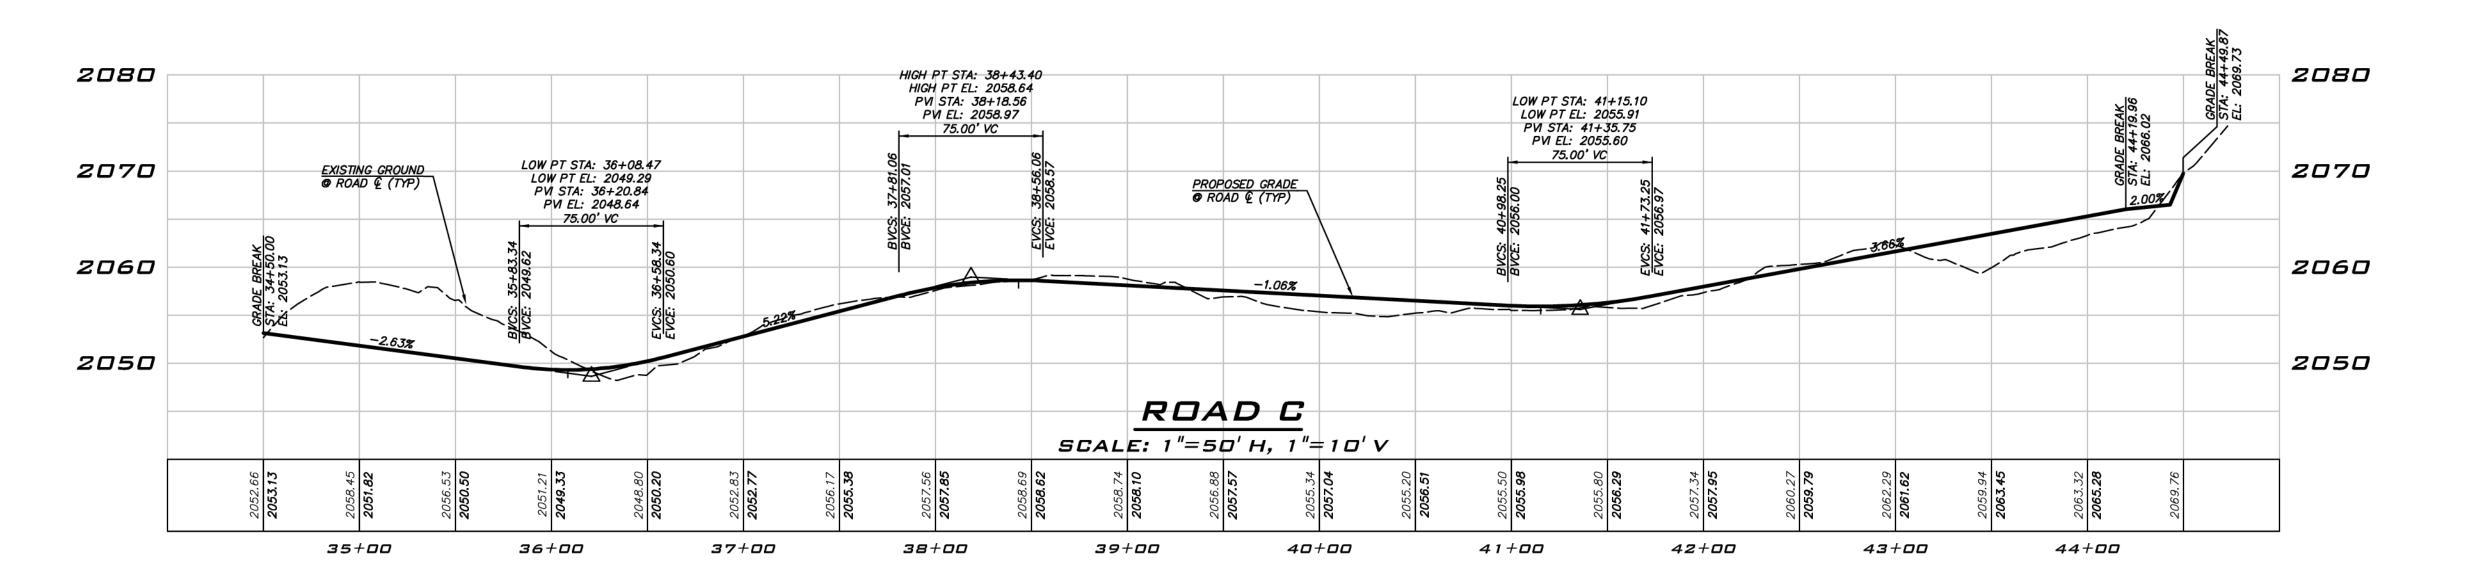

#### EXISTING UTILITY NOTE

EXISTING UTILITIES ARE SHOWN IN THE APPROXIMATE LOCATION. THERE IS NO GUARANTEE THAT ALL UTILITY LINES ARE SHOWN, OR THAT THE LOCATION, SIZE AND MATERIAL IS ACCURATE. THE CONTRACTOR SHALL UNCOVER ALL INDICATED PIPING WHERE CROSSING, INTERFERENCES, OR CONNECTIONS OCCUR PRIOR TO TRENCHING OR EXCAVATION FOR ANY PIPE OR STRUCTURES, TO DETERMINE ACTUAL LOCATIONS, SIZE AND MATERIAL. THE CONTRACTOR SHALL MAKE THE APPROPRIATE PROVISION FOR PROTECTION OF SAID FACILITIES. THE CONTRACTOR SHALL NOTIFY ONE CALL AT 8-1-1 (WASHINGTON811.COM) AND ARRANGE FOR FIELD LOCATION OF EXISTING FACILITIES BEFORE CONSTRUCTION.




25 CENTRAL WAY, SUITE 400, KIRKLAND, WA 98033 P: 425.216.4051 F: 425.216.4052 WWW.THEBLUELINEGROUP.COM

SCALE: AS NOTED PROJECT MANAGER:

BRETT K. PUDISTS, PE PROJECT ENGINEER: LYNDSEY FEDAK, PE

CHRIS WISCOMB ISSUE DATE:


1/5/2021

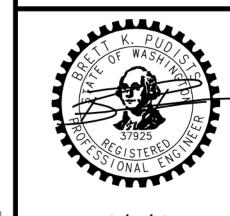



1/5/21


19-349 SHEET NAME: RP-01

sнт <u>12</u> ог <u>23</u>

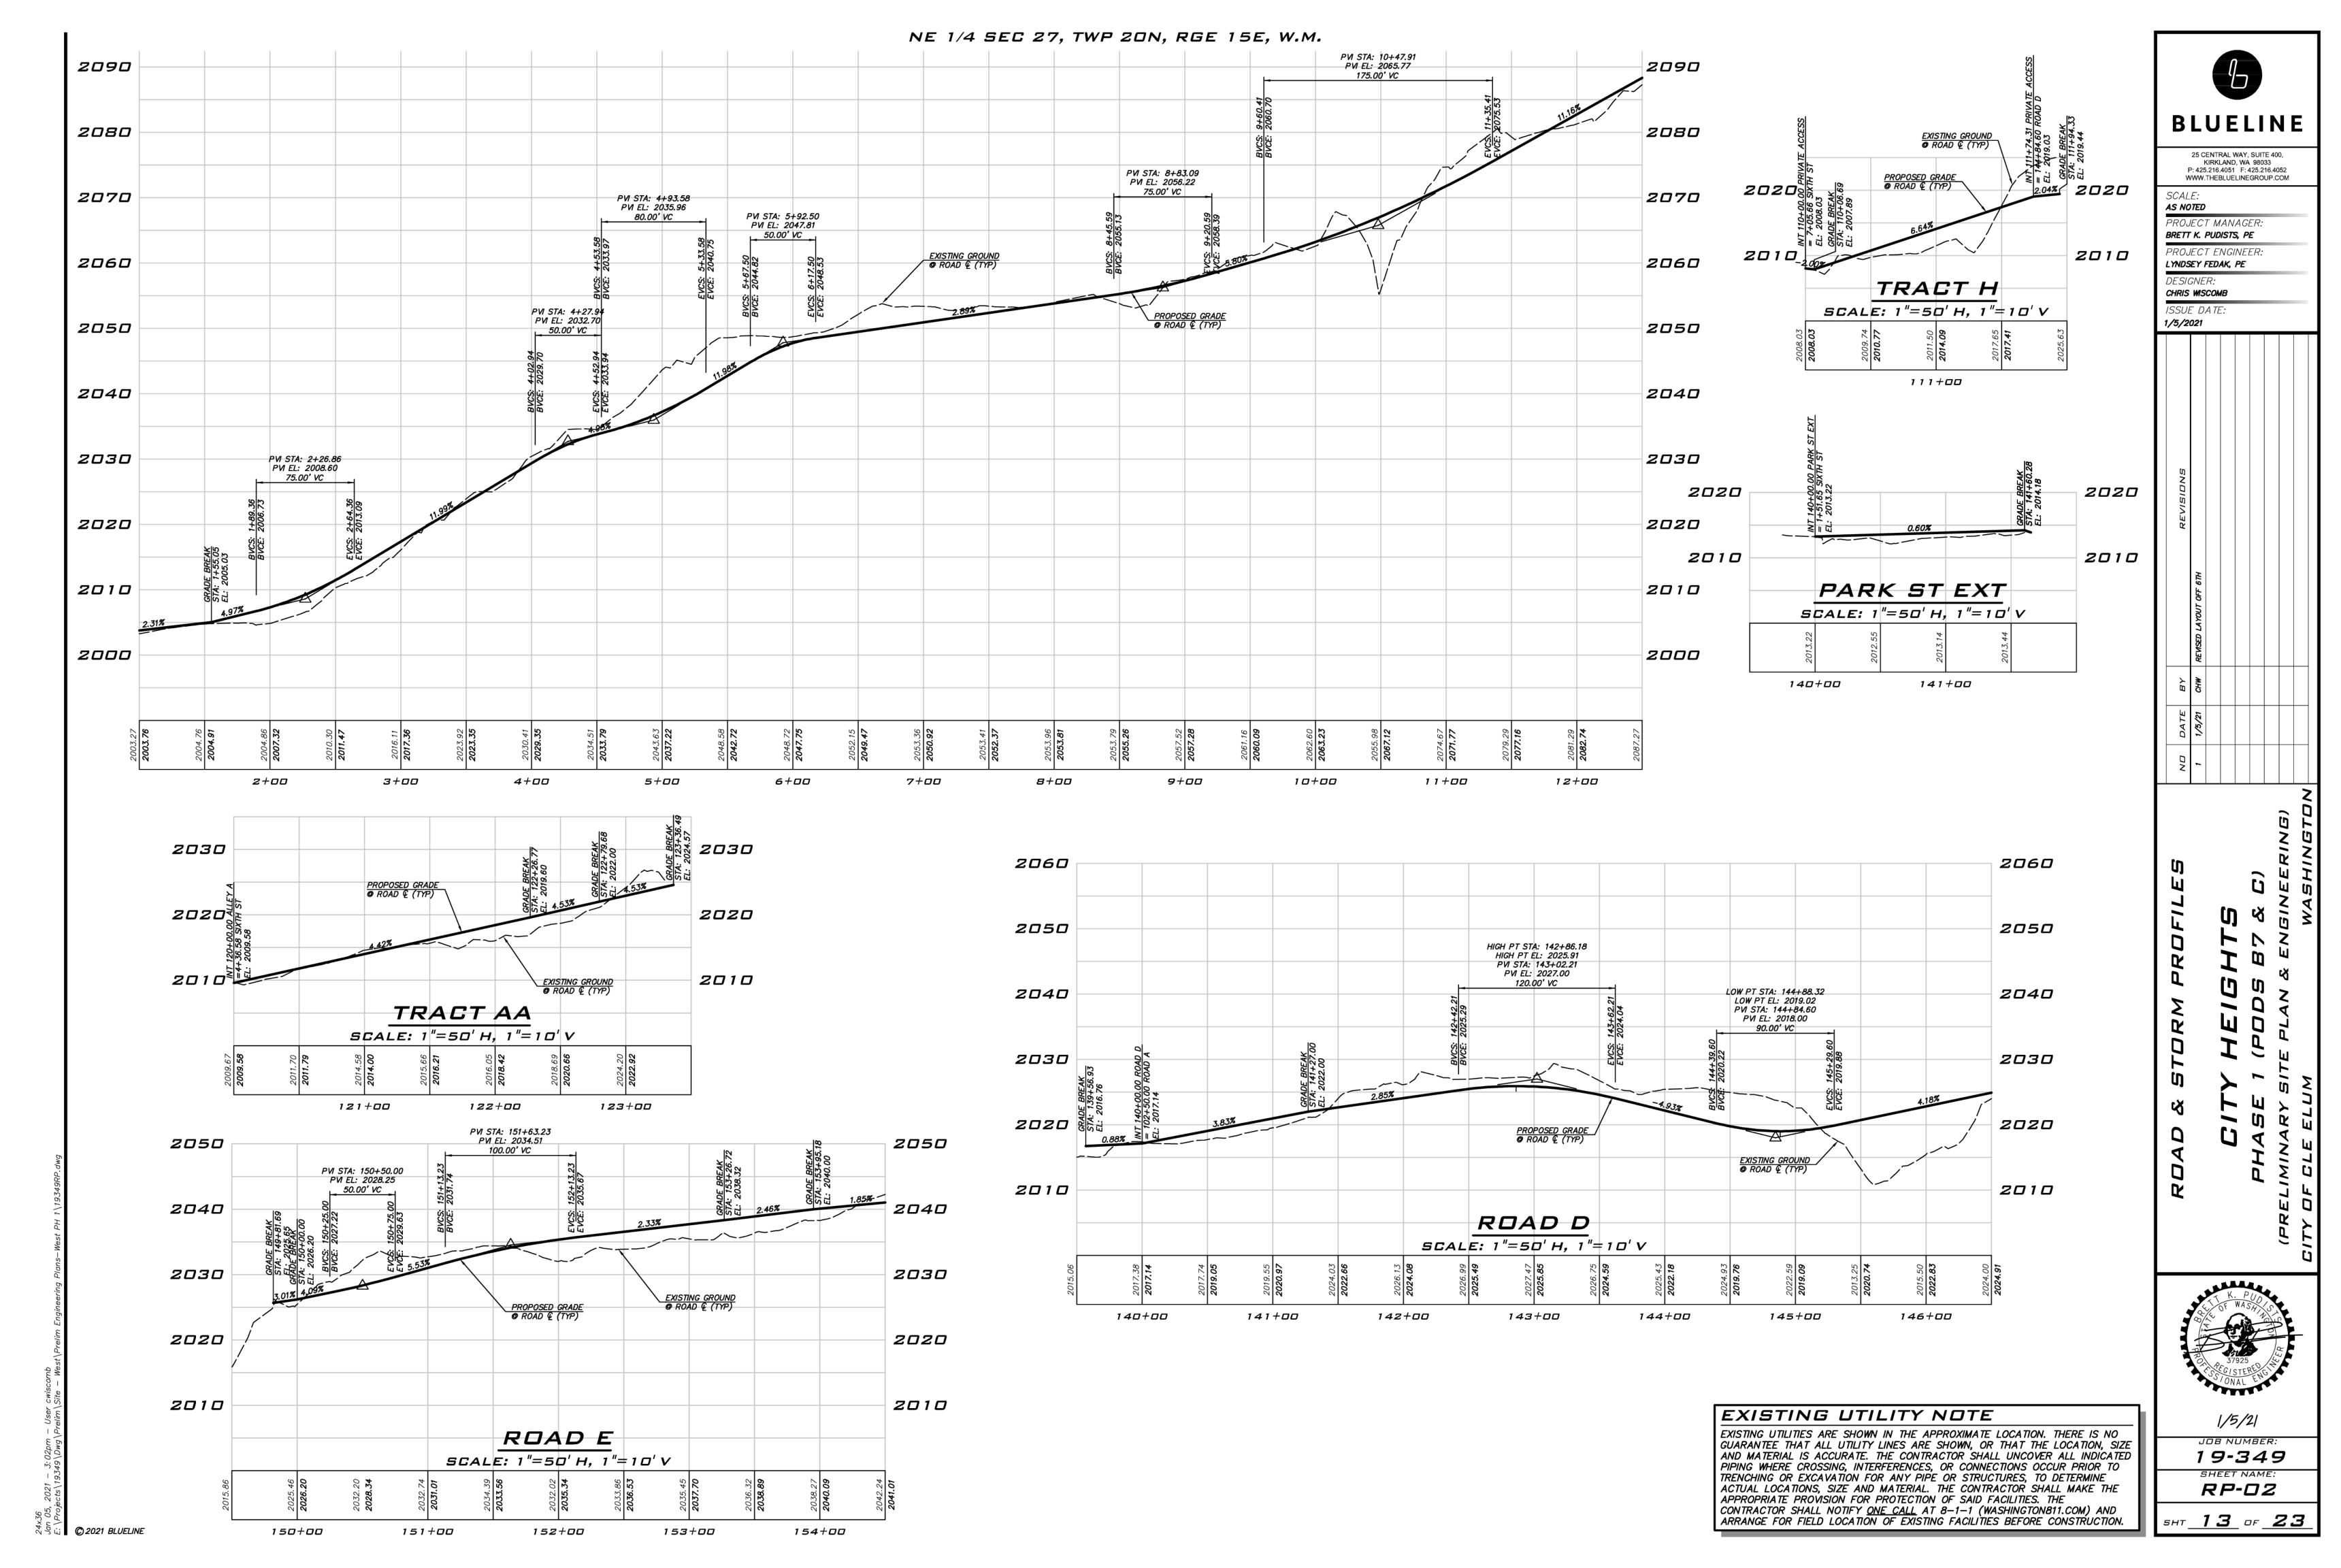

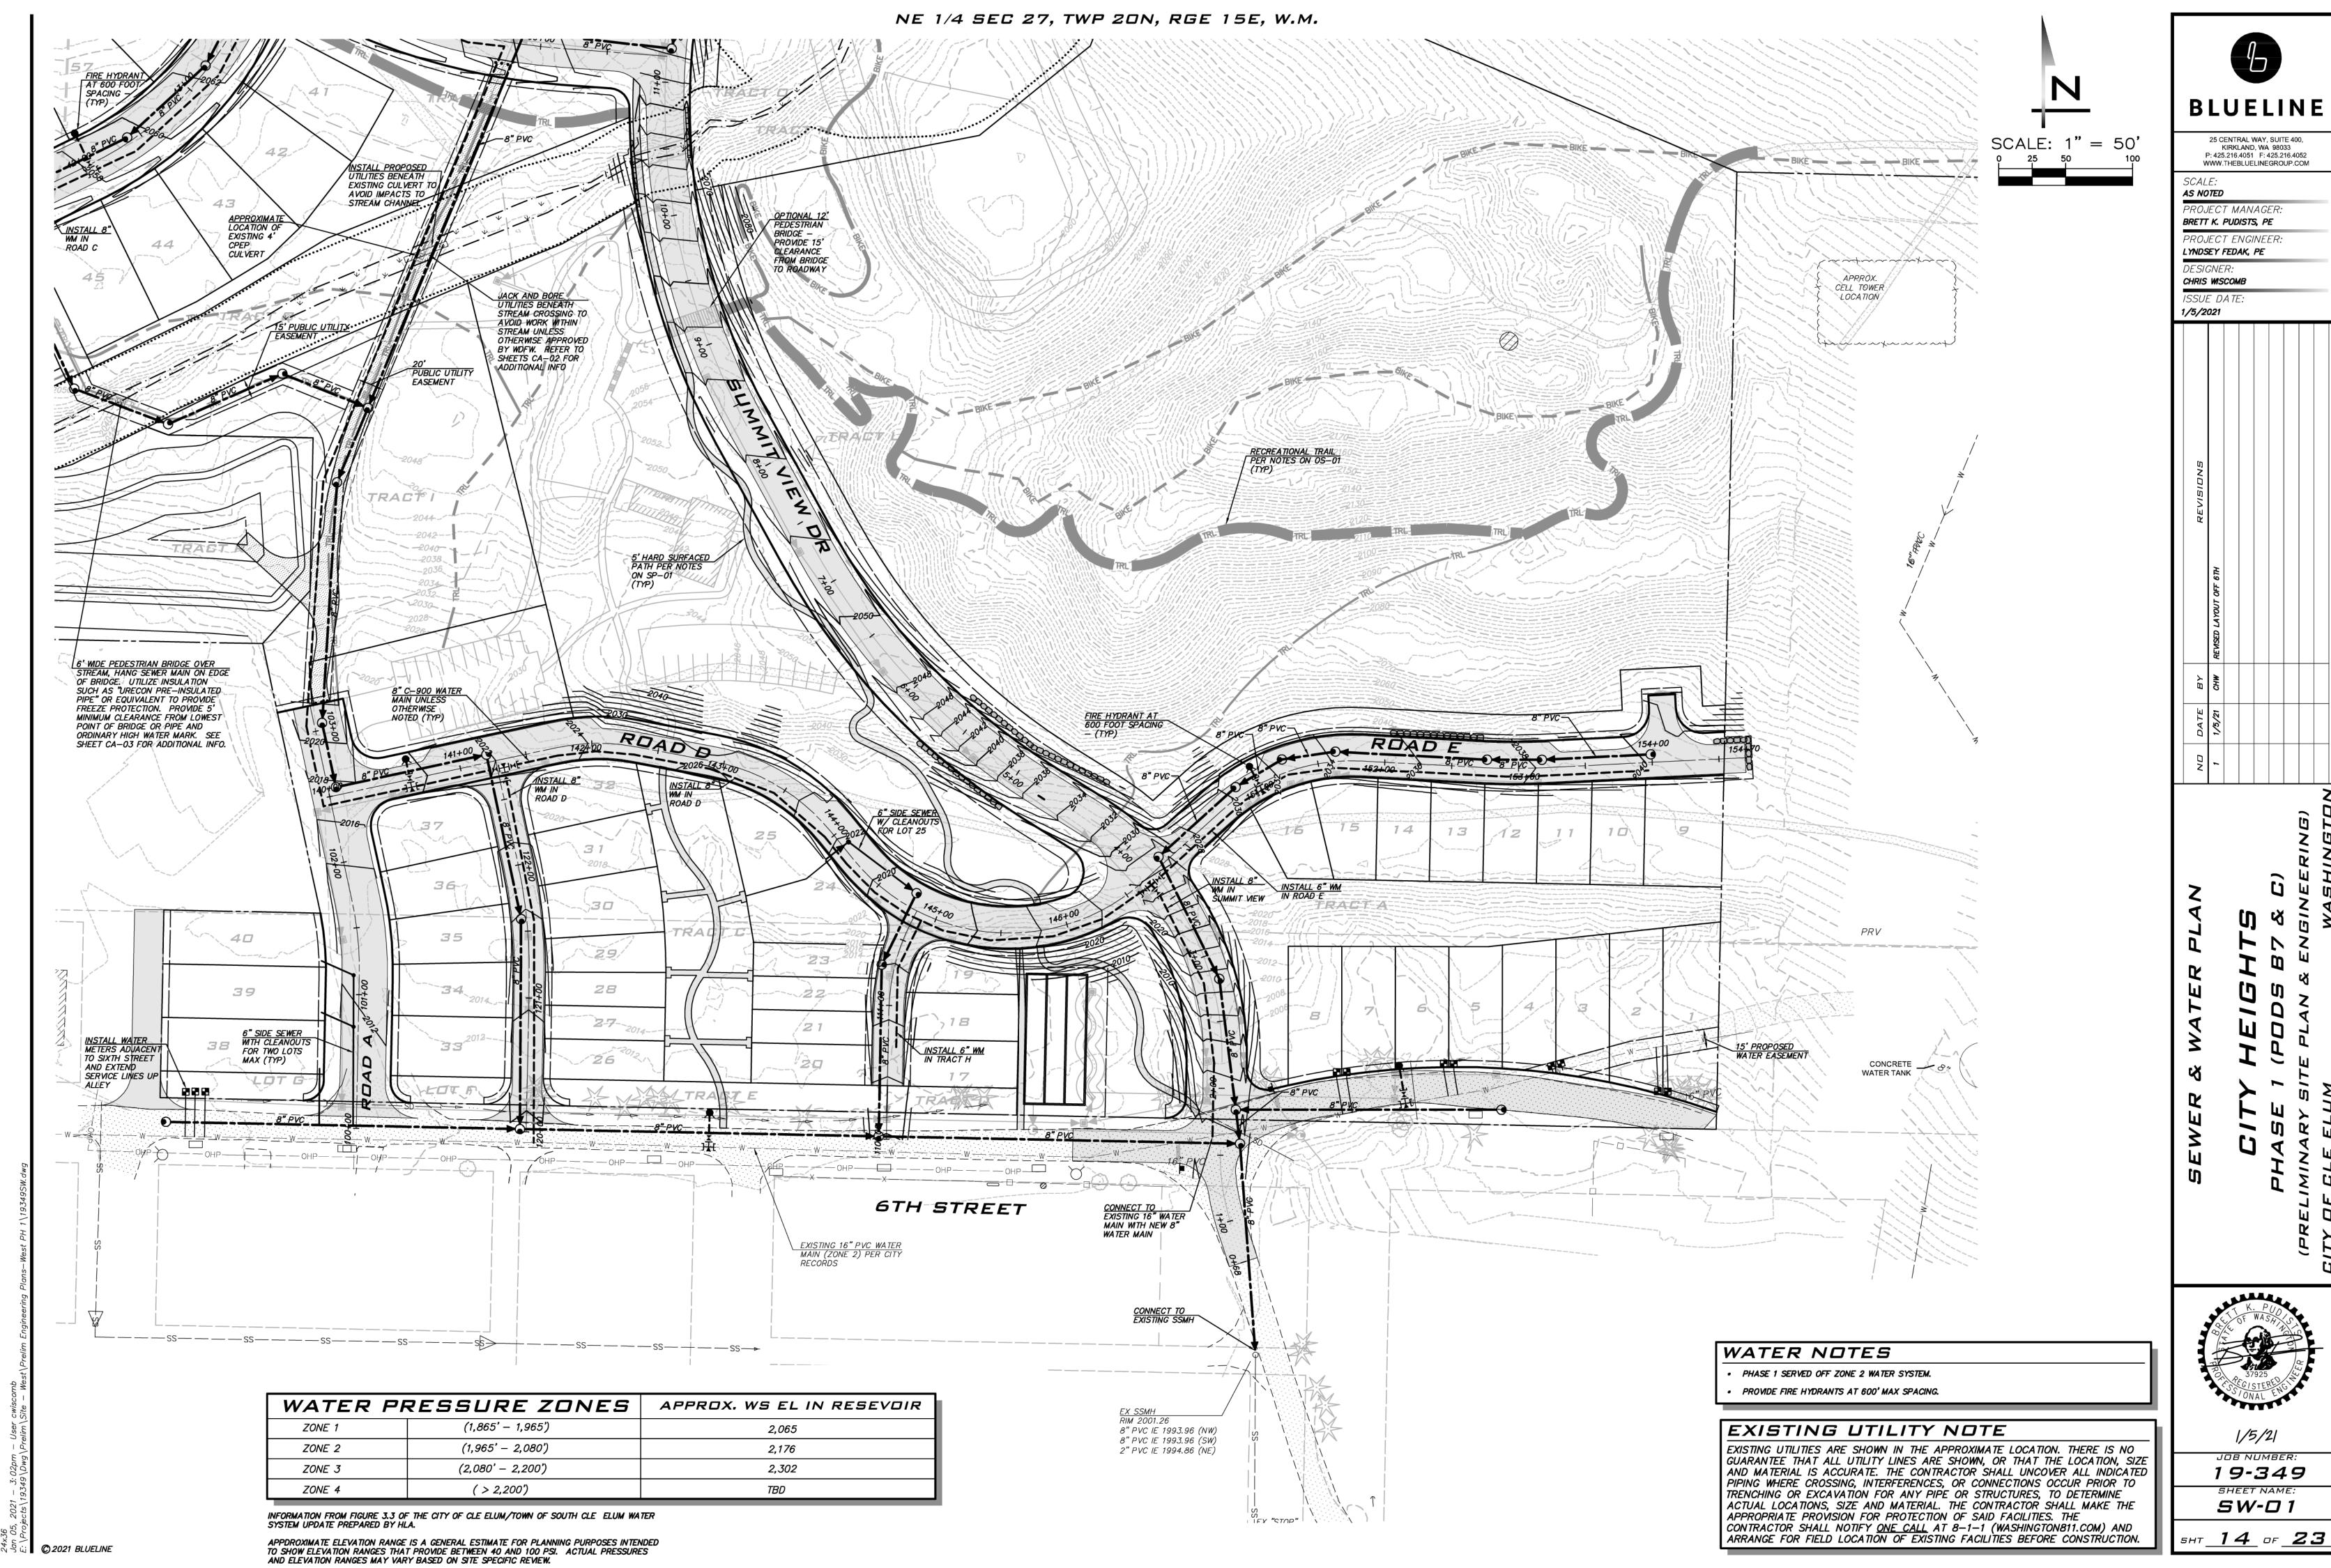

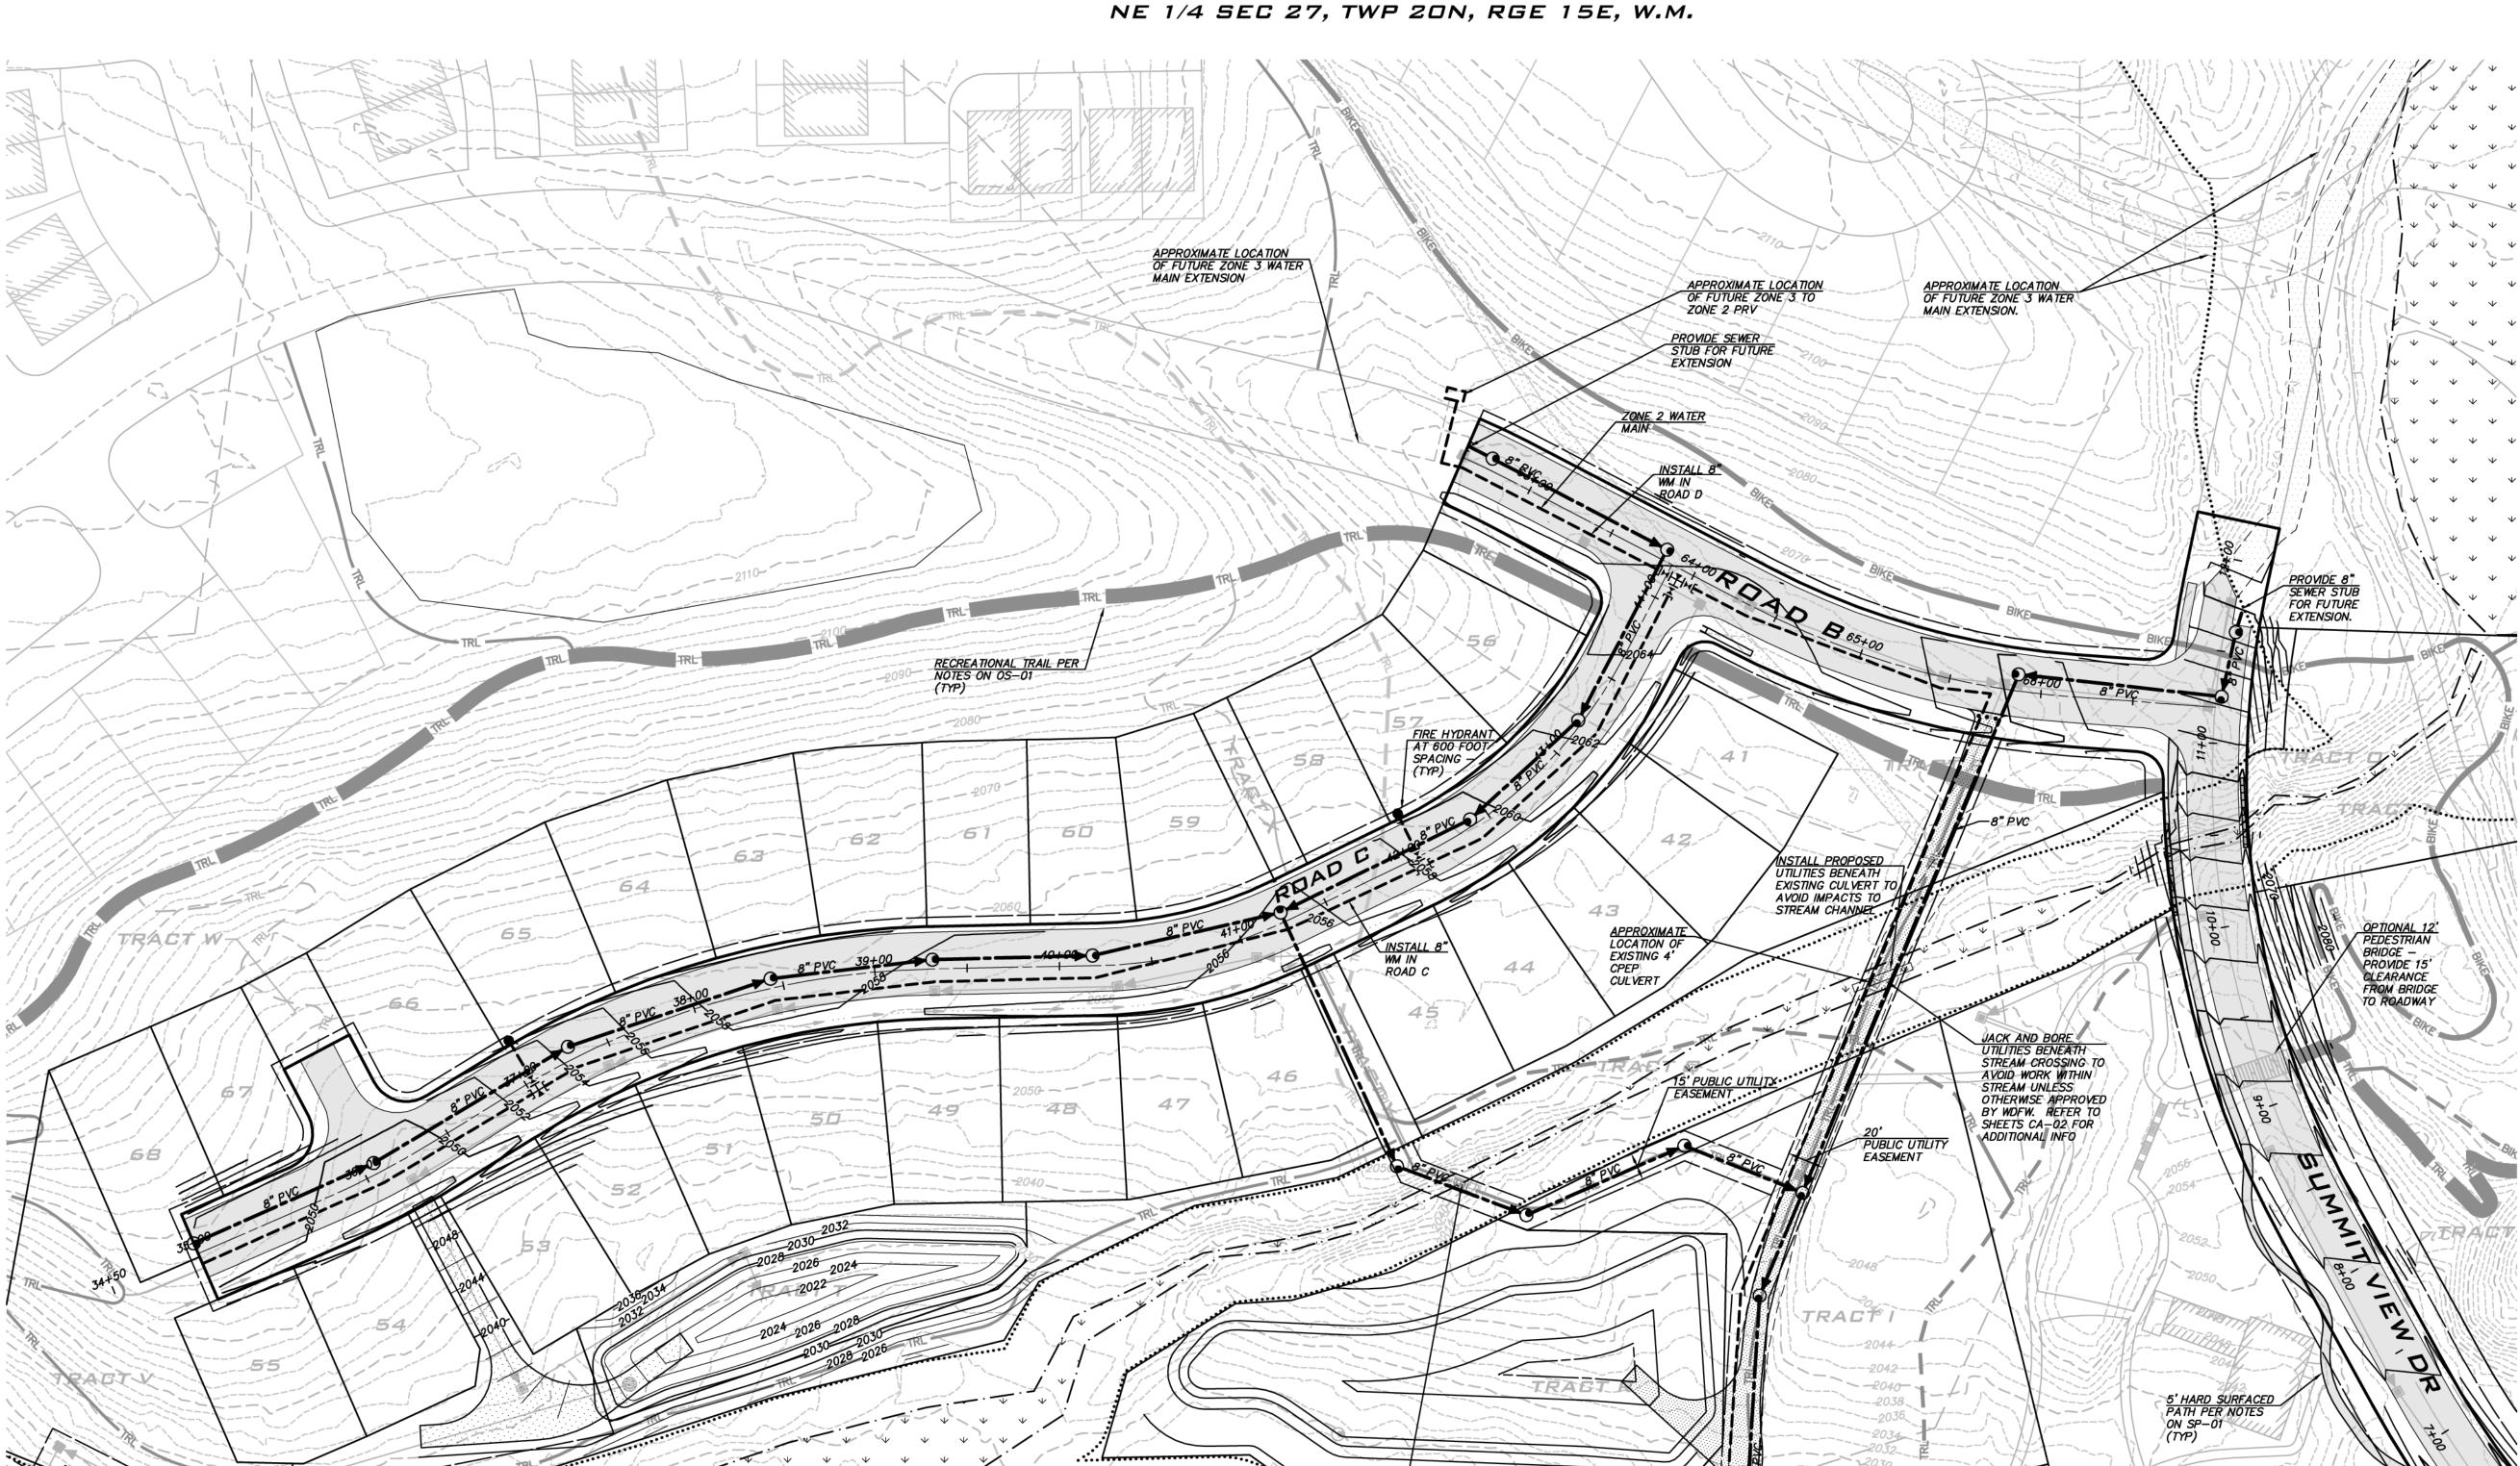

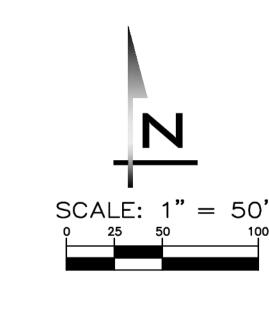



25 CENTRAL WAY, SUITE 400, KIRKLAND, WA 98033 P: 425.216.4051 F: 425.216.4052 WWW.THEBLUELINEGROUP.COM


SCALE: AS NOTED

PROJECT MANAGER: BRETT K. PUDISTS, PE PROJECT ENGINEER:

LYNDSEY FEDAK, PE CHRIS WISCOMB

ISSUE DATE: 1/5/2021

E	ВУ	REVISIONS
li	CHW	CHW REVISED LAYOUT OFF 6TH

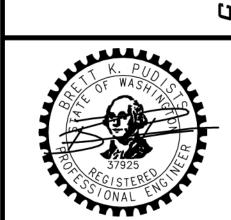

19-349 5W-02

sнт <u>15</u> оғ <u>23</u>

EXISTING UTILITIES ARE SHOWN IN THE APPROXIMATE LOCATION. THERE IS NO GUARANTEE THAT ALL UTILITY LINES ARE SHOWN, OR THAT THE LOCATION, SIZE AND MATERIAL IS ACCURATE. THE CONTRACTOR SHALL UNCOVER ALL INDICATED PIPING WHERE CROSSING, INTERFERENCES, OR CONNECTIONS OCCUR PRIOR TO TRENCHING OR EXCAVATION FOR ANY PIPE OR STRUCTURES, TO DETERMINE ACTUAL LOCATIONS, SIZE AND MATERIAL. THE CONTRACTOR SHALL MAKE THE APPROPRIATE PROVISION FOR PROTECTION OF SAID FACILITIES. THE CONTRACTOR SHALL NOTIFY ONE CALL AT 8-1-1 (WASHINGTON811.COM) AND ARRANGE FOR FIELD LOCATION OF EXISTING FACILITIES BEFORE CONSTRUCTION.

WATER NOTES

PHASE 1 SERVED OFF ZONE 2 WATER SYSTEM. • PROVIDE FIRE HYDRANTS AT 600' MAX SPACING.

EXISTING UTILITY NOTE

WATER PRESSURE ZONES		APPROX. WS EL IN RESEVOIR
ZONE 1	(1,865' – 1,965')	2,065
ZONE 2	(1,965' – 2,080')	2,176
ZONE 3	(2,080' – 2,200')	2,302
ZONE 4	( > 2,200')	TBD


8" C-900 WATER MAIN UNLESS OTHERWISE NOTED (TYP)

6' WIDE PEDESTRIAN BRIDGE OVER STREAM, HANG SEWER MAIN ON EDGE OF BRIDGE. UTILIZE INSULATION


SUCH AS "URECON PRE-INSULATION SUCH AS "URECON PRE-INSULATED PIPE" OR EQUIVALENT TO PROVIDE 5' MINIMUM CLEARANCE FROM LOWEST POINT OF BRIDGE OR PIPE AND ORDINARY HIGH WATER MARK. SEE SHEET CA-03 FOR ADDITIONAL INFO.

INFORMATION FROM FIGURE 3.3 OF THE CITY OF CLE ELUM/TOWN OF SOUTH CLE ELUM WATER SYSTEM UPDATE PREPARED BY HLA.


APPDROXIMATE ELEVATION RANGE IS A GENERAL ESTIMATE FOR PLANNING PURPOSES INTENDED TO SHOW ELEVATION RANGES THAT PROVIDE BETWEEN 40 AND 100 PSI. ACTUAL PRESSURES AND ELEVATION RANGES MAY VARY BASED ON SITE SPECIFIC REVIEW.

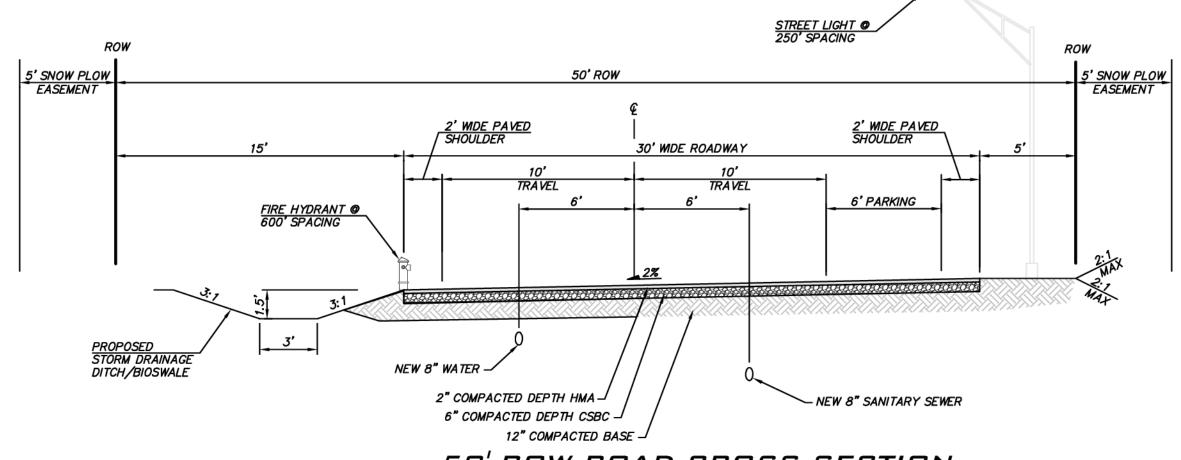


# 50' ROW ROAD CROSS SECTION INTERNAL ROAD (ROAD C) (W/ PARKING ON ONE SIDE) NOT TO SCALE

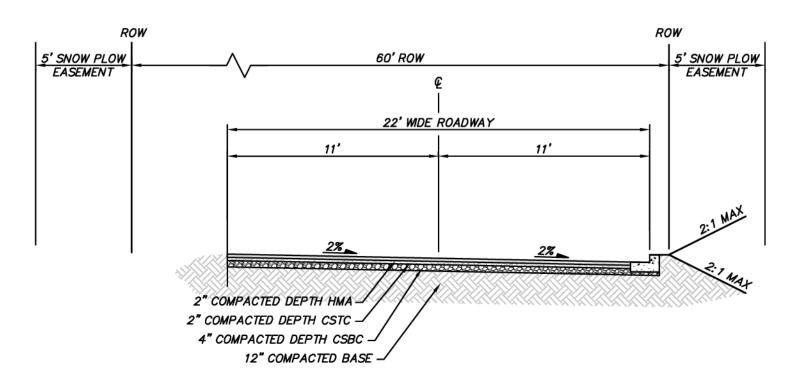


# PARK ST EXTENSION (HALF STREET IMPROVEMENTS) NOT TO SCALE

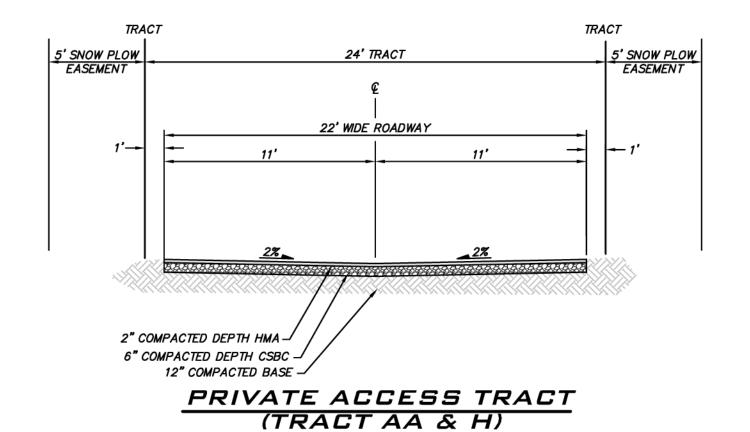


NOT TO SCALE

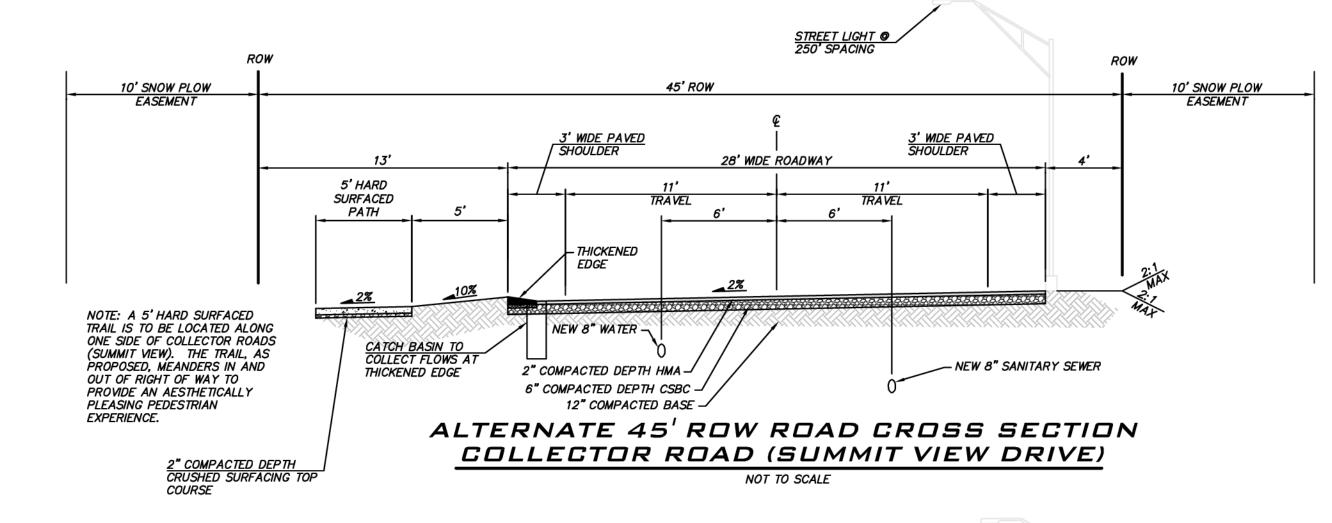


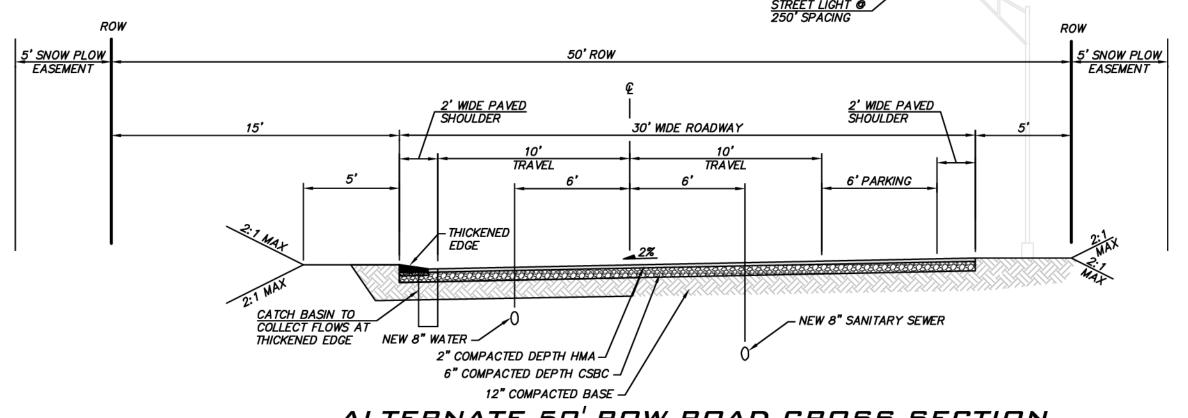

# ALTERNATE 50' ROW ROAD CROSS SECTION INTERNAL ROAD (ROADS A & B) (W/ PARKING ON ONE SIDE)

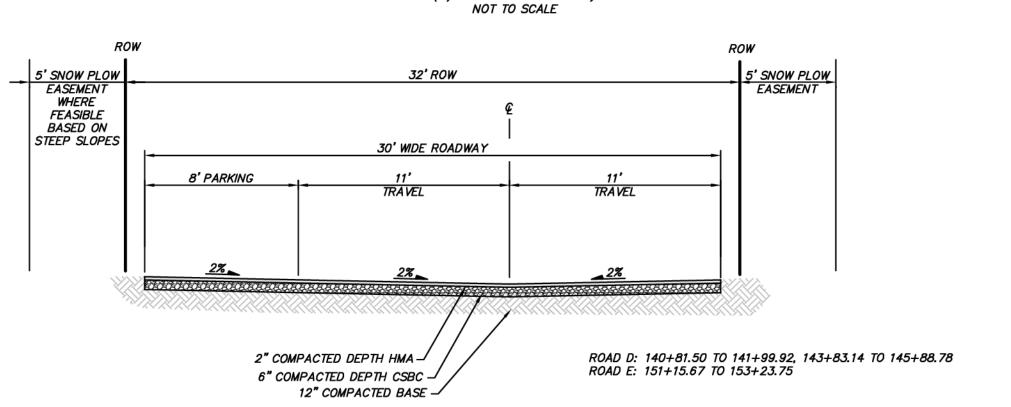


# MODIFIED ROAD W/ PARKING (ROAD D&E)

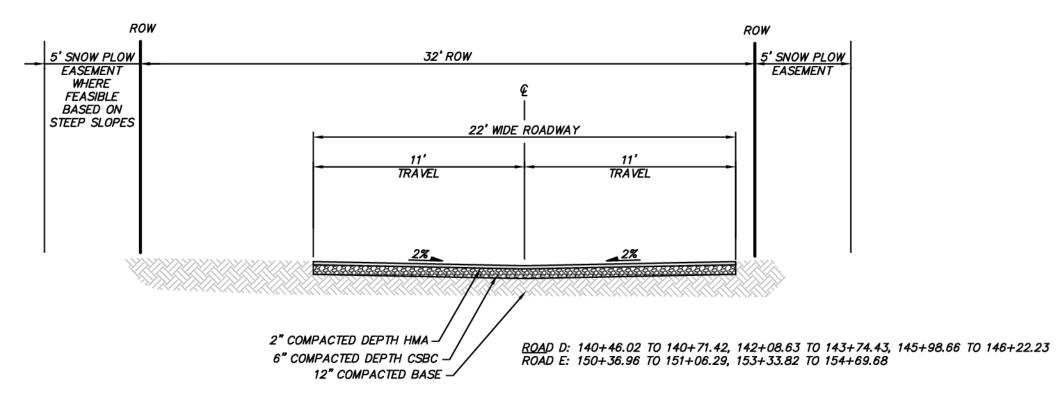

## MODIFIED ROAD W/O PARKING (ROAD D&E)

#### EXISTING UTILITY NOTE

EXISTING UTILITIES ARE SHOWN IN THE APPROXIMATE LOCATION. THERE IS NO GUARANTEE THAT ALL UTILITY LINES ARE SHOWN, OR THAT THE LOCATION, SIZE AND MATERIAL IS ACCURATE. THE CONTRACTOR SHALL UNCOVER ALL INDICATED PIPING WHERE CROSSING, INTERFERENCES, OR CONNECTIONS OCCUR PRIOR TO TRENCHING OR EXCAVATION FOR ANY PIPE OR STRUCTURES, TO DETERMINE ACTUAL LOCATIONS, SIZE AND MATERIAL. THE CONTRACTOR SHALL MAKE THE APPROPRIATE PROVISION FOR PROTECTION OF SAID FACILITIES. THE CONTRACTOR SHALL NOTIFY ONE CALL AT 8-1-1 (WASHINGTON811.COM) AND ARRANGE FOR FIELD LOCATION OF EXISTING FACILITIES BEFORE CONSTRUCTION.

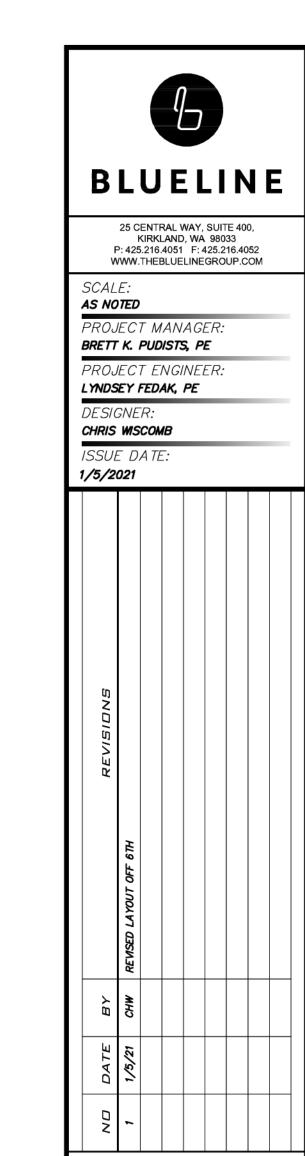

**16 HTS** 05 B7 & C) NN & ENGINEERING)

CITY HEIGHT PHASE 1 (PODS B7


K. PUO WASH JACON 37925 SSIONAL ENGINEERS


1/5/21


19-349 SHEET NAME: RD-01

sнт <u>16</u> оғ <u>23</u>

© 2021 BLUELINE

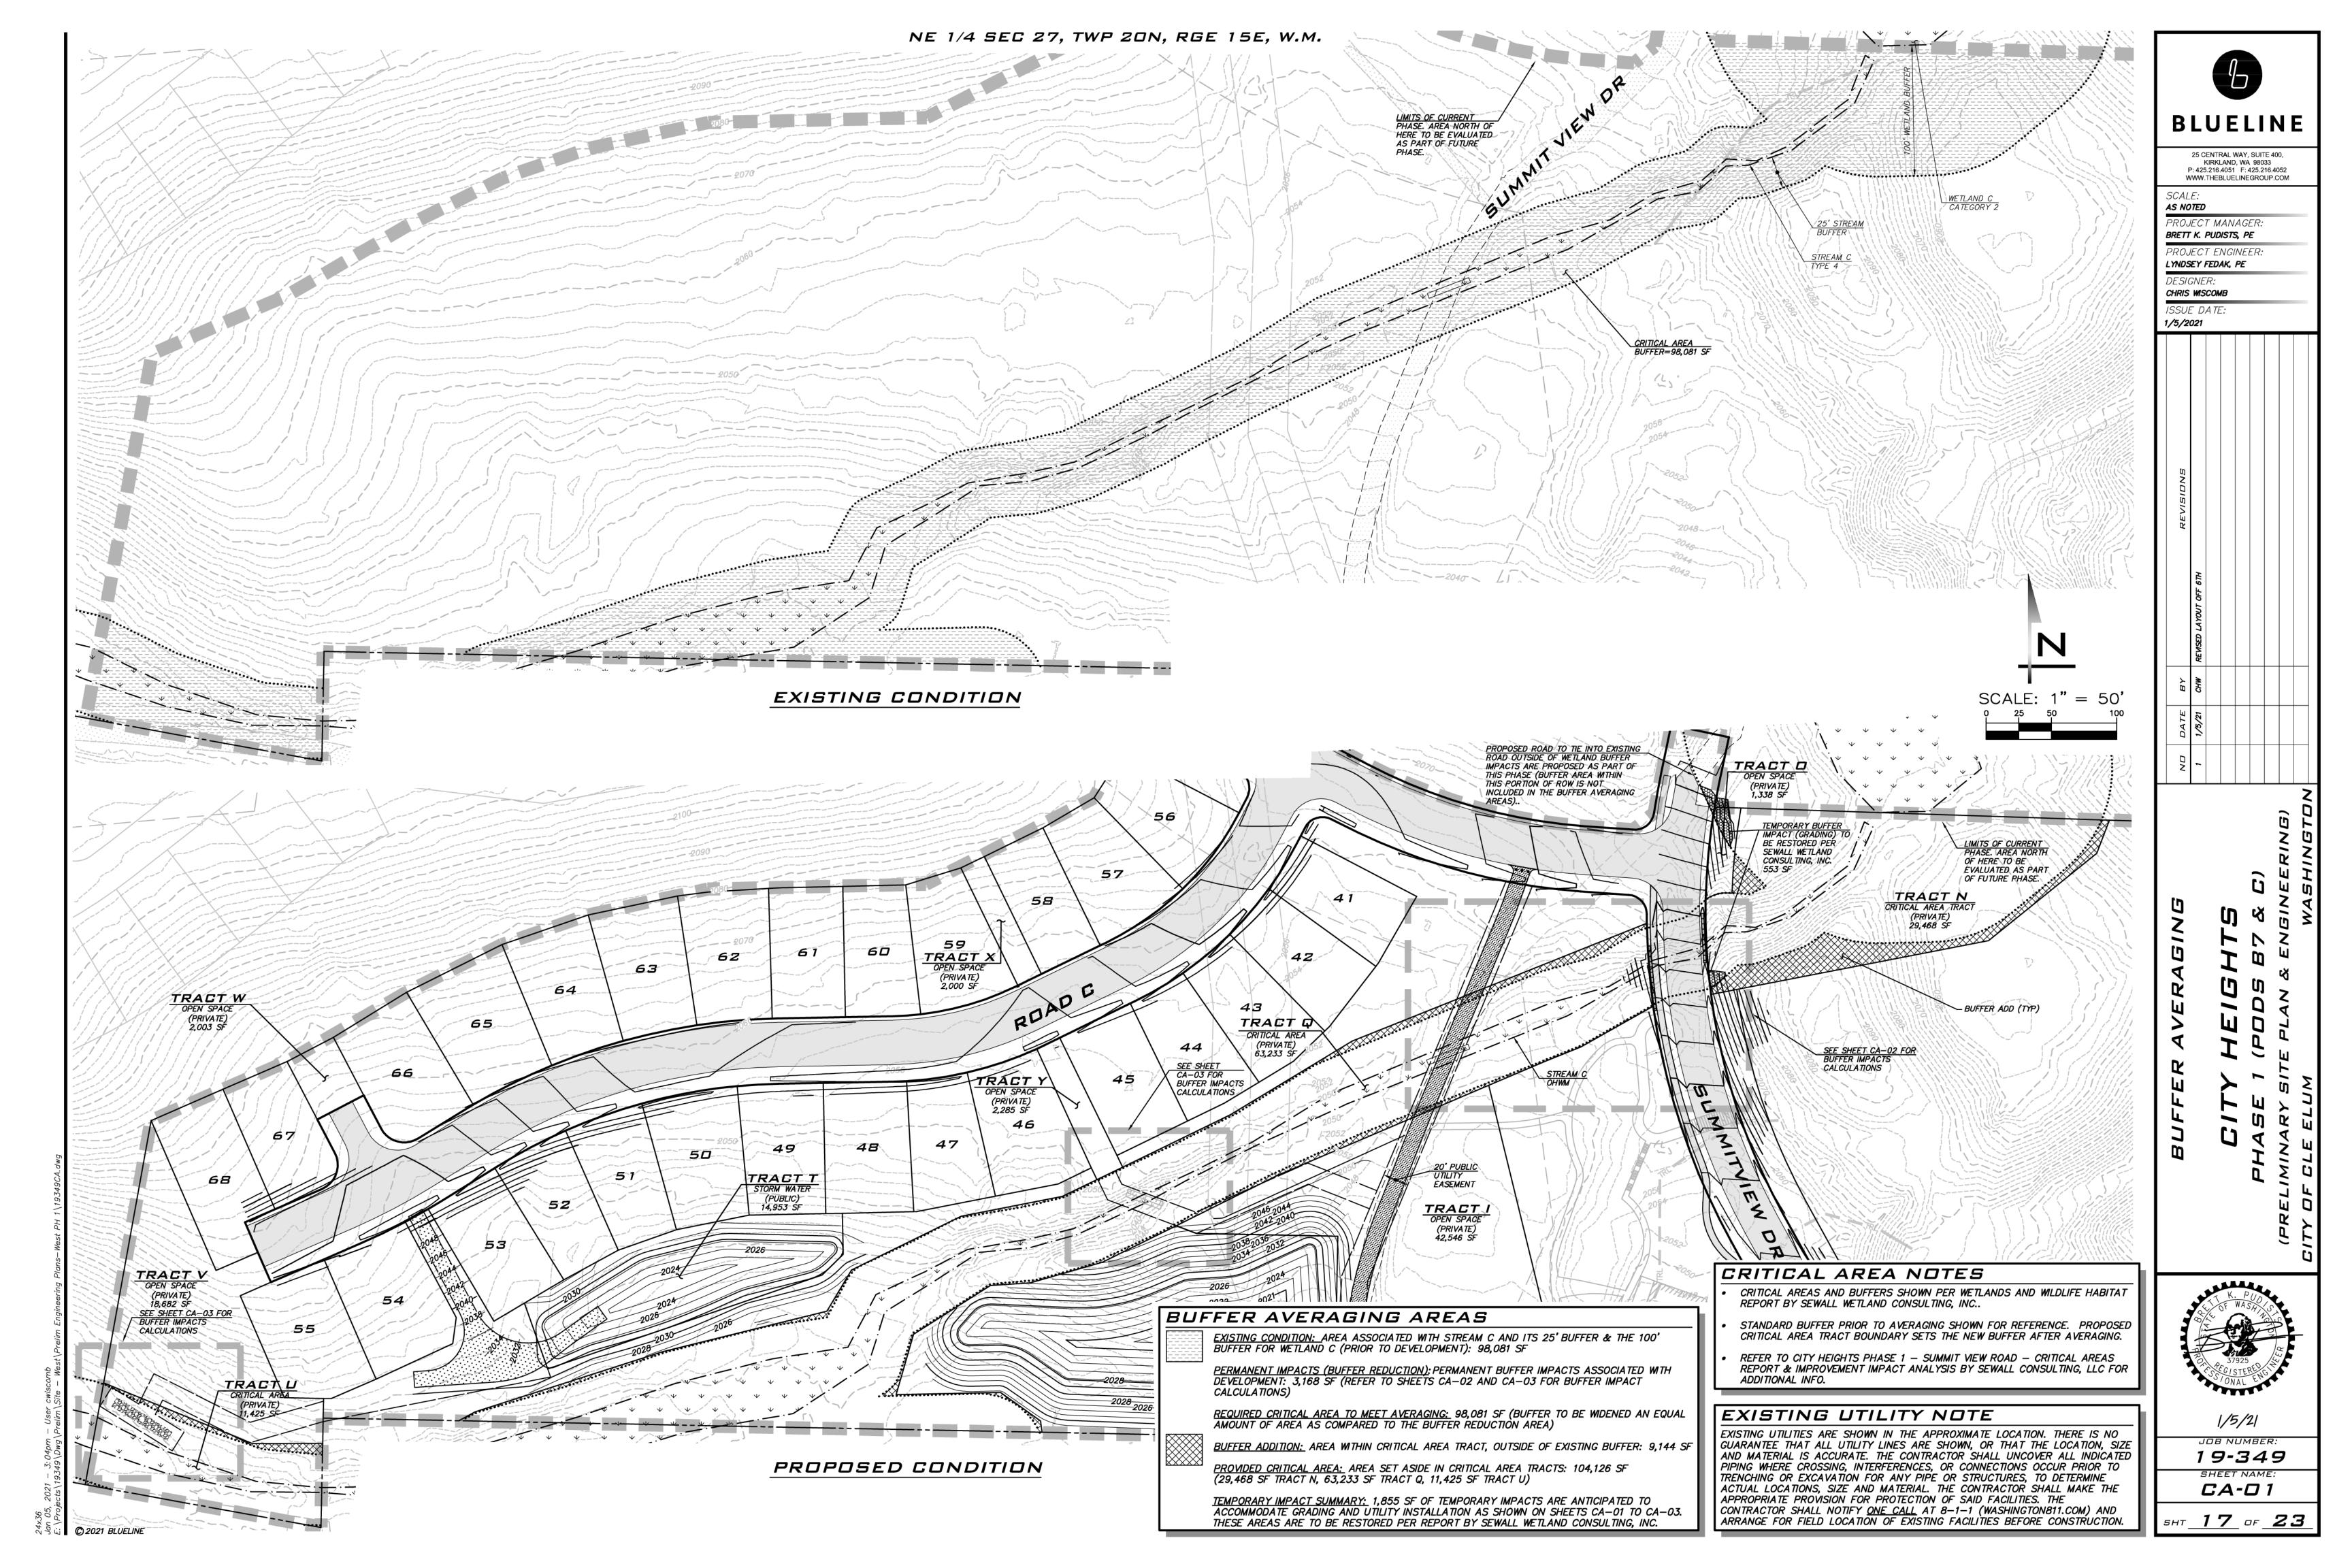

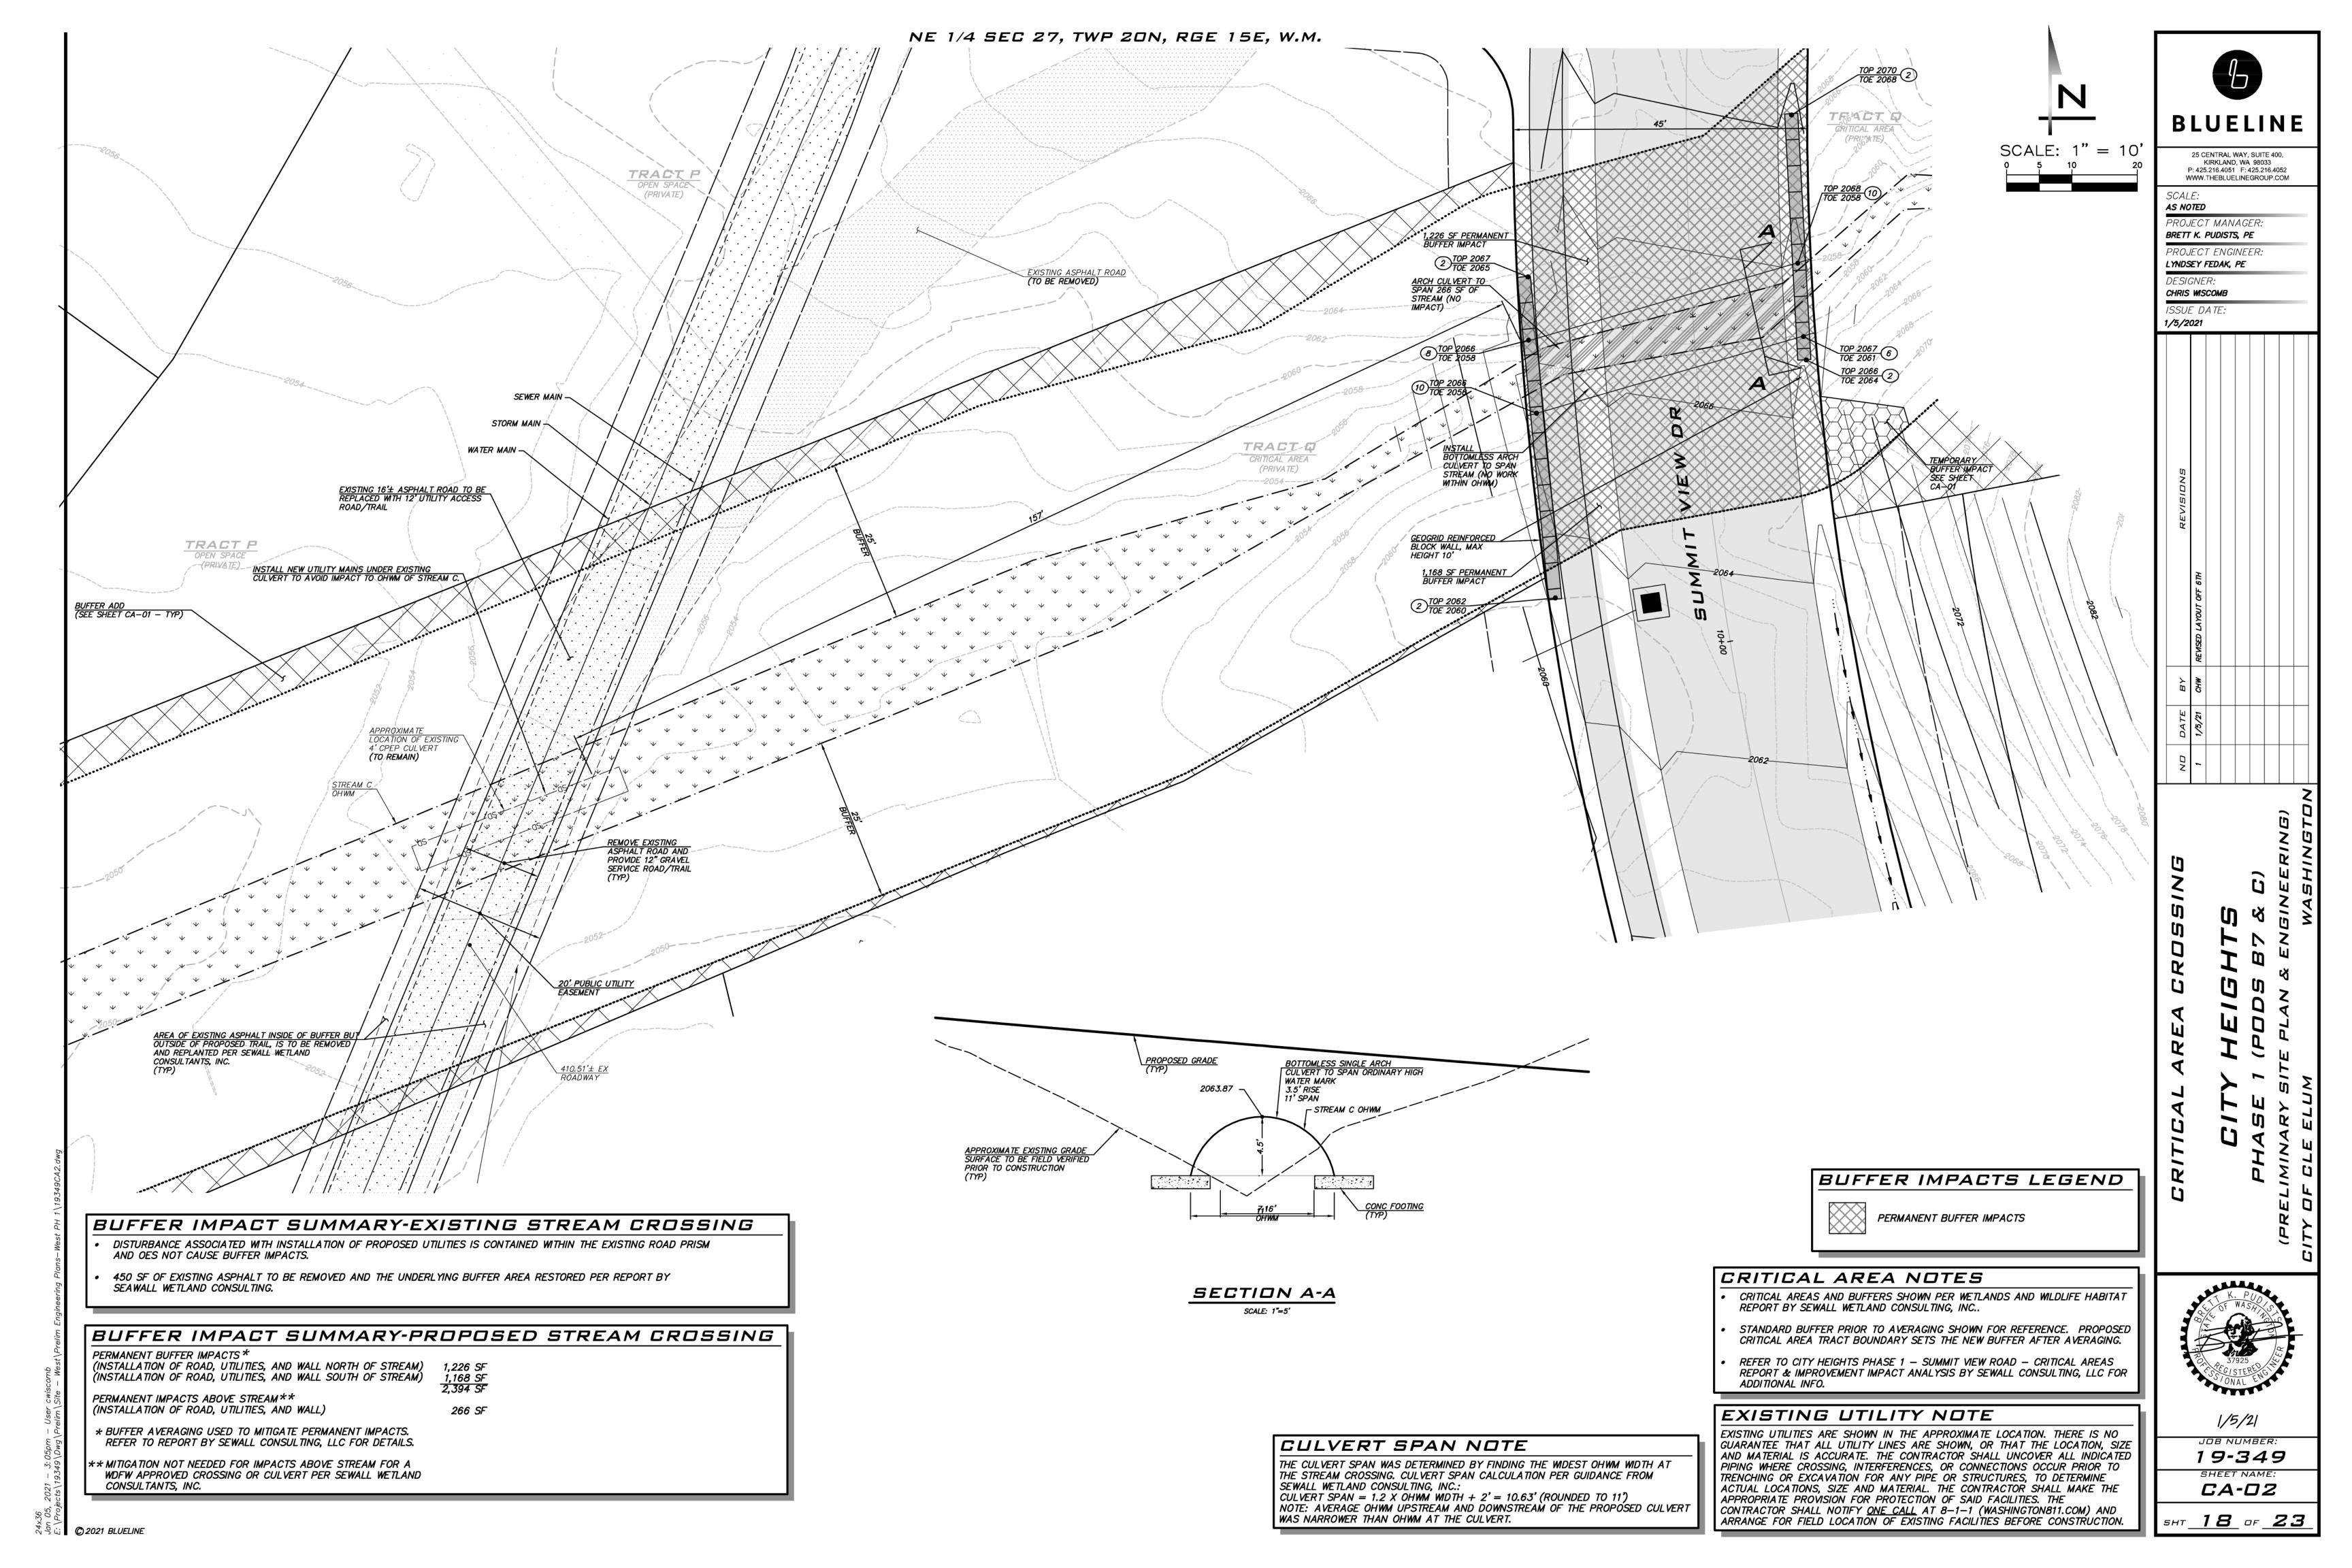

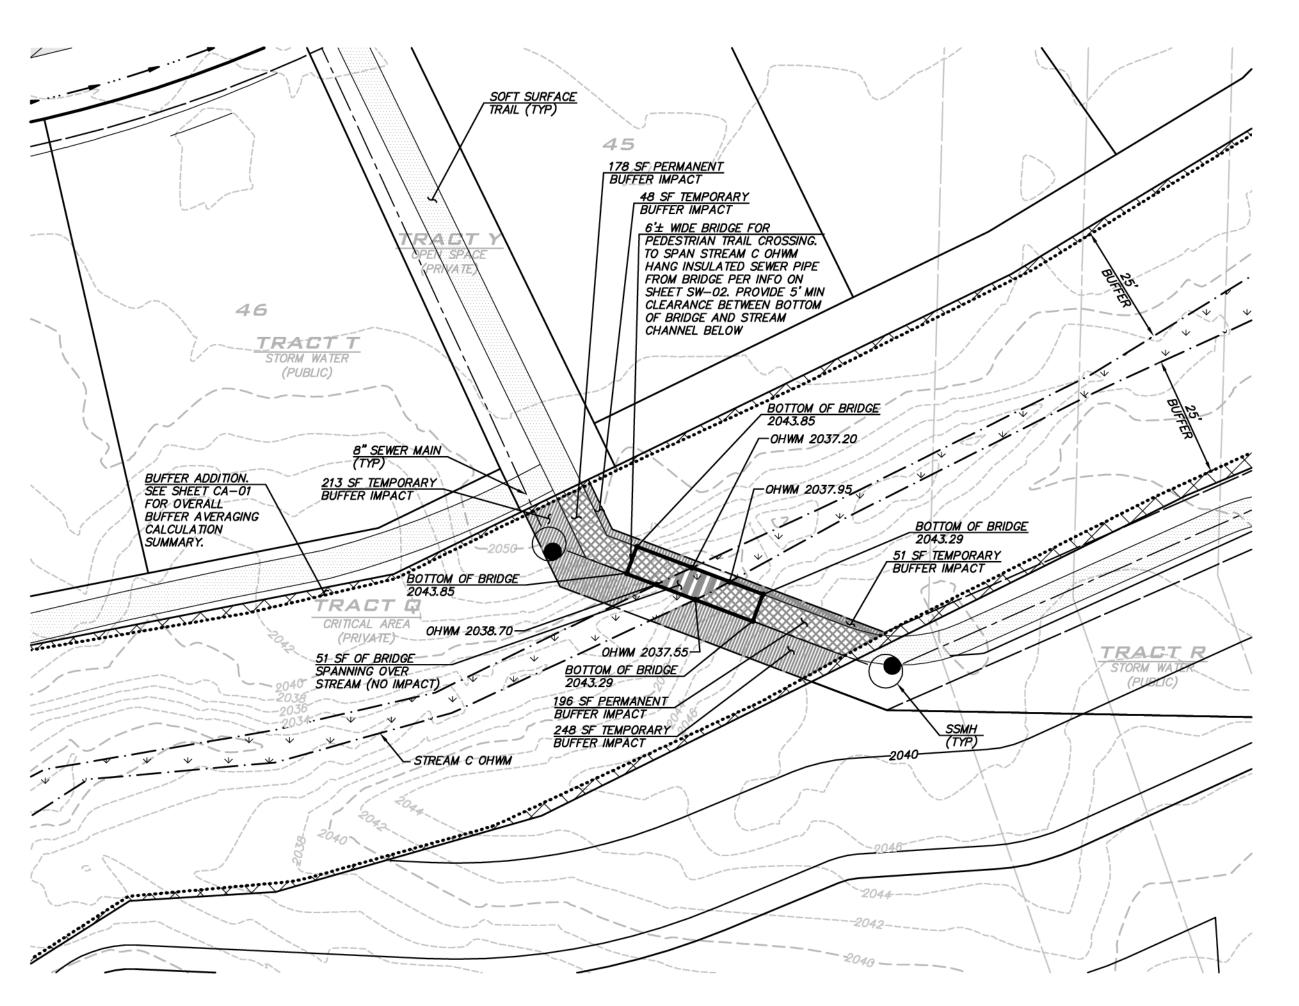

BUFFER IMPACT SUMMARY-PROPOSED STREAM CROSSING

178 SF 196 SF 374 SF

51 SF

PERMANENT BUFFER IMPACTS \*
(6' TRAIL WEST OF STREAM)
(6' TRAIL EAST OF STREAM)

TEMPORARY BUFFER IMPACT \*\*\*

WETLAND CONSULTANTS, INC.

BRIDGE ABOVE STREAM \*\*

(NO IMPACT)

(INSTALLATION OF BRIDGE, SEWER, & TRAIL WEST OF STREAM)

(INSTALLATION OF BRIDGE, SEWER, & TRAIL EAST OF STREAM)


REPORT BY SEWALL CONSULTING, LLC FOR DETAILS.

BUFFER AVERAGING USED TO MITIGATE PERMANENT INAPOCTS. REFER TO

APPROVED CROSSING OR CULVERT PER SEWALL WETLAND CONSULTANTS, INC.

MITIGATION NOT NEEDED FOR IMPACTS ABOVE STREAM FOR A WDFW

RESTORATION OF TEMPORARY BUFFER IMPACTS REPORT BY SEWALL

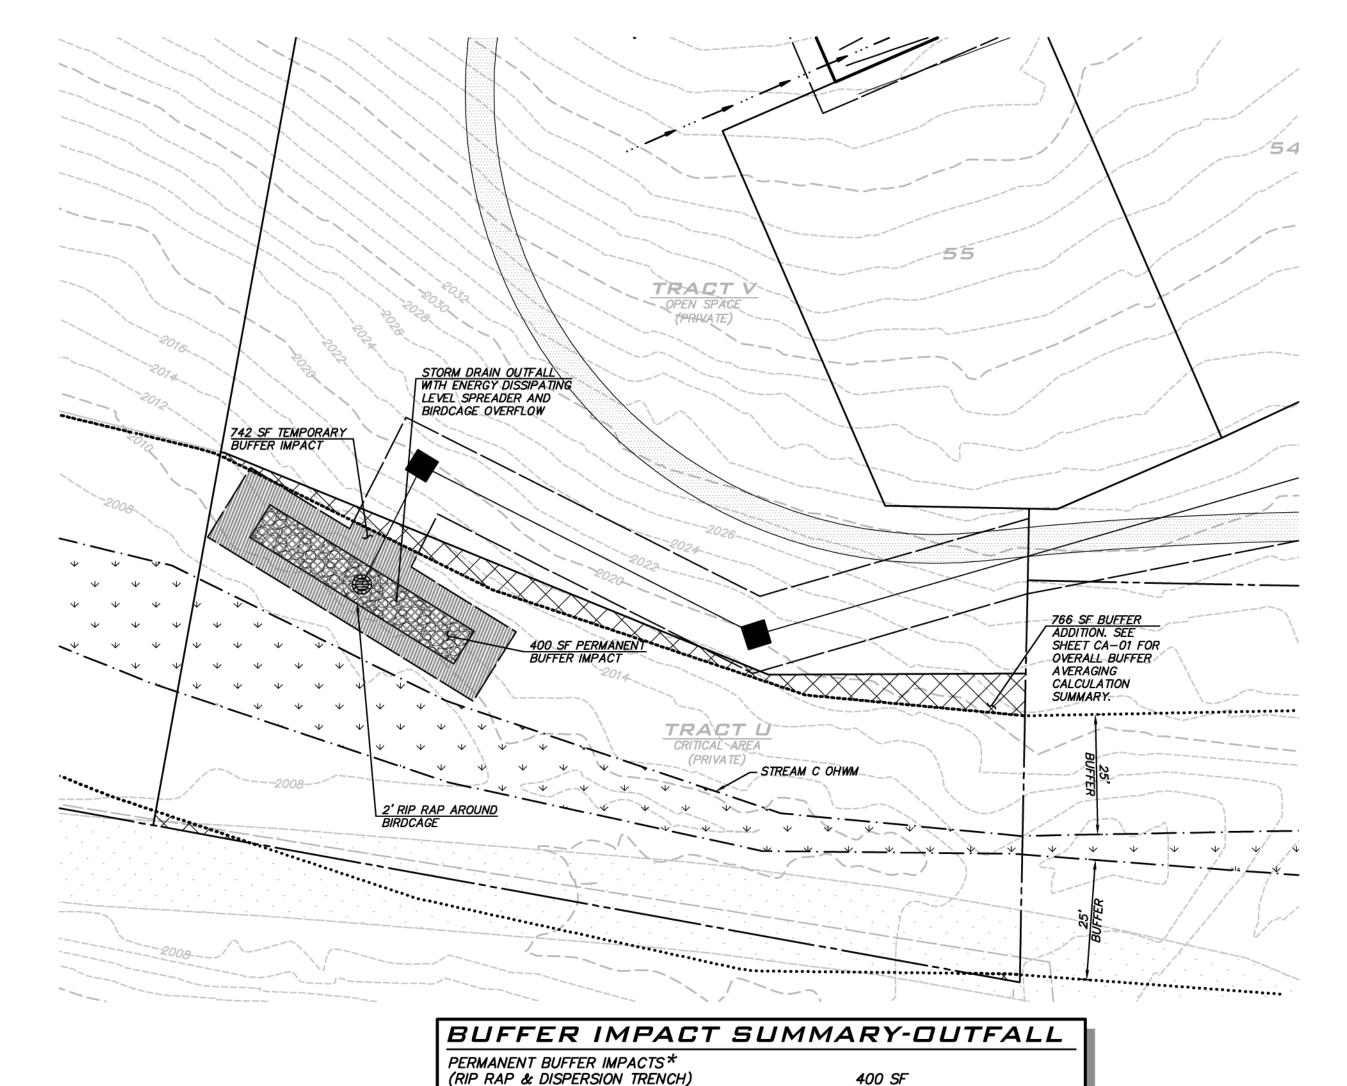

TEMPORARY BUFFER IMPACT \*\*

WETLAND CONSULTANTS, INC.


\* BUFFER AVERAGING USED TO MITIGATE PERMANENT

INAPOCTS. REFER TO REPORT BY SEWALL CONSULTING, LLC

\*\* RESTORATION OF TEMPORARY BUFFER IMPACTS PER SEWALL

(UTILITY INSTALLATION)

FOR DETAILS.

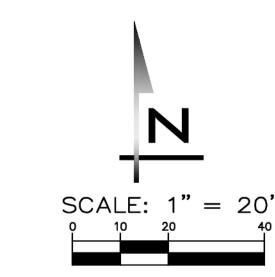



25 CENTRAL WAY, SUITE 400, KIRKLAND, WA 98033 P: 425.216.4051 F: 425.216.4052

WWW.THEBLUELINEGROUP.COM

AS NOTED PROJECT MANAGER: BRETT K. PUDISTS, PE

PROJECT ENGINEER: LYNDSEY FEDAK, PE

CHRIS WISCOMB ISSUE DATE: 1/5/2021

TEMPORARY IMPACTS (ABOVE STREAM)

PERMANENT IMPACTS (ABOVE STREAM)

BUFFER IMPACTS LEGEND

PERMANENT BUFFER IMPACTS

TEMPORARY BUFFER IMPACTS


CRITICAL AREA NOTES CRITICAL AREAS AND BUFFERS SHOWN PER WETLANDS AND WILDLIFE HABITAT REPORT BY SEWALL WETLAND CONSULTING, INC..

STANDARD BUFFER PRIOR TO AVERAGING SHOWN FOR REFERENCE. PROPOSED CRITICAL AREA TRACT BOUNDARY SETS THE NEW BUFFER AFTER AVERAGING.

REFER TO CITY HEIGHTS PHASE 1 - SUMMIT VIEW ROAD - CRITICAL AREAS REPORT & IMPROVEMENT IMPACT ANALYSIS BY SEWALL CONSULTING, LLC FOR ADDITIONAL INFO.

#### EXISTING UTILITY NOTE

EXISTING UTILITIES ARE SHOWN IN THE APPROXIMATE LOCATION. THERE IS NO GUARANTEE THAT ALL UTILITY LINES ARE SHOWN, OR THAT THE LOCATION, SIZE AND MATERIAL IS ACCURATE. THE CONTRACTOR SHALL UNCOVER ALL INDICATED PIPING WHERE CROSSING, INTERFERENCES, OR CONNECTIONS OCCUR PRIOR TO TRENCHING OR EXCAVATION FOR ANY PIPE OR STRUCTURES, TO DETERMINE ACTUAL LOCATIONS, SIZE AND MATERIAL. THE CONTRACTOR SHALL MAKE THE APPROPRIATE PROVISION FOR PROTECTION OF SAID FACILITIES. THE CONTRACTOR SHALL NOTIFY ONE CALL AT 8-1-1 (WASHINGTON811.COM) AND ARRANGE FOR FIELD LOCATION OF EXISTING FACILITIES BEFORE CONSTRUCTION.

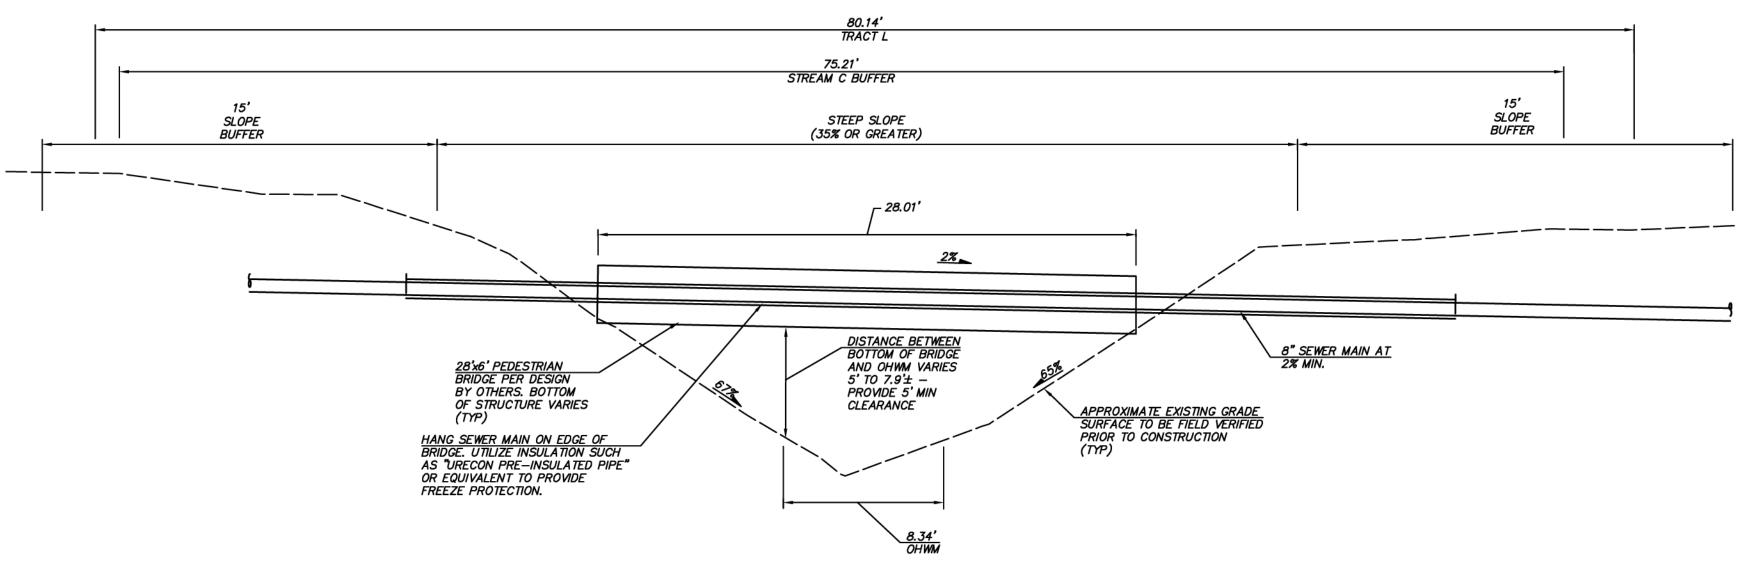

PEDESTRIAN BRIDGE


SCALE: 1"=5"

<sup>₹</sup> <sup>9</sup> ii **© 2021 BLUELINE** 

1/5/21

19-349 CA-03

sнт <u>19</u> оғ <u>23</u>

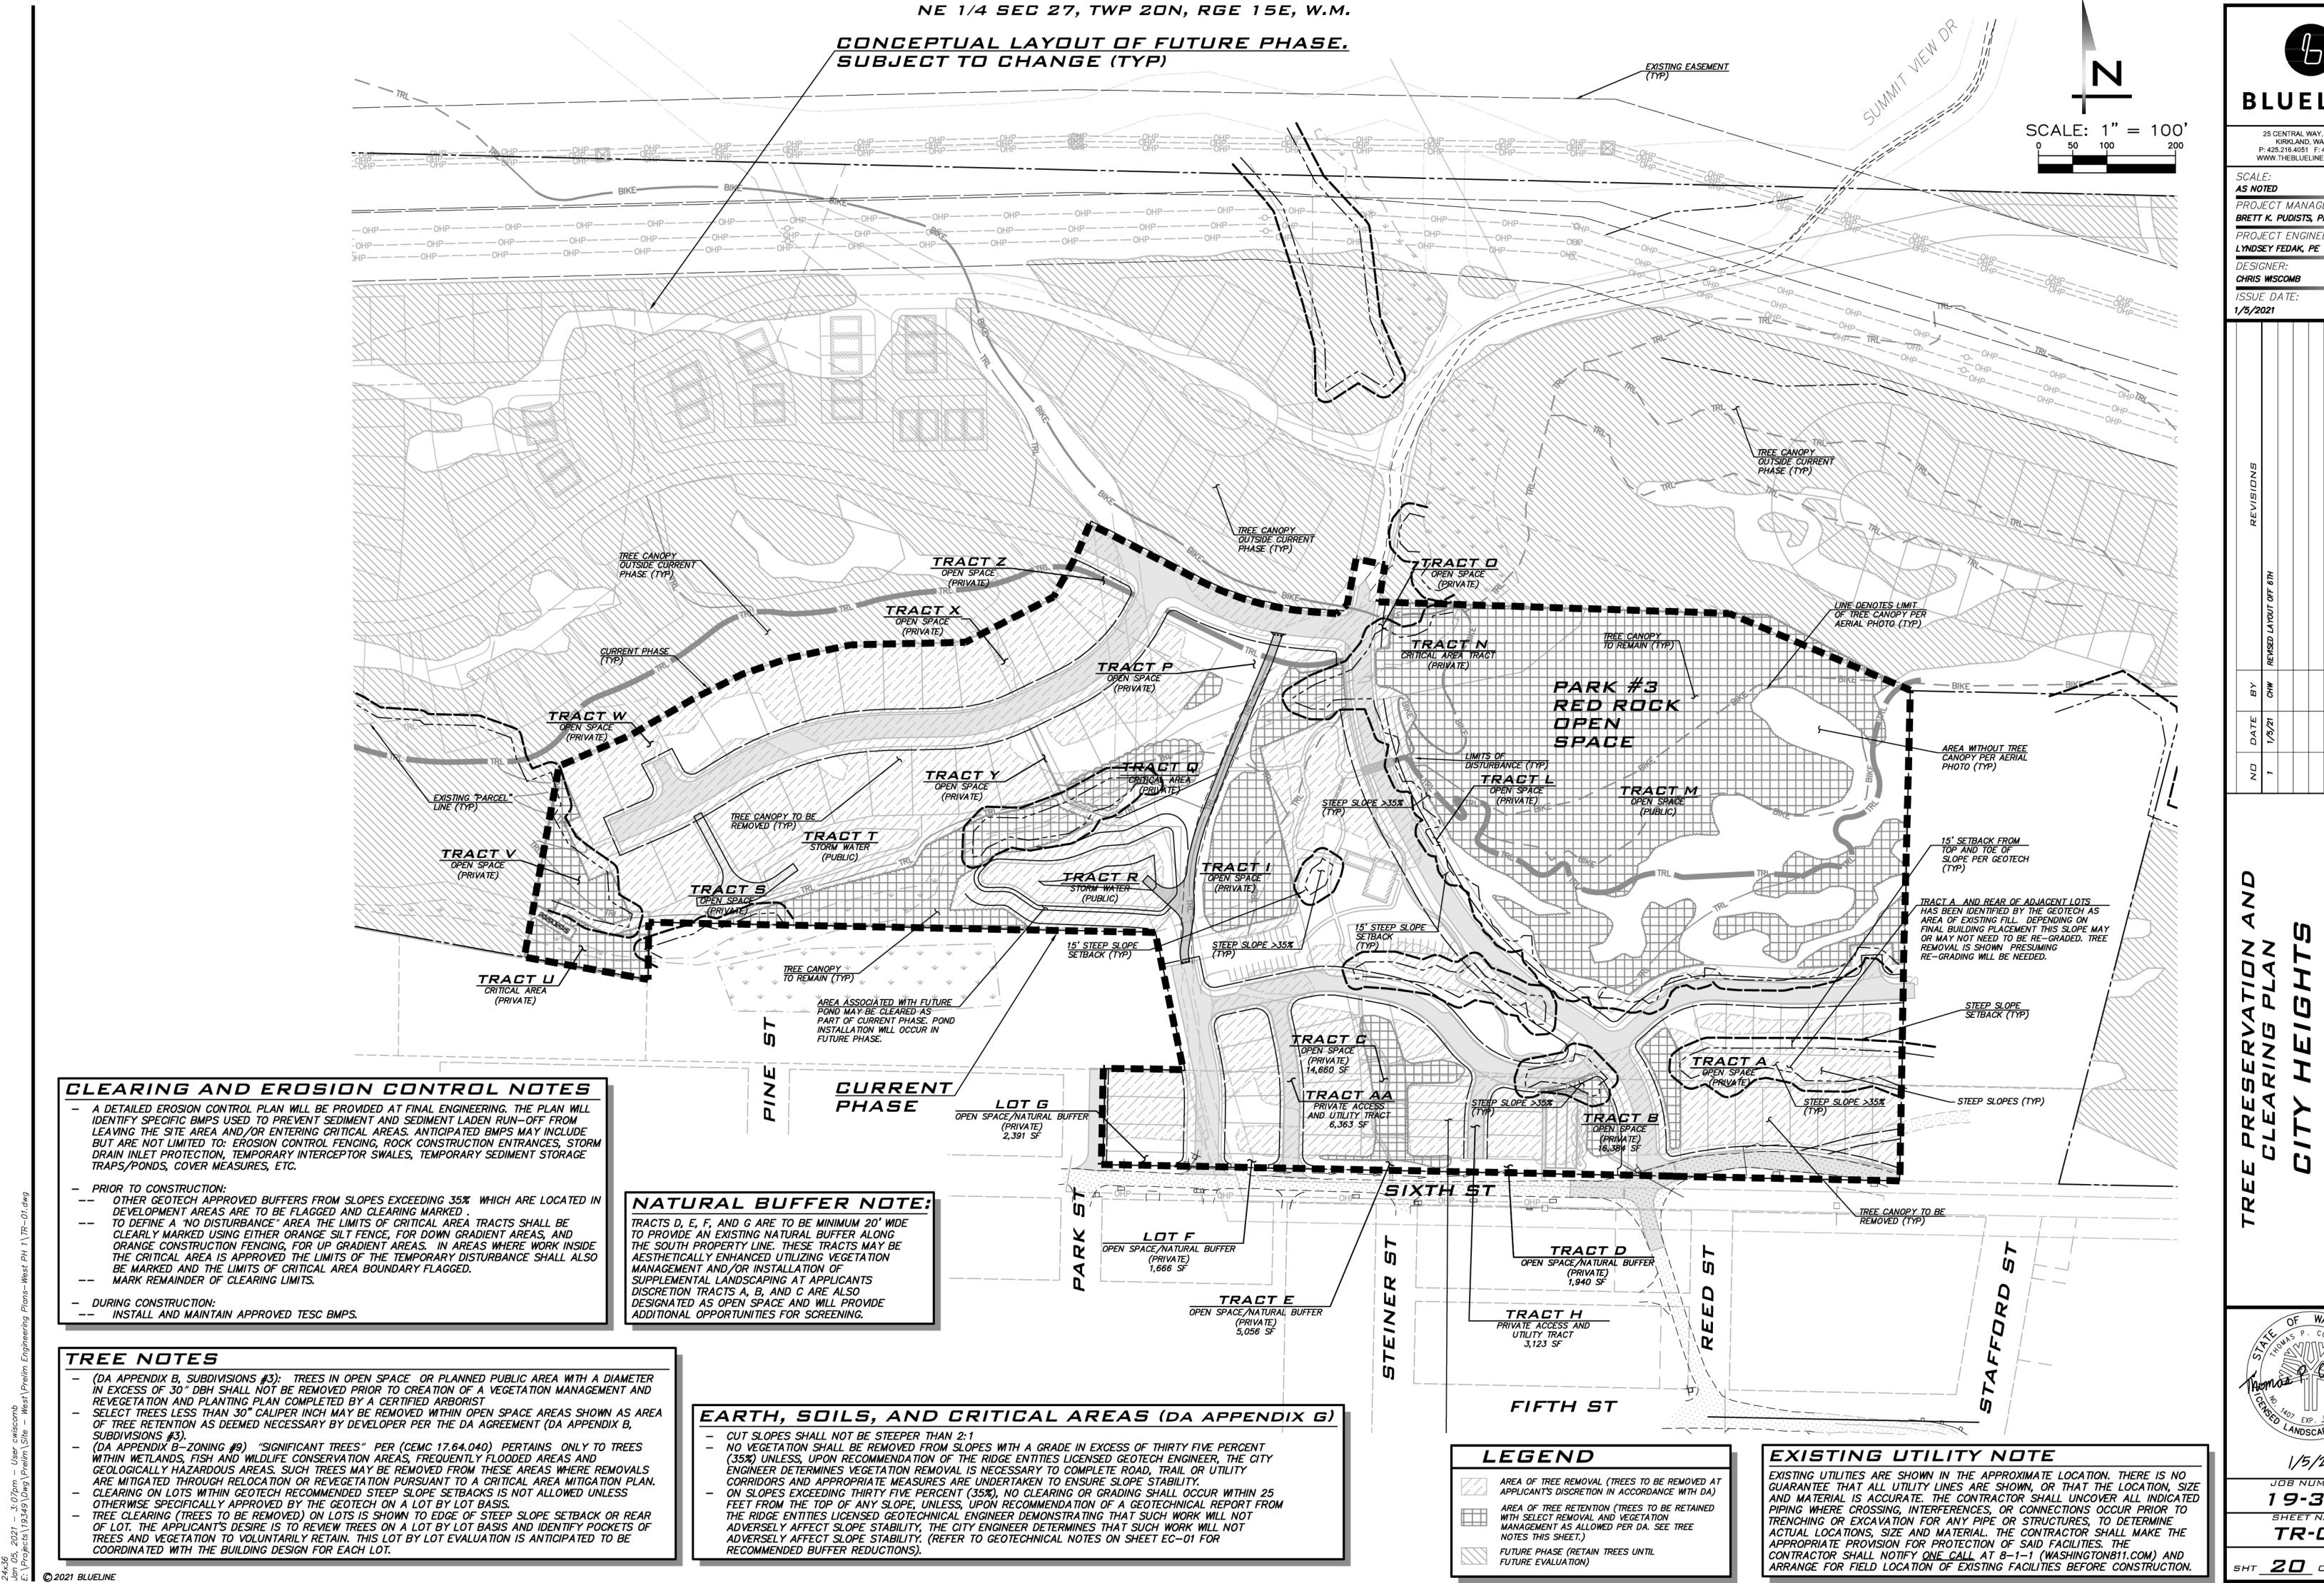

**BLUELINE** 


25 CENTRAL WAY, SUITE 400, KIRKLAND, WA 98033 P: 425.216.4051 F: 425.216.4052 WWW.THEBLUELINEGROUP.COM

AS NOTED

PROJECT MANAGER. BRETT K. PUDISTS, PE PROJECT ENGINEER:

CHRIS WISCOMB


1/5/2021

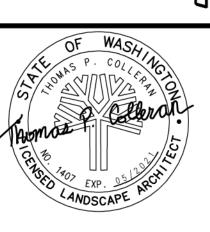

19-349 SHEET NAME:

\_20\_ of \_23

TR-0 1

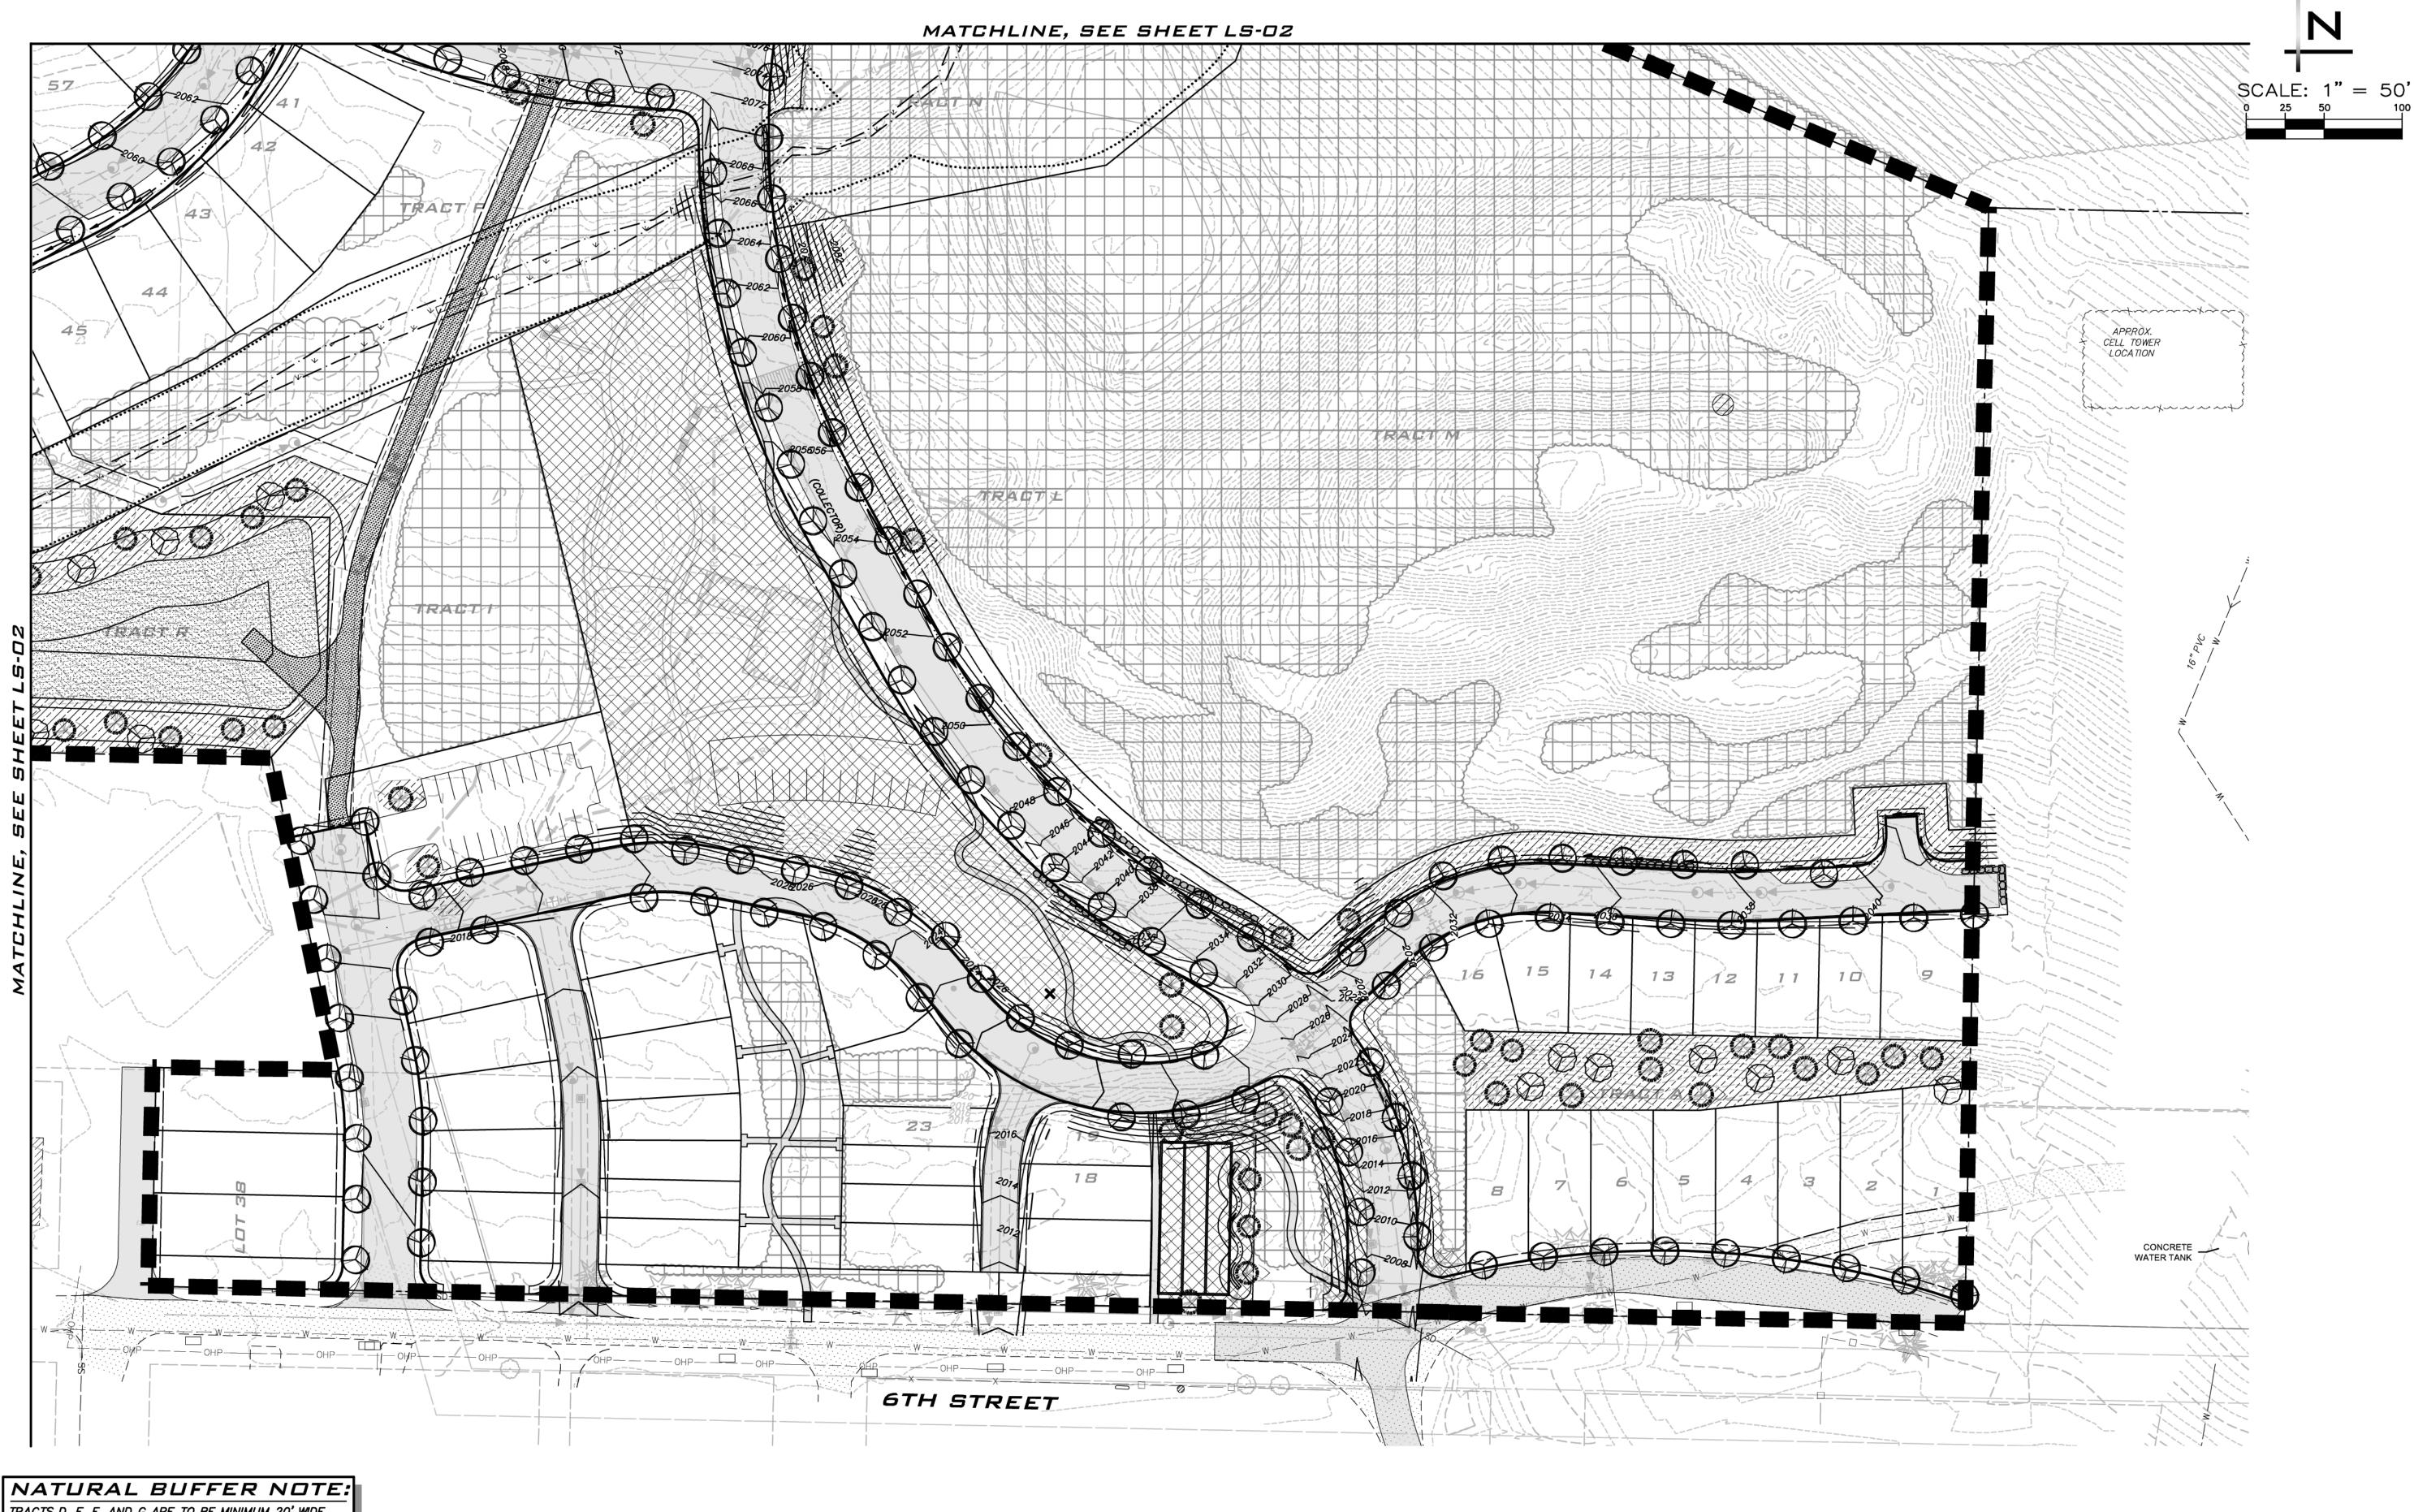

TRACTS D, E, F, AND G ARE TO BE MINIMUM 20' WIDE TO PROVIDE AN EXISTING NATURAL BUFFER ALONG THE SOUTH PROPERTY LINE. THESE TRACTS MAY BE AESTHETICALLY ENHANCED UTILIZING VEGETATION MANAGEMENT AND/OR INSTALLATION OF SUPPLEMENTAL LANDSCAPING AT APPLICANTS DISCRETION TRACTS A, B, AND C ARE ALSO DESIGNATED AS OPEN SPACE AND WILL PROVIDE DESIGNATED AS OPEN SPACE AND WILL PROVIDE ADDITIONAL OPPORTUNITIES FOR SCREENING.

## EXISTING VEGETATION

FUTURE EVALUATION)

AREA OF TREE RETENTION (TREES TO BE RETAINED WITH SELECT REMOVAL AND VEGETATION MANAGEMENT AS ALLOWED PER DA. SEE TREE NOTES ON SHEET TR-01.) FUTURE PHASE (RETAIN TREES UNTIL

LANDSCAPE TO BE
DESIGNED AS
FUTURE SUBMITTAL EVERGREEN TREES ENHANCED NATIVE LANDSCAPE/SLOPE STABILIZATION DECIDUOUS TREES ত্রেক্তরের GRASS SEED MIX STREET TREE

\* SEE LS-03 FOR CONCEPTUAL PLANT SCHEDULE\*

LEGEND

#### LANDSCAPE NOTES

INFORMATION.

- REFER TO DA APPENDIX B SECTION 9 FOR LANDSCAPING REQUIREMENTS. CCR'S SHALL BE ESTABLISHED THAT PROVIDE FOR REVEGETATION OF DISTURBED AREAS, PREVENTION OF NOXIOUS WEEDS, PROHIBIT HUNTING AND DISCHARGE OF FIREARMS AND REQUIRE WILDLIFE PROOF GARBAGE CANS. REFER TO DA APPENDIX H #3 FOR REQUIREMENTS.

  STREET TREE LOCATIONS ARE CONCEPTUAL AND MAY BE IMPACTED BY
- UTILITIES AND/OR ACCESS. SEE SHEET OS-01 FOR ADDITIONAL TRAILS AND OPEN SPACE

#### EXISTING UTILITY NOTE

EXISTING UTILITIES ARE SHOWN IN THE APPROXIMATE LOCATION. THERE IS NO GUARANTEE THAT ALL UTILITY LINES ARE SHOWN, OR THAT THE LOCATION, SIZE AND MATERIAL IS ACCURATE. THE CONTRACTOR SHALL UNCOVER ALL INDICATED PIPING WHERE CROSSING, INTERFERENCES, OR CONNECTIONS OCCUR PRIOR TO TRENCHING OR EXCAVATION FOR ANY PIPE OR STRUCTURES, TO DETERMINE ACTUAL LOCATIONS, SIZE AND MATERIAL. THE CONTRACTOR SHALL MAKE THE APPROPRIATE PROVISION FOR PROTECTION OF SAID FACILITIES. THE CONTRACTOR SHALL NOTIFY ONE CALL AT 8-1-1 (WASHINGTON811.COM) AND ARRANGE FOR FIELD LOCATION OF EXISTING FACILITIES BEFORE CONSTRUCTION.




25 CENTRAL WAY, SUITE 400, KIRKLAND, WA 98033 P: 425.216.4051 F: 425.216.4052 WWW.THEBLUELINEGROUP.COM

AS NOTED PROJECT MANAGER: BRETT K. PUDISTS, PE

PROJECT ENGINEER: LYNDSEY FEDAK, PE


CHRIS WISCOMB

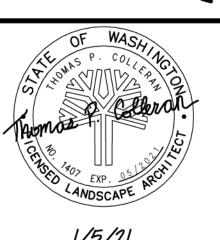

19-349

LS-01

sнт <u>21</u> ог <u>23</u>

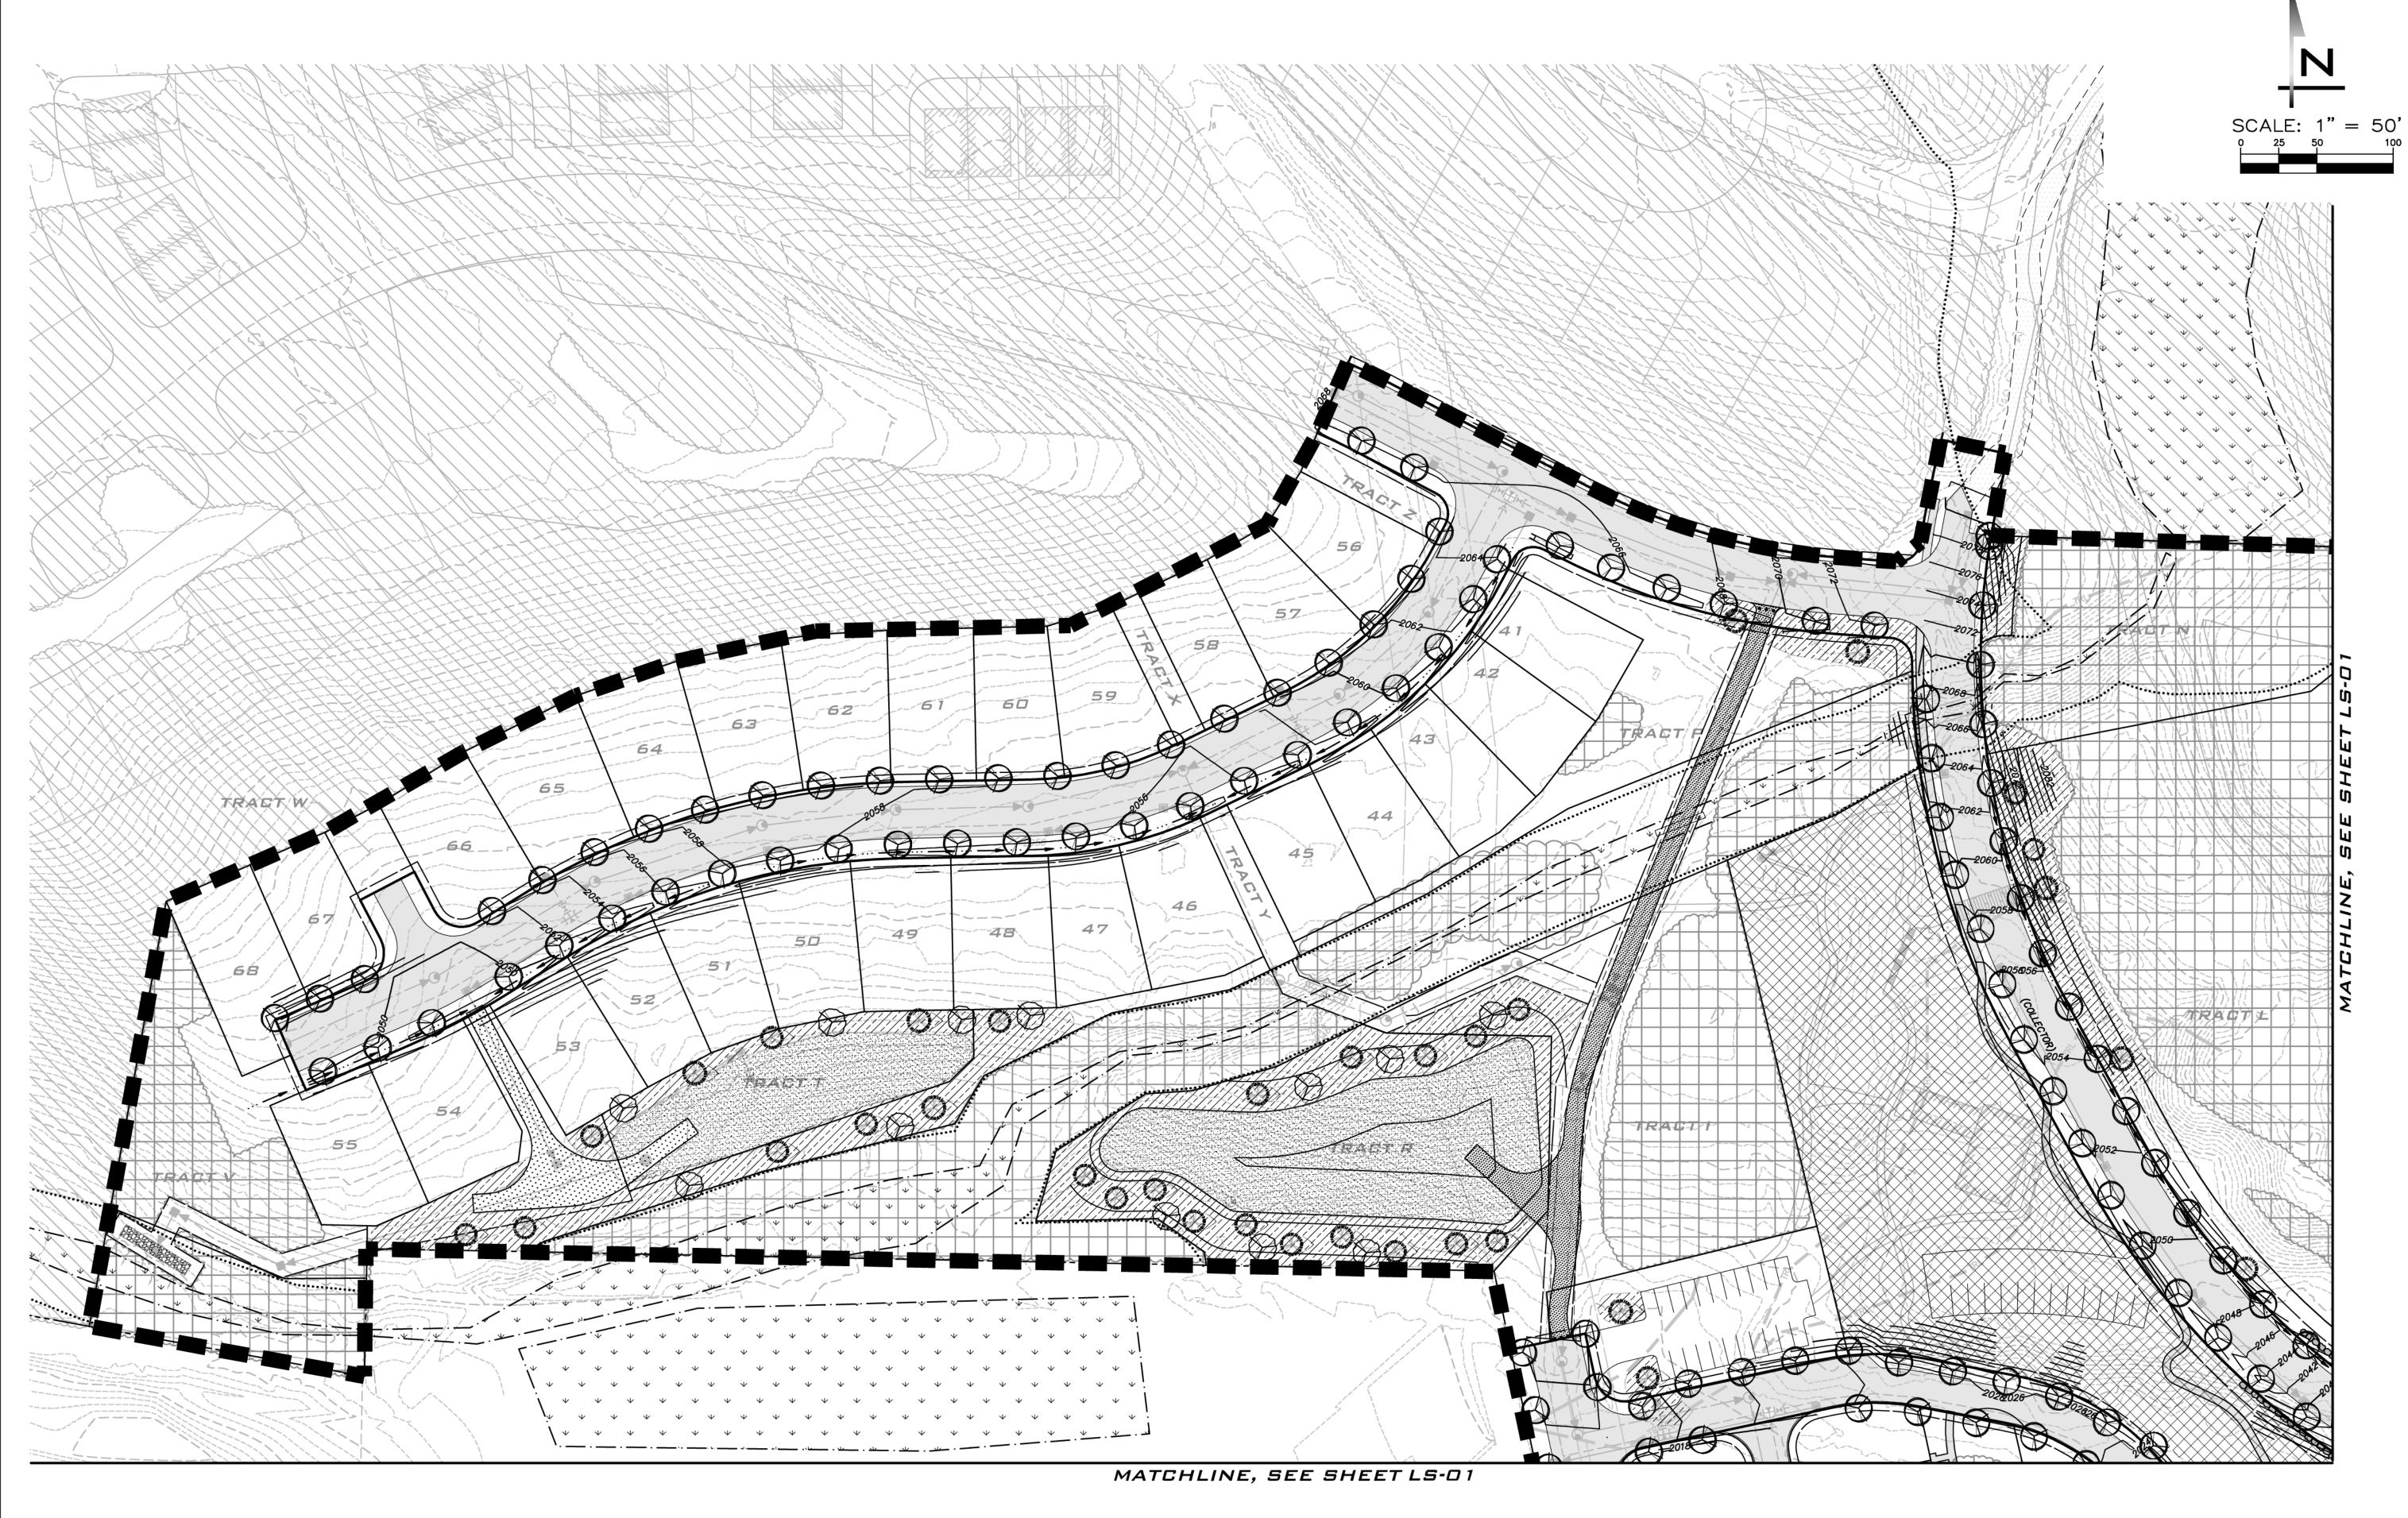


NATURAL BUFFER NOTE:

TRACTS D, E, F, AND G ARE TO BE MINIMUM 20' WIDE TO PROVIDE AN EXISTING NATURAL BUFFER ALONG THE SOUTH PROPERTY LINE. THESE TRACTS MAY BE AESTHETICALLY ENHANCED UTILIZING VEGETATION MANAGEMENT AND/OR INSTALLATION OF SUPPLEMENTAL LANDSCAPING AT APPLICANTS DISCRETION TRACTS A, B, AND C ARE ALSO DESIGNATED AS OPEN SPACE AND WILL PROVIDE ADDITIONAL OPPORTUNITIES FOR SCREENING.

# EXISTING VEGETATION

AREA OF TREE RETENTION (TREES TO BE RETAINED WITH SELECT REMOVAL AND VEGETATION MANAGEMENT AS ALLOWED PER DA. SEE TREE NOTES ON SHEET TR-01.) FUTURE PHASE (RETAIN TREES UNTIL FUTURE EVALUATION)

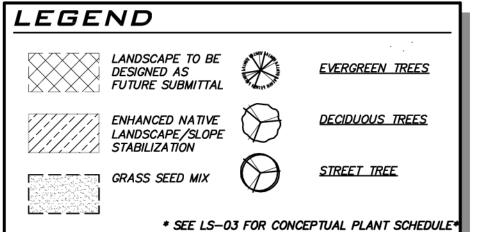

### LANDSCAPE NOTES

REFER TO DA APPENDIX B SECTION 9 FOR LANDSCAPING REQUIREMENTS.

CCR'S SHALL BE ESTABLISHED THAT PROVIDE FOR REVEGETATION OF DISTURBED AREAS, PREVENTION OF NOXIOUS WEEDS, PROHIBIT HUNTING AND DISCHARGE OF FIREARMS AND REQUIRE WILDLIFE PROOF GARBAGE CANS. REFER TO DA APPENDIX H #3 FOR REQUIREMENTS.

STREET TREE LOCATIONS ARE CONCEPTUAL AND MAY BE IMPACTED BY UTILITIES AND/OR ACCESS.

SEE SHEET OS—01 FOR ADDITIONAL TRAILS AND OPEN SPACE INFORMATION.

#### EXISTING UTILITY NOTE

EXISTING UTILITIES ARE SHOWN IN THE APPROXIMATE LOCATION. THERE IS NO GUARANTEE THAT ALL UTILITY LINES ARE SHOWN, OR THAT THE LOCATION, SIZE AND MATERIAL IS ACCURATE. THE CONTRACTOR SHALL UNCOVER ALL INDICATED PIPING WHERE CROSSING, INTERFERENCES, OR CONNECTIONS OCCUR PRIOR TO TRENCHING OR EXCAVATION FOR ANY PIPE OR STRUCTURES, TO DETERMINE ACTUAL LOCATIONS, SIZE AND MATERIAL. THE CONTRACTOR SHALL MAKE THE APPROPRIATE PROVISION FOR PROTECTION OF SAID FACILITIES. THE CONTRACTOR SHALL NOTIFY ONE CALL AT 8-1-1 (WASHINGTON811.COM) AND ARRANGE FOR FIELD LOCATION OF EXISTING FACILITIES BEFORE CONSTRUCTION.



25 CENTRAL WAY, SUITE 400, KIRKLAND, WA 98033 P: 425.216.4051 F: 425.216.4052 WWW.THEBLUELINEGROUP.COM

AS NOTED

PROJECT MANAGER: BRETT K. PUDISTS, PE

PROJECT ENGINEER: LYNDSEY FEDAK, PE

CHRIS WISCOMB

19-349 LS-02

sнт <u>22</u> ог <u>23</u>

CONCEPT PLANT SCHEDULE

EVERGREEN TREES
ABIES LASIOCARPA / SUBALPINE FIR LARIX OCCIDENTALIS / WESTERN LARCH PICEA ABIES / NORWAY SPRUCE PINUS CONTORTA VAR. LATIFOLIA / LODGEPOLE PINE PINUS PONDEROSA / PONDEROSA PINE



DECIDUOUS TREES ACER CIRCINATUM / VINE MAPLE ACER GLABRUM / ROCKY MOUNTAIN MAPLE AMELANCHIER ALNIFOLIA / SERVICEBERRY CORNUS NUTTALLII / WESTERN FLOWERING DOGWOOD POPULUS TREMULOIDES / QUAKING ASPEN SORBUS AUCUPARIA / EUROPEAN MOUNTAIN ASH



ACER RUBRUM / RED MAPLE ACER SACCHARUM / SUGAR MAPLE GLEDITSIA TRIACANTHOS F. INERMIS / THORNLESS HONEY LOCUST TILIA CORDATA / LITTLELEAF LINDEN TILIA TOMENTOSA / SILVER LINDEN ZELKOVA SERRATA / SAWLEAF ZELKOVA



SLOPE STABILIZATION PLANTING
ARCTOSTAPHYLOS UVA—URSI / KINNIKINNICK CAREX GEYERI / ELK SEDGE CORNUS SERICEA / RED TWIG DOGWOOD CORYLUS CORNUTA / WESTERN HAZELNUT FESTUCA IDAHOENSIS / IDAHO FESCUE FESTUCA RUBRA / RÉD FESCUE HOLODISCUS DISCOLOR / OCEAN-SPRAY MAHONIA AQUIFOLIUM / OREGON GRAPE MAHONIA REPENS / CREEPING MAHONIA PENSTEMON FRUTICOSUS / SHRUBBY PENSTEMON PHILADELPHUS LEWISII / WILD MOCKORANGE PHYSOCARPUS CAPITATUS / PACIFIC NINEBARK RIBES SANGUINEUM / RED FLOWERING CURRANT ROSA NUTKANA / NOOTKA ROSE SYMPHORICARPOS ALBUS / COMMON WHITE SNOWBERRY



ENHANCED NATIVE SHRUBS CARYOPTERIS CLANDONENSIS / BLUEBEARD CORNUS SERICEA / RED TWIG DOGWOOD CORYLUS CORNUTA / WESTERN HAZELNUT HAMAMELIS VERNALIS / OZARK WITCHHAZEL HOLODISCUS DISCOLOR / OCEAN—SPRAY MAHONIA AQUIFOLIUM / OREGON GRAPE PHILADELPHUS LEWISII / WILD MOCKORANGE PHYSOCARPUS CAPITATUS / PACIFIC NINEBARK POTENTILLA FRUTICOSA / BUSH CINQUEFOIL RIBES SANGUINEUM / RED FLOWERING CURRANT ROSA NUTKANA / NOOTKA ROSE SYMPHORICARPOS ALBUS / COMMON WHITE SNOWBERRY

ENHANCED NATIVE GROUNDCOVER
ARCTOSTAPHYLOS UVA—URSI / KINNIKINNICK ARMERIA MARITIMA / SEA THRIFT ASARUM CANADENSE / CANADIAN WILD GINGER CERASTIUM TOMENTOSUM / SNOW IN SUMMER CORNUS CANADENSIS / BUNCHBERRY DOGWOOD LUPINUS LATIFOLIUS / BROADLEAF LUPINE LUPINUS LAXIFLORUS / SILVERY LUPINE MAHONIA REPENS / CREEPING MAHONIA TRILLIUM OVATUM / COAST TRILLIUM



GRASS SEED MIX FESTUCA IDAHOENSIS / IDAHO FESCUE FESTUCA LONGIFOLIA / HARD FESCUE FESTUCA OVINA / SHEEP FESCUE
FESTUCA RUBRA / RED FESCUE
POA SECUNDA / CANBY BLUEGRASS

EXISTING UTILITY NOTE

EXISTING UTILITIES ARE SHOWN IN THE APPROXIMATE LOCATION. THERE IS NO GUARANTEE THAT ALL UTILITY LINES ARE SHOWN, OR THAT THE LOCATION, SIZE AND MATERIAL IS ACCURATE. THE CONTRACTOR SHALL UNCOVER ALL INDICATED PIPING WHERE CROSSING, INTERFERENCES, OR CONNECTIONS OCCUR PRIOR TO TRENCHING OR EXCAVATION FOR ANY PIPE OR STRUCTURES, TO DETERMINE ACTUAL LOCATIONS, SIZE AND MATERIAL. THE CONTRACTOR SHALL MAKE THE APPROPRIATE PROVISION FOR PROTECTION OF SAID FACILITIES. THE CONTRACTOR SHALL NOTIFY ONE CALL AT 8-1-1 (WASHINGTON811.COM) AND ARRANGE FOR FIELD LOCATION OF EXISTING FACILITIES BEFORE CONSTRUCTION.

BLUELINE

25 CENTRAL WAY, SUITE 400,

KIRKLAND, WA 98033 P: 425.216.4051 F: 425.216.4052 WWW.THEBLUELINEGROUP.COM

SCALE: AS NOTED

PROJECT MANAGER: BRETT K. PUDISTS, PE

PROJECT ENGINEER: LYNDSEY FEDAK, PE

DESIGNER:

CHRIS WISCOMB ISSUE DATE:

1/5/2021

19-349 LS-03

sнт <u>23</u> оғ <u>23</u>

