DT-01

DT-03

DT-04

DT-05

DT-06

1 OF 1

^{*}√2021 BLUELINE

YARD DRAIN

○ SEWER MANHOLE

SS PIPE FLOW

♦ SEWER STUB

A FIRE HYDRANT

⊞ WATER METER

⋈ GATE VALVE

⑤ SEPTIC LID

STORM CLEANOUT

♦ STORM DRAIN STUB

STORM CULVERT END

SEWER CLEANOUT

ASPHALT

CONCRETE

GRAVEL

₩ETLAND

≥40% SLOPE

REFER TO CONDITION 19 ON SHEET COA-1 FOR REQUIREMENTS RELATED TO ACTIVITIES WITHIN STREAMS, WETLANDS AND THEIR BUFFERS.

STREAM, WETLAND, BUFFER NOTES

1. ALLOWED DENSITY PER APPENDIX A OF DA.

2. REFER TO SHEET COA-1 FOR CONDITION OF

PODS B7 AND C.

APPROVAL #7 RELATED TO FULL DEVELOPMENT OF

DO NOT DISTURB STREAMS, WETLAND OR BUFFERS UNTIL WRITTEN AUTHORIZATION FROM THE CITY IS PROVIDED.

SEE SHEET GN-01 FOR LIST OF RELEVANT REPORTS BY SEWALL CONSULTING. INC

BUFFER RESTORATION PLAN BY SEWALL WETLAND CONSULTING, INC

BUFFER RESTORATION PLAN

STANDARD DETAILS

STANDARD DETAILS

STANDARD DETAILS

STANDARD DETAILS


STANDARD DETAILS

DETAILS

- BASE MAP INFO UNLESS OTHERWISE NOTED, BASE MAP INFO SHOWN IS PER FILES PROVIDED BY ENCOMPASS ENGINEERING AND SURVEYING.

EXISTING UTILITY NOTE

EXISTING UTILITIES ARE SHOWN IN THE APPROXIMATE LOCATION. THERE IS NO GUARANTEE THAT ALL UTILITY LINES ARE SHOWN, OR THAT THE LOCATION, SIZE AND MATERIAL IS ACCURATE. THE CONTRACTOR SHALL UNCOVER ALL INDICATED PIPING WHERE CROSSING, INTERFERENCES, OR CONNECTIONS OCCUR PRIOR TO TRENCHING OR EXCAVATION FOR ANY PIPE OR STRUCTURES, TO DETERMINE ACTUAL LOCATIONS, SIZE AND MATERIAL. THE CONTRACTOR SHALL MAKE THE APPROPRIATE PROVISION FOR PROTECTION OF SAID FACILITIES. THE CONTRACTOR SHALL NOTIFY ONE CALL AT 8-1-1 (WASHINGTON811.COM) AND ARRANGE FOR FIELD LOCATION OF EXISTING FACILITIES BEFORE CONSTRUCTION.

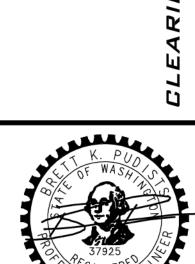

BLUELINE

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AS NOTED

PROJECT MANAGER.

Brett K. Pudists, Pe

PROJECT ENGINEER. LYNDSEY FEDAK, PE

CHRIS WISCOMB

11/15/2021

11/15/21

SHEET NAME:

_ of _**48**

JOB NUMBER: 19-349

CV-01

IN RESPONSE TO CITY COMMENT, SELECT CONDITIONS OF APPROVAL HAVE BEEN ADDED TO THESE PLANES.

- 7. THE AREAS DESIGNATED FOR DEVELOPMENT IN THE PHASE L PRELIMINARY PLAT MAP IN EXHIBIT AA TO THIS DOCUMENT SHALL CONSTITUTE THE FULL DEVELOPMENT OF DEVELOPMENT POD B—7 AND DEVELOPMENT AREA C, AND NO FURTHER PLATS OR DEVELOPMENT PLANS SHALL BE SUBMITTED FOR THESE AREAS, EXCEPT AS AUTHORIZED IN THIS DOCUMENT.
- 10. THE PHASE 1 PLAT CONSISTS OF PORTIONS OF PARCELS 493935, 95632, AND 956734. THE PRELIMINARY APPROVAL OF THE PHASE 1 PLAT DOES NOT AUTHORIZE ANY DEVELOPMENT ACTIVITIES ON THE PORTIONS OF THESE PARCELS OUTSIDE OF THE PLAT, UNLESS SPECIFICALLY AUTHORIZED IN THIS AGREEMENT.
- a. PRIOR TO FINAL APPROVAL OF THE PHASE 1 PLAT THE PROJECT SPONSOR SHALL SUBMIT FOR CITY REVIEW AND APPROVAL A BOUNDARY LINE ADJUSTMENT OR OTHER MEANS OF ESTABLISHING THE PORTIONS OF THESE PARCELS OUTSIDE OF THE PHASE 1 PLAT AS SEPARATE PARCELS OR TRACTS.

12 THE PHASE L PRELIMINARY PLAT MAY BE IMPLEMENTED IN THREE DIVISIONS AND THE APPLICATION FOR FINAL PLAT APPROVAL FOR EACH DIVISION MAY BE SUBMITTED FOR CITY REVIEW AND APPROVAL SEPARATELY, PROVIDED THAT:

- a. EACH DIVISION MUST DEMONSTRATE COMPLIANCE WITH THE CONDITIONS OF PHASE I PRELIMINARY PLAT APPROVAL.
- b. ALL REQUIRED INFRASTRUCTURE NECESSARY TO SERVE THAT DIVISION, AS DETERMINED BY THE CITY, SHALL HAVE BEEN DESIGNED AND CONSTRUCTED, AND SHALL HAVE BEEN ACCEPTED BY THE CITY, OR SUFFICIENT FINANCIAL GUARANTEES, AS DETERMINED BY THE CITY SHALL BE IN PLACE.
- c. ALL INFRASTRUCTURE IMPROVEMENTS HAVE BEEN DESIGNED AND CONSTRUCTED TO STAND ALONE AND OPERATE IN ACCORDANCE WITH APPLICABLE STANDARDS WITHOUT FURTHER IMPROVEMENTS IN SUBSEQUENT PHASES.
- d. THE CITY MAY DEFER REQUIRED DEDICATIONS UNTIL THE COMPLETION OF ALL DIVISIONS TO IMPLEMENT PHASE L HAVE BEEN COMPLETED. GIVEN THE UNCERTAINTY OF THE TIMING OF SUBSEQUENT PHASES OF DEVELOPMENT, PROPOSED DEDICATIONS MAY BE FURTHER DEFERRED UNTIL SUCH TIME THAT THE CITY DETERMINES, IN ITS SOLE DISCRETION, THAT IT CAN REASONABLY ASSUME MAINTENANCE RESPONSIBILITIES WITHOUT THE COMPLETION OF RELATED IMPROVEMENTS OR WITHOUT INTERFERENCE BY SUBSEQUENT CONSTRUCTION ACTIVITIES.

13 THE PERMITTED USES AND ALL TERMS AND CONDITIONS APPLICABLE TO PUBLIC AND PRIVATE TRACTS SHALL BE IDENTIFIED ON THE FACE OF THE FINAL PLAT, PROVIDED THAT:

- THE PROJECT SPONSOR SHALL SUBMIT A DRAFT COPY OF ALL DOCUMENTS THAT CREATE OR ASSIGN RESPONSIBILITIES TO A HOMEOWNER'S ASSOCIATION TO THE CITY ATTORNEY FOR REVIEW PRIOR TO FINAL PLAT APPROVAL, OR BY MUTUAL AGREEMENT OF THE PARTIES, PRIOR TO THE ISSUANCE OF THE FIRST CERTIFICATE OF OCCUPANCY.
- b. THE CITY MAY REQUIRE MEASURES SUCH AS COVENANTS OR OTHER LEGAL INSTRUMENTS TO ENSURE THAT THE HOMEOWNER ASSOCIATION(S) PERFORM THEIR OBLIGATIONS TO MAINTAIN PRIVATE TRACTS IN PERPETUITY.
- c. THE PROJECT SPONSOR SHALL BE RESPONSIBLE FOR MAINTAINING ALL TRACTS THAT MAY BE DEDICATED TO THE CITY OR ANOTHER PUBLIC AGENCY UNTIL SUCH TIME THAT THE DEDICATION OCCURS, AND THAT NO UNAUTHORIZED USES OCCUR, NOR ANY USE THAT MAY CAUSE DEGRADATION OF THESE AREAS.
- 22 IT IS THE INTENT OF THE PARTIES TO PREPARE AND PRESENT FOR CITY COUNCIL APPROVAL A MEMORANDUM OF UNDERSTANDING THAT ADDRESSES THE DEVELOPMENT AND
 MAINTENANCE OF PARKS AND TRAILS WITHIN THE PHASE 1 PLAT. IN THE ABSENCE OF AN APPROVED MEMORANDUM OF UNDERSTANDING THE FOLLOWING CONDITIONS 23—26 SHALL

23 PROPERTY WITHIN THE BOUNDARIES OF THE PHASE 1 PRELIMINARY PLAT TO BE INCLUDED IN THE REQUIRED RED ROCK OPEN SPACE (PARK #3) SHALL BE PLACED IN A PRIVATELY OWNED OPEN SPACE TRACT FOR FUTURE DEDICATION TO THE CITY OR OTHER PUBLIC AGENCY, PROVIDED THAT IN THE INTERIM PERIOD PRIOR TO DEDICATION:

- a. CRITICAL AREAS AND THEIR BUFFERS AND OTHER AREAS NOT SUITABLE FOR RECREATIONAL USES ARE IDENTIFIED AND PROTECTED THROUGH SIGNAGE AND THROUGH SUCH MEASURES AS THE STRATEGIC PLACEMENT OF FENCING OR PLACEMENT IN SEPARATE TRACTS SUBJECT TO CONSERVATION EASEMENTS.
- b. THE PROPERTY OWNER SHALL NOT ENCOURAGE OR PERMIT UNAUTHORIZED RECREATIONAL USES TO OCCUR WITHIN CRITICAL AREAS OR THEIR BUFFERS.
- c. THE PROJECT SPONSOR MAY UPON COMPLETION OF THE PARK IMPROVEMENTS WITHIN PARK #3, ELECT TO OPEN THE PARK TO THE PUBLIC FOR AUTHORIZED RECREATIONAL USES AND MAINTAIN THE PARK AT HIS SOLE EXPENSE, UNTIL THE DEDICATION PROCESS HAS BEEN COMPLETED.

24 THE DEDICATION OF THE RED ROCK OPEN SPACE (PARK #3) TO THE CITY OR OTHER PUBLIC AGENCY SHALL OCCUR ONLY UPON THE COMPLETION OF THE FOLLOWING:

- a. THE PROJECT SPONSOR HAS SUBMITTED PLANS, SUBJECT TO REVIEW AND AT THE CITY'S SOLE AND REASONABLE APPROVAL, OF THE ADDITIONAL LAND TO BE LEFT IN A
- NATURAL STATE SUFFICIENT TO ACHIEVE THE STANDARD OF NO NET LOSS OF AREA OR FUNCTION OF PARK #3 THE RED ROCK OPEN SPACE.
- C. A CONCEPTUAL PARK MASTER PLAN TO GUIDE THE DEVELOPMENT AND USE FOR PARK #3 IN ITS ENTIRETY IN ACCORDANCE WITH THE PROVISIONS OF APPENDIX N HAS BEEN COLLABORATIVELY PREPARED AND APPROVED BY THE PROJECT SPONSOR AND THE CITY THIS PLAN SHALL IDENTIFY NATURAL OPEN SPACE AREAS, THE NATURE AND GENERAL

ALL THE PROPERTY FOR INCLUSION IN PARK #3, AS DEPICTED ON EXHIBITS 3 AND 7 TO THE DEVELOPMENT AGREEMENT OR AS OTHERWISE APPROVED BY THE CITY, HAVE BEEN

- d. ALL REQUIRED IMPROVEMENTS TO PARK #3 IN ITS ENTIRETY HAVE BEEN CONSTRUCTED BY THE PROJECT SPONSOR AND ACCEPTED BY THE CITY.
- e. ALL PLATS NECESSARY FOR BUILD-OUT OF DEVELOPMENT AREAS B, C, AND DI -D4 HAVE RECEIVED FINAL APPROVAL FROM THE CITY.

PLACED IN OPEN SPACE TRACTS SUITABLE FÖR DEDICATION TO THE CITY OR ANOTHER PUBLIC AGENCY.

25 PROPERTY WITHIN THE BOUNDARIES OF THE PHASE 1 PRELIMINARY PLAT TO BE DEVELOPED AS TRAILS AND DEDICATED TO THE CITY SHALL BE PLACED IN A PRIVATELY OWNED OPEN SPACE TRACTS FOR FUTURE DEDICATION TO THE CITY OR OTHER PUBLIC AGENCY, PROVIDED THAT IN THE INTERIM PERIOD PRIOR TO DEDICATION:

- a. CRITICAL AREAS AND THEIR BUFFERS AND OTHER AREAS NOT SUITABLE FOR RECREATIONAL USES ARE IDENTIFIED AND PROTECTED THROUGH SIGNAGE AND THROUGH SUCH MEASURES AS THE STRATEGIC PLACEMENT OF FENCING.
- b. THE PROPERTY OWNER SHALL NOT ENCOURAGE OR PERMIT UNAUTHORIZED RECREATIONAL USES TO OCCUR WITHIN CRITICAL AREAS OR THEIR BUFFERS.
- c. THE PROJECT SPONSOR MAY, UPON COMPETITION OF THE IMPROVEMENTS TO A TRAIL(S), ELECT TO OPEN THE TRAIL(S) TO THE PUBLIC FOR AUTHORIZED RECREATIONAL USES AND MAINTAIN THE TRAIL(S) AT HIS SOLE EXPENSE, UNTIL THE DEDICATION PROCESS HAS BEEN COMPLETED.

26 THE DEDICATION OF TRAILS TO THE CITY OR OTHER PUBLIC AGENCY MAY OCCUR ONLY UPON THE COMPLETION OF THE FOLLOWING TASKS:

- a. ALL THE PROPERTY INTENDED FOR THE DEVELOPMENT OF PUBLIC TRAILS IN THE PHASE L PLAT , HAVE BEEN PLACED IN OPEN SPACE TRACTS OR EASEMENTS SUITABLE FOR DEDICATION TO THE CITY OR ANOTHER PUBLIC AGENCY.
- b. A TRAIL PLAN TO GUIDE THE DEVELOPMENT AND USE OF THESE TRAILS IN ACCORDANCE WITH THE PROVISIONS OF APPENDIX N HAS BEEN COLLABORATIVELY PREPARED AND APPROVED BY THE PROJECT SPONSOR AND THE CITY.
- c. ALL REQUIRED IMPROVEMENTS HAVE BEEN CONSTRUCTED BY THE PROJECT SPONSOR AND ACCEPTED BY THE CITY.
- d. ALL PLATS NECESSARY FOR BUILD-OUT OF DEVELOPMENT AREAS AB, C, AND D L -D4 HAVE RECEIVED FINAL APPROVAL FROM THE CITY,
- e. PARK #3 THE RED ROCK OPEN SPACE IS READY FOR DEDICATION TO THE CITY.

LOCATION OF PROPOSED IMPROVEMENTS, AND TRAIL CORRIDORS.

30B ALL AUTHORIZED CONSTRUCTION ACTIVITIES SHALL INCLUDE DOCUMENTATION FROM A GEOTECHNICAL ENGINEER THAT THE AREA IS SUITABLE FOR THE PROPOSED DEVELOPMENT AND COMPLIES WITH THE PROVISIONS OF APPENDIX F TO THE DEVELOPMENT AGREEMENT (COAL MINE HAZARDS) AND THE APPLICABLE PROVISIONS OF THE CITY HEIGHTS EIS.

- a. THE PROJECT SPONSOR SHALL PROVIDE ADDITIONAL INFORMATION IDENTIFYING THE LOCATION OF ANY KNOWN OR POTENTIAL MINE HAZARDS, MINE SHAFTS, OR ASSOCIATED FEATURES SUCH AS MINE ENTRANCES OR FOUNDATIONS. IN ADDITION, THE PROJECT SPONSOR SHALL PROVIDE DOCUMENTATION FROM A GEO—TECHNICAL ENGINEER IDENTIFYING THE PROPOSED MEASURES NECESSARY TO AVOID, REMEDIATE, OR MITIGATE SUCH HAZARDS OR FEATURES.
- b. THE LOCATION OF ANY COAL MINE HAZARDS, COAL MINE SHAFTS AND ASSOCIATED FEATURES WITHIN THE BOUNDARIES OF THE PHASE I PRELIMINARY PLAT SHALL BE IDENTIFIED ON THE FACE OF THE FINAL PHASE L PLAT ALONG WITH A REFERENCE TO RELEVANT MITIGATION MEASURES IDENTIFIED IN THE CITY HEIGHTS EIS AND RELATED TECHNICAL STUDIES FOR THE PLAT.

45 PRIOR TO THE FINAL APPROVAL OF THE PHASE 1 PLAT, PROVISIONS SHALL BE MADE FOR AT LEAST ONE RESIDENTIAL DWELLING UNIT FOR SALE OR LEASE AS LOW-INCOME HOUSING AND ONE RESIDENTIAL DWELLING UNIT FOR SALE OR LEASE AS MODERATE—INCOME HOUSING, PROVIDED THAT:

a. THE PROJECT SPONSOR MAY SUBMIT FOR CITY REVIEW AND APPROVAL A FINANCIAL GUARANTEE OR OTHER MEASURES THAT ENSURES THAT THE CONDITION OF APPROVAL

a. THE PROJECT SPONSOR MAY SUBMIT FOR CITY REVIEW AND APPROVAL A FINANCIAL GUARANTEE OR OTHER MEASURES THAT ENSURES THAT THE CONDITION OF APPROVAL REQUIRING THAT PROVISION OF AFFORDABLE HOUSING AS SET FORTH IN PARAGRAPH 6.8 OF THE DEVELOPMENT AGREEMENT WILL BE MET PRIOR TO THE EXPIRATION OR TERMINATION OF THE CITY HEIGHTS ANNEXATION AND DEVELOPMENT AGREEMENT.

48A THE FINAL PLAT MAP SHALL INCLUDE:

- a. IDENTIFICATION AND DOCUMENTATION OF REQUIRED PARKING IN ACCORDANCE WITH THE PROVISIONS OF APPENDIX B TO THE DEVELOPMENT AGREEMENT.
- b. ALL EASEMENTS TO BE RETAINED, MODIFIED, OR EXTINGUISHED, AND ALL PROPOSED EASEMENTS.
- c. THE IDENTIFICATION OF PROPOSED AREAS AND THE ASSOCIATED ACREAGE THAT MAY QUALIFY FOR CONSIDERATION AS SATISFYING THE OPEN SPACE REQUIREMENTS OF APPENDIX H TO THE DEVELOPMENT AGREEMENT, SUBJECT TO CONFIRMATION AND APPROVAL BY THE CITY:
 - OPEN SPACE,
 - . NATURAL AREAS. . PARKS. . RECREATION AREAS.
 - 5. VILLAGE GREENS. 6. COMMONS.
 - PUBLIC ASSEMBLY AREAS.

48B UPON ISSUANCE OF THE FIRST BUILDING PERMIT FOR THE FIRST ERU WITHIN CITY HEIGHTS, THE PROJECT SPONSOR SHALL PAY TO THE CLE ELUM — ROSLYN SCHOOL DISTRICT:

a. A ONE—TIME PAYMENT OF \$75,000 RELATED TO FACILITY AND EQUIPMENT IMPACTS (DEVELOPMENT AGREEMENT APPENDIX O SCHOOLS PARAGRAPH I).

- b. A ONE-TIME PAYMENT OF \$150,000 RELATED TO FACILITY AND EQUIPMENT IMPACTS (DEVELOPMENT AGREEMENT APPENDIX O SCHOOLS PARAGRAPH T).
- C. UPON THE FIRST ANNIVERSARY OF THE PRECEDING \$75,000 PAYMENT (DEVELOPMENT AGREEMENT APPENDIX O SCHOOLS 1), ANOTHER ONE—TIME PAYMENT OF \$75,000 SHALL BE MADE RELATED TO FACILITY AND EQUIPMENT IMPACTS (DEVELOPMENT AGREEMENT APPENDIX O SCHOOLS PARAGRAPH 3).

EXISTING UTILITY NOTE

EXISTING UTILITIES ARE SHOWN IN THE APPROXIMATE LOCATION. THERE IS NO GUARANTEE THAT ALL UTILITY LINES ARE SHOWN, OR THAT THE LOCATION, SIZE AND MATERIAL IS ACCURATE. THE CONTRACTOR SHALL UNCOVER ALL INDICATED PIPING WHERE CROSSING, INTERFERENCES, OR CONNECTIONS OCCUR PRIOR TO TRENCHING OR EXCAVATION FOR ANY PIPE OR STRUCTURES, TO DETERMINE ACTUAL LOCATIONS, SIZE AND MATERIAL. THE CONTRACTOR SHALL MAKE THE APPROPRIATE PROVISION FOR PROTECTION OF SAID FACILITIES. THE CONTRACTOR SHALL NOTIFY ONE CALL AT 8-1-1 (WASHINGTON811.COM) AND ARRANGE FOR FIELD LOCATION OF EXISTING FACILITIES BEFORE CONSTRUCTION.



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SCALE:

AS NOTED

PROJECT MANAGER:
BRETT K. PUDISTS, PE

PROJECT ENGINEER: LYNDSEY FEDAK, PE DESIGNER:

CHRIS WISCOMB

ISSUE DATE:
11/15/2021

S)
Zs
MENTS

28/21 CHW REVISED PER CITY COMMENT
21/21 CHW ADDED COAL MINE PARK (CLEAR & GRADE)
17/21 CHW ADDED COAL MINE PARK (REMAINING SHEETS)
28/21 CHW UPDATE PER CITY COMMENTS / REVISED IPZs
15/21 CHW REVISED PER CITY ENGR & PLANNING COMMENTS

- 0 W 4 0

7 & C)

RUCTURE PLAN

WASHINGTON

SITY HEIGHTS

K. PUD SE WASH TO SE

11/15/21

19-349 SHEET NAME: COA-01

sнт <u>1A</u> ог <u>48</u>

THE FOLLOWING CITY OF CLE ELUM (COCE) STANDARD NOTES SHALL APPLY UNLESS THEY ARE IN CONFLICT WITH PROVISIONS IN THE APPROVED DA IN WHICH CASE THE DA SHALL GOVERN. A STRIKE THROUGH HAS BEEN ADDED TO COCE NOTES THAT ARE IN CONFLICT WITH THE DA.

COCE - GENERAL REQUIREMENTS FOR STREETS

ALL NEW STREET CONSTRUCTION MUST CONFORM TO THESE DESIGN STANDARDS OF THE CITY OF CLE ELUM AND THE CLE ELUM MUNICIPAL CODE.

THE MAXIMUM LENGTH OF A CUT-DE-SAC STREET SHALL BE 600 FEET MEASURED ALONG THE STREET CENTERLINE FROM THE NEAREST STREET INTERSECTION TO THE CENTER OF THE CUL-DE-SAC.

CEMENT CONCRETE BARRIER CURB SHALL BE INSTALLED ALONG ALL NEW STREETS. ROLLED CURB MAY BE PERMITTED ALONG CERTAIN RESIDENTIAL STREETS AS DETERMINED BY THE CITY PUBLIC WORKS DIRECTOR. IF ROLLED CURB IS ALLOWED, BARRIER CURB MUST BE INSTALLED AROUND ALL NEW RADII. NEW SIDEWALKS BEHIND ROLLED CURB SHALL BE A MINIMUM OF 6 INCHES THICK.

sidewalks shall be constructed on both sides of all new streets. If the developer believes there are SPECIAL CIRCUMSTANCES WHEREBY THE CONSTRUCTION OF SIDEWALK ON ONE SIDE SHOULD BE DEFERRED, HE MAY MAKE WRITTEN REQUEST TO THE CITY PUBLIC WORKS DIRECTOR.

NEW STREET LIGHTING SHALL BE DESIGNED TO PROVIDE REQUIRED LEVELS OF LIGHTING BASED UPON STREET CLASSIFICATION AND LOCATION AS DETERMINED BY THE CITY OF CLE ELUM. AT A MINIMUM, A STREET LIGHT SHALL BE INSTALLED AT EACH STREET INTERSECTION, AT MID BLOCK, NO MORE THAN THREE HUNDRED (300) FEET APART, AND AT ENDS OF CUT-DE-SACS. STREET LIGHTS SHALL MEET THE DESIGN AND PLACEMENT REQUIREMENTS OF THESE STANDARDS AND THE CITY PUBLIC WORKS DIRECTOR. ALL ELECTRICAL PANELS WILL BE DESIGNED TO CITY OF CLE ELUM STANDARDS.

COCE - GENERAL REQUIREMENTS FOR STORM DRAINAGE IMPROVEMENTS

ALL CITY OF CLE ELUM STORM SEWER IMPROVEMENTS SHALL CONFORM TO THE FOLLOWING DESIGN STANDARDS OF

STORM RUNOFF OCCURRING ON ALL NEW LOTS AND DEVELOPMENTS (PRIVATE PROPERTY) SHALL BE RETAINED AND DISPOSED OF ON SITE. NO STORM RUNOFF WILL BE ALLOWED TO ENTER PUBLIC PROPERTY OR PUBLIC STORM

STORM RUNOFF FOR NEW PUBLIC STREETS SHALL BE DESIGNED AND CONSTRUCTED AS REQUIRED TO THE POINT WHERE THE ADJOINING PROPERTY OWNER'S RESPONSIBILITY FOR FURTHER EXTENSION BEGINS. THIS TYPICALLY REQUIRES AN EXTENSION ACROSS THE ENTIRE FRONTAGE OF THE PROPERTY TO THE PROPERTY LINE OF THE ADJOINING OWNER.

ALL STORM SEWER DESIGNS FOR NEW PUBLIC STREETS SHALL BE BASED UPON AN ENGINEERING ANALYSIS WHICH TAKES INTO ACCOUNT TOTAL DRAINAGE AREAS, RUNOFF RATES, PIPE AND INLET CAPACITIES, AND ANY OTHER FACTORS PERTINENT TO THE DESIGN

ALL NEW STORM DRAINAGE FACILITIES, PUBLIC OR PRIVATE, SHALL BE DESIGNED BY A PROFESSIONAL ENGINEER LICENSED IN THE STATE OF WASHINGTON. COMPLETE STORM WATER RUNOFF AND DRAINAGE FACILITIES SIZING CALCULATIONS SHALL BE SUBMITTED TO THE CITY OF CLE ELUM FOR REVIEW AND COMMENT.

STORM SEWER FACILITIES AND PIPELINES SHALL BE DESIGNED TO MEET A MINIMUM 10 YEAR STORM CRITERIA SMALL PRIVATE DEVELOPMENTS MAY BE DESIGNED TO ACCOMMODATE 1-INCH OF PRECIPITATION OVER THE ON-SITE IMPERVIOUS SURFACES. SMALL DEVELOPMENTS ARE DEFINED TO BE 20,000 SF OR LESS OF IMPERVIOUS SURFACE AREA. IMPERVIOUS SURFACES MUST BE CLEARLY NOTED AND SHOWN ON THE PROJECT SITE PLAN.

ALL STORM WATER FACILITIES SHALL HAVE OIL AND SILT SEPARATION.

THE WASHINGTON STATE DEPARTMENT OF ECOLOGY AS FOLLOWS:

*SEE DA FOR 100 YEAR

INLET SPACING SHALL BE DESIGNED IN ACCORDANCE WITH THE WSDOT HYDRAULICS MANUAL, CHAPTER 5. GENERALLY, INLET SPACING SHALL NOT EXCEED 300 FEET. THERE SHALL BE INSTALLED A MANHOLE OR TYPE II CATCH BASIN AT THE INTERSECTION OF TWO COLLECTOR STORM SEWERS. A COLLECTOR STORM SEWER IS A SEWER SERVICING MORE THAN ONE CATCH BASIN.

COCE - GENERAL REQUIREMENTS FOR SANITARY SEWER MAINS

ALL EXTENSIONS TO THE SEWER SYSTEM SHALL CONFORM TO THE DESIGN STANDARDS OF THE CITY OF CLE ELUM AND

ALL NEW LOTS AND DEVELOPMENTS SHALL BE SERVED BY A PUBLIC SANITARY SEWER LINE ADJACENT TO THE LOT

SEWER LINES SHALL BE EXTENDED BY THE OWNER OR DEVELOPER TO THE POINT WHERE THE ADJOINING PROPERTY OWNER'S RESPONSIBILITY FOR FURTHER EXTENSION BEGINS. THIS TYPICALLY REQUIRES AN EXTENSION ACROSS THE ENTIRE FRONTAGE OF THE PROPERTY TO THE PROPERTY LINE OF THE ADJOINING OWNER. IN SOME CASES, IT WILL REQUIRE DEDICATION OF AN EASEMENT AND A LINE EXTENSION ACROSS THE PROPERTY OR EXTENSION ACROSS TWO OR MORE SIDE OF THE DEVELOPING PROPERTY. EXTENSIONS WILL BE CONSISTENT WITH AND IMPLEMENT THE CITY'S ADOPTED SEWER COMPREHENSIVE PLAN.

SEWER LINES SHALL BE LOCATED IN STREETS TO SERVE ABUTTING PROPERTIES. WHEN NECESSARY, SEWER LINES MAY BE LOCATED WITHIN PUBLIC EASEMENTS. LINES LOCATED IN STREETS WILL BE OFFSET FROM THE STREET CENTERLINE AND NOT LOCATED WITHIN A VEHICLE WHEEL PATH. SEWER LINES LOCATED IN EASEMENTS SHALL GENERALLY BE LOCATED IN THE CENTER OF THE EASEMENT, BUT MAY, WITH THE APPROVAL OF THE DIRECTOR OF PUBLIC WORKS, BE OFFSET TO ACCOMMODATE THE INSTALLATION OF OTHER UTILITIES OR TO SATISFY SPECIAL

THE MINIMUM SIZE FOR PUBLIC SEWER MAINS IS EIGHT (8) INCHES IN DIAMETER. THE DEVELOPER'S SEWER SYSTEM MUST PROVIDE CAPACITY FOR THE PROPOSED DEVELOPMENT, BUT MUST ALSO PROVIDE CAPACITY FOR FUTURE

SEWER LINES SHALL BE TERMINATED WITH A MANHOLE. IN SPECIAL CIRCUMSTANCES, A FLUSH-END (CLEAN-OUT) MAY BE INSTALLED ON THE END OF A SEWER MAIN EXTENSION, PROVIDED THE END IS NO FURTHER THAN 150 FEET FROM THE LAST MANHOLE AND THE SEWER MAIN LINE AND GRADE WILL PERMIT FURTHER EXTENSION.

MANHOLES SHALL BE INSTALLED AT INTERVALS OF NO GREATER THAN 400 FEET AND AT ALL VERTICAL AND HORIZONTAL ANGLE POINTS IN THE SEWER MAIN.

EACH BUILDING CONTAINING SANITARY SEWER FACILITIES SHALL BE SERVED BY A SEPARATE PRIVATE SIDE SEWER LINE. BRANCHED SIDE SEWERS SERVING MULTIPLE BUILDINGS AND PROPERTIES SHALL NOT BE PERMITTED. SIDE SEWERS SERVING MULTI-UNIT BUILDINGS ARE PERMITTED.

SIDE SEWERS SHALL BE INSTALLED IN ACCORDANCE WITH THE UNIFORM PLUMBING CODE (UPC) AND SUBJECT TO REVIEW AND APPROVAL BY THE CITY OF CLE ELUM BUILDING INSPECTOR. WATER AND SEWER LINES SHALL NOT BE LAID IN THE SAME TRENCH, EXCEPT AS PROVIDED IN SECTION 1008 OF THE UPC AND WITH WRITTEN APPROVAL OF THE CITY OF CLE ELUM BUILDING INSPECTOR.

SEWER LINES SHALL BE DESIGNED FOR GRAVITY FLOW OPERATION. LIFT STATIONS AND FORCE MAINS SHALL BE LIMITED TO THOSE LOCATIONS AND CIRCUMSTANCES WHERE THEY ARE CONSISTENT WITH THE COMPREHENSIVE SEWER PLAN AND ARE THE ONLY VIABLE SOLUTION TO SERVE THE PROPOSED DEVELOPMENT AND OTHER PROPERTIES IN THE VICINITY. LIFT STATIONS AND FORCE MAINS SHALL BE DESIGNED BY A PROFESSIONAL ENGINEER LICENSED IN THE STATE OF WASHINGTON.

THE DESIGN OF SEWER MAINS AND APPURTENANCES IS SUBJECT TO REVIEW AND APPROVAL BY THE CITY OF CLE ELUM DIRECTOR OF PUBLIC WORKS. THE DIRECTOR OF PUBLIC WORKS MAY, AT HIS DISCRETION, ADJUST THESE STANDARDS AS NECESSARY TO FACILITATE INSTALLATION OF SEWER LINES AND APPURTENANCES FOR THE HEALTH, SAFETY, AND PROTECTION OF THE GENERAL PUBLIC.

COCE - GENERAL REQUIREMENTS FOR WATER MAINS

ALL EXTENSIONS TO THE CITY OF CLE ELUM'S DOMESTIC WATER SYSTEM SHALL CONFORM TO THE DESIGN STANDARDS OF THE CITY OF CLE ELUM AND THE STATE DEPARTMENT OF HEALTH AS FOLLOWS:

ALL NEW LOTS AND DEVELOPMENTS SHALL BE SERVED BY A PUBLIC WATER SUPPLY LINE MAINTAINED BY THE CITY OF CLE ELUM AND LOCATED ADJACENT TO THE LOT OR DEVELOPMENT SITE. THE WATER SUPPLY LINE SHALL BE CAPABLE OF PROVIDING SUFFICIENT FLOW AND PRESSURE TO SATISFY THE FIRE FLOW AND DOMESTIC SERVICE REQUIREMENTS OF THE PROPOSED LOTS AND DEVELOPMENT REQUIREMENTS.

WATER LINES SHALL BE EXTENDED BY THE OWNER OR DEVELOPER TO THE POINT WHERE THE ADJOINING PROPERTY OWNER'S RESPONSIBILITY FOR FURTHER EXTENSION BEGINS. THIS TYPICALLY REQUIRES AN EXTENSION ACROSS THE ENTIRE FRONTAGE OF THE PROPERTY TO THE PROPERTY LINE OF THE ADJOINING OWNER. IN SOME CASES, IT WILL REQUIRE DEDICATION OF AN EASEMENT AND A LINE EXTENSION ACROSS THE PROPERTY OR EXTENSION ACROSS TWO OR MORE SIDES OF THE DEVELOPING PROPERTY. EXTENSIONS WILL BE CONSISTENT WITH AND IMPLEMENT THE CITY'S ADOPTED WATER COMPREHENSIVE PLAN.

ALL NEW PUBLIC DOMESTIC WATER MAINS SHALL BE A MINIMUM DIAMETER OF 8-INCH. FIRE HYDRANT RUNS LESS THAN 50 FEET FROM THE WATER MAIN TO THE FIRE HYDRANT SHALL BE A MINIMUM OF 6—INCH.

LARGER PUBLIC WATER MAINS MAY BE REQUIRED DEPENDING UPON FIRE FLOW REQUIREMENTS AS DETERMINED BY THE CITY FIRE CHIEF AND CITY BUILDING OFFICIAL.

WATER MAIN OVERSIZING, ABOVE THAT REQUIRED FOR THE PARTICULAR DEVELOPMENT BEING SUBMITTED, MAY BE REQUIRED BY THE CITY OF CLE ELUM TO BE INSTALLED FOR FUTURE EXTENSION. THE COST OF THE MATERIALS ONLY FOR THE OVERSIZING SHALL BE REIMBURSED TO THE DEVELOPER BY THE CITY. THE DEVELOPER SHALL SUBMIT ACTUAL MATERIAL INVOICES SHOWING THE ACTUAL COST OF THE MATERIALS FURNISHED AND THE COST OF THE SAME MATERIALS OF THE SIZE REQUIRED FOR THE DEVELOPMENT.

THE DEVELOPER SHALL BE RESPONSIBLE FOR PRESSURE REDUCING VALVE STATIONS IN AREAS OF EXCESSIVE

EIGHT-INCH DEAD-END WATER MAIN OVER 1,500 FEET IN LENGTH WILL ONLY BE ALLOWED WHERE FUTURE LOOPING VIA PUBLIC RIGHT OF WAY CAN BE ASSURED. DEAD-END MAINS EXCEEDING 1,500 FEET IN LENGTH WILL BE AT LEAST 10—INCH DIAMETER PIPE WHERE LOOPING IS NOT PRACTICAL OR IS UNLIKELY TO OCCUR IN THE

MAXIMUM VALVE SPACING IN PUBLIC WATER MAINS WILL BE 1,200 LINEAR FEET. VALVES WILL BE FURNISHED AND INSTALLED ON ALL LEGS OF NEW WATER MAIN INTERSECTIONS.

ALL NEW WATER METERS SHALL BE A MINIMUM OF 3/4-INCH AND SHALL BE FURNISHED AND INSTALLED BY THE CITY OF CLE ELUM. IF MORE THAN 10 METERS ARE REQUIRED, THEY SHALL BE FURNISHED AND INSTALLED BY THE DEVELOPER TO CITY OF CLE ELUM STANDARDS.

ONLY ONE METER SHALL BE SERVED FROM EACH MAIN TAP.

MINIMUM TWO—INCH AIR AND VACUUM RELEASE VALVES SHALL BE FURNISHED AND INSTALLED AT HIGH POINTS IN

FIRE HYDRANTS SHALL BE SPACED NO GREATER THAN EVERY 300 FEET. ADDITIONAL HYDRANTS MAY BE REQUIRED TO PROTECT STRUCTURES AS DETERMINED BY THE CITY FIRE CHIEF. ADDITIONAL FIRE HYDRANTS REQUIRED ON A SITE MAY REQUIRE A LOOPED, ON-SITE FIRE HYDRANT MAIN. EASEMENTS WILL BE PROVIDED FOR ALL ON-SITE, PUBLIC, LOOPED WATER MAINS.

ALL IRRIGATION SERVICES SHALL BE INSTALLED WITH A STATE APPROVED, DOUBLE CHECK VALVE ASSEMBLY. WATER AND SEWER MAINS SHALL BE SEPARATED IN ACCORDANCE WITH SECTION C1-9.1 OF THE LATEST EDITION OF THE CRITERIA FOR SEWAGE WORKS DESIGN BY THE WASHINGTON STATE DEPARTMENT OF ECOLOGY.

THE DESIGN OF WATER MAINS AND APPURTENANCES IS SUBJECT TO REVIEW AND APPROVAL BY THE CITY OF CLE ELUM DIRECTOR OF PUBLIC WORKS. THE DIRECTOR OF PUBLIC WORKS MAY, AT HIS DISCRETION, ADJUST THESE STANDARDS AS NECESSARY TO FACILITATE INSTALLATION OF WATER LINES AND APPURTENANCES FOR THE HEALTH, SAFETY, AND PROTECTION OF THE GENERAL PUBLIC.

ALL DOUBLE DETECTOR CHECK VALVE ASSEMBLIES SHALL CONFORM TO CITY OF CLE ELUM STANDARDS. INITIAL AND ANNUAL TESTING WILL BE REQUIRED.

STORM DRAIN OWNERSHIP

- THE MAIN STORMWATER COLLECTION AND CONVEYANCE SYSTEM ADDRESSING RUNOFF FROM THE PROPOSED LOTS, TRACTS AND ROADWAYS WITHIN CITY HEIGHTS AND RUNOFF FROM UPSTREAM AREAS SHALL BE A PUBLIC SYSTEM (OWNED AND MAINTAINED BY CITY).

– THE APPLICANT HAS AGREED TO OWN AND MAINTAIN THE FOLLOWING ITEMS IN PHASE 1 PROVIDED A DECLARATION OF COVENANT FOR INSPECTION AND MAINTENANCE OF STORMWATER FACILITIES IS PROVIDED TO THE CITY AT FINAL PLAT. STORM DRAIN CONVEYANCE SYSTEMS LOCATED IN PRIVATE ROADS AND PRIVATE ALLEYS

PROVIDED A DOWN-TURNED ELBOW OR OTHER ACCEPTED FLOATABLES SEPARATOR IS PROVIDED AT THE LAST CB IN THE PRIVATE SYSTEM DISCHARGES FLOW TO THE PUBLIC SYSTEM. DETENTION AND WATER QUALITY FACILITIES DEPICTED ON THESE PHASE 1 PLANS.

SEWALL WETLAND CONSULTING REPORTS

CITY HEIGHTS WETLANDS AND WILDLIFE HABITAT REPORT - OCTOBER 26.2009 CITY HEIGHTS WETLANDS AND WILDLIFE REPORT ADDENDUM -NOVEMBER 3. 2010 CITY HEIGHTS PHASE 1 SUMMIT VIEW ROAD-REVISED CRITICAL AREA REPORT AND IMPROVEMENT IMPACT ANALYSIS AND BUFFER RESTORATION PLAN — SEPTEMBER 27, 2021 WADOE COMMENTS-CITY HEIGHTS SUMMIT ROAD AREA - OCTOBER 22, 2021

EN SPACE, NATURAL AREAS & PUBLIC SPACES (*125 Ac Cumulative)					
ract Name Area (Ac) Designation/Description					
1	Α	0.37	OPEN SPACE		
1	В	0.40	STORM WATER & OPEN SPACE		
1	ВВ	0.21	OPEN SPACE & UTILITY		
1	С	0.19	OPEN SPACE		
1	сс	0.40	OPEN SPACE		
1	D	0.05	OPEN SPACE/NATURAL BUFFER		
1	DD	0.38	CRITICAL AREA TRACT		
1	E	0.05	OPEN SPACE/NATURAL BUFFER		
1	F	0.05	OPEN SPACE/NATURAL BUFFER		
1	G	0.06	OPEN SPACE/NATURAL BUFFER		
1	l I	1.17	OPEN SPACE		
1	К	1.73	AMENITY AREA		
1	L	0.50	OPEN SPACE		
1	М	7.46	OPEN SPACE		
1	N	0.74	CRITICAL AREA TRACT		
1	0	0.04	OPEN SPACE		
1	Р	0.41	OPEN SPACE		
1	Q	1.41	CRITICAL AREA		
1	R	0.92	STORM WATER & OPEN SPACE		
1	S	0.42	STORM WATER & OPEN SPACE		
1	Т	0.34	STORM WATER & OPEN SPACE		
1	U	0.26	CRITICAL AREA		
1	٧	0.43	STORM WATER & OPEN SPACE		
1	W	0.05	OPEN SPACE		
1	Х	0.05	OPEN SPACE		
1	Y	0.05	OPEN SPACE		
1	Z	0.06	OPEN SPACE		
ase Total		18.19			

*Per DA Appendix B and H, 125 Acres (35% of total site acreage) to be set aside as open space, natural areas, parks, recreation areas, village greens, commons or public assembly areas or otherwise undeveloped space.

			1 '	(PRIVATE)	1,777 37 (0.04 70)	16	3,860 SF
			G	OPEN SPACE/NATURAL BUFFER	2,165 SF (0.05 AC)	17	2,850 SF
				(PRIVATE)	2,100 SF (0.00 AC)	18	2,375 SF
			н	PRIVATE ACCESS & UTILITY TRACT	3,404 SF (0.08 AC)	19	2,375 SF
			,	OPEN SPACE	50,795 SF (1.17 AC)	20	2,892 SF
				(PRIVATE)	30,793 SF (1.17 AC)	21	3,604 SF
			J	ACCESS (PRIVATE)	10,359 SF (0.24 AC)	22	4,798 SF
				AMENITY AREA		23	3,801 SF
			κ	(PRIVATE)	75,563 SF (1.73 AC)	24	3,856 SF
			L	OPEN SPACE	21,977 SF (0.50 AC)	25	4,849 SF
				(PRIVATE)	, ,	26	3,895 SF
			M**	OPEN SPACE (PRIVATE)	324,917 SF (7.46 AC)	27	3,325 SF
			<u></u>	CRITICAL AREA TRACT	70.404.05.(0.74.40)	28	3,325 SF
			N	(PRIVATE)	32,121 SF (0.74 AC)	29	3,325 SF
			o	OPEN SPACE (PRIVATE)	1,731 SF (0.04 AC)	30	3,429 SF
				<u> </u>		31	4,006 SF
			P	OPEN SPACE (PRIVATE)	17,962 SF (0.41 AC)	32	4,398 SF
AL ADEAC D	DUDUC CDACE	CC / *12E As Communications	L a	CRITICAL AREA	61,370 SF (1.41 AC)	33	4,398 SF
ract Name		ES (*125 Ac Cumulative) Designation/Description	■	(PRIVATE)	01,370 3F (1.41 AC)	34	4,428 SF
A	0.37	OPEN SPACE	R*	STORM WATER & OPEN SPACE (PRIVATE)	39,888 SF (0.92 AC)	35	5,459 SF
В	0.40	STORM WATER & OPEN SPACE		STORM WATER & OPEN SPACE		36	5,552 SF
ВВ	0.21	OPEN SPACE & UTILITY	s*	(PRIVATE)	18,217 SF (0.42 AC)	37	5,719 SF
c cc	0.19 0.40	OPEN SPACE OPEN SPACE	τ*	STORM WATER & OPEN SPACE	14,954 SF (0.34 AC)	38	5,487 SF
D	0.40	OPEN SPACE OPEN SPACE/NATURAL BUFFER	■	(PRIVATE)	14,954 SF (U.54 AC)	39	6,000 SF
DD	0.38	CRITICAL AREA TRACT	υ	CRITICAL AREA (PRIVATE)	11,425 SF (0.26 AC)	40	6,633 SF
Е	0.05	OPEN SPACE/NATURAL BUFFER	I	<u> </u>		41	5,396 SF
F	0.05	OPEN SPACE/NATURAL BUFFER	v *	STORM WATER & OPEN SPACE (PRIVATE)	18,682 SF (0.43 AC)	42	6,554 SF
G	0.06 1.17	OPEN SPACE/NATURAL BUFFER OPEN SPACE		OPEN SPACE	0.007.05.40)	43	6,226 SF
K	1.73	AMENITY AREA	W W	(PRIVATE)	2,003 SF (0.05 AC)	44	6,577 SF
L	0.50	OPEN SPACE	X	OPEN SPACE (PRIVATE)	2,000 SF (0.05 AC)	45	5,481 SF
M	7.46	OPEN SPACE	ı ⊢	OPEN SPACE		46	5,474 SF
N O	0.74 0.04	CRITICAL AREA TRACT OPEN SPACE	Y	(PRIVATE)	2,274 SF (0.05 AC)	47	6,100 SF
P	0.04	OPEN SPACE	Z	OPEN SPACE	2,814 SF (0.06 AC)	48	7,102 SF
Q	1.41	CRITICAL AREA		(PRIVATE)	2,017 dr (0.00 A0)	49	6,757 SF
R	0.92	STORM WATER & OPEN SPACE		ACT AREA: 18.65 AC	EV MODEOTION	50	5,664 SF
S	0.42	STORM WATER & OPEN SPACE	•	EASEMENT TO ALLOW FOR CIT LL BE PLACED OVER PRIVATE			
T	0.34	STORM WATER & OPEN SPACE	FAC	ILITIES. A DECLARATION OF C	OVENANT FOR	51	6,100 SF
U	0.26	CRITICAL AREA	•	PECTION AND MAINTENANCE (RM WATER FACILITIES SHALL		52	5,000 SF
V W	0.43 0.05	STORM WATER & OPEN SPACE OPEN SPACE	•	TINAL PLAT.	BE PROVIDED	53	6,154 SF
X	0.05	OPEN SPACE	** 45	REQUESTED BY CITY TRACT N	I TO INITIALLY	54	5,302 SF
Ϋ́	0.05	OPEN SPACE	•	A PRIVATE TRACT AND WILL E		55	5,638 SF
Z	0.06	OPEN SPACE	DEDI	ICATED TO THE PUBLIC AT A	FUTURE DATE.	56	6,365 SF
	18.19		•	ER TO CONDITION 23 ON SHE THER INFO.	EI CUA-I FOR	57	6,330 SF
			• · · · · ·				

TRACT	DESCRIPTION	AREA	Lo	IT #	AREA
Α	OPEN SPACE (PRIVATE)	16,218 SF (0.37 AC)		1	4,781 SF
AA	PRIVATE ACCESS	6,359 SF (0.15 AC)		2	4,366 SF
AA	& UTILITY TRACT	6,359 SF (U.15 AC)		3	4,187 SF
B *	STORM WATER & OPEN SPACE (PRIVATE)	17,211 SF (0.40 AC)		4	4,069 SF
	OPEN SPACE & UTILITY			5	3,898 SF
BB	(PRIVATE)	9,904 SF (0.23 AC)		6	3,936 SF
С	OPEN SPACE (PRIVATE)	8,202 SF (0.19 AC)		7	3,788 SF
	OPEN SPACE			8	3,645 SF
CC	(PUBLIC)	17,403 SF (0.40 AC)	-	9	3,401 SF
D	OPEN SPACE/NATURAL BUFFER	2,140 SF (0.05 AC)	\vdash	10	3,172 SF
	(PRIVATE)		\vdash	11 12	3,224 SF 3,269 SF
DD	CRITICAL AREA TRACT (PRIVATE)	16,403 SF (0.38 AC)	-	13	2,964 SF
	OPEN SPACE/NATURAL BUFFER	2,140 SF (0.05 AC)	-	14	3,325 SF
Ε	(PRIVATE)	2,140 SF (0.05 AC)		15	3,325 SF
F	OPEN SPACE/NATURAL BUFFER (PRIVATE)	1,777 SF (0.04 AC)		16	3,860 SF
	OPEN SPACE/NATURAL BUFFER			17	2,850 SF
G	(PRIVATE)	2,165 SF (0.05 AC)	-	<u>.</u> 18	2,375 SF
н	PRIVATE ACCESS	3,404 SF (0.08 AC)	-	19	2,375 SF
	& UTILITY TRACT OPEN SPACE	, ,		20	2,892 SF
1	(PRIVATE)	50,795 SF (1.17 AC)		21	3,604 SF
J	ACCESS	10,359 SF (0.24 AC)		22	4,798 SF
	(PRIVATE)	(0.211.0)		23	3,801 SF
K	AMENITY AREA (PRIVATE)	75,563 SF (1.73 AC)		24	3,856 SF
,	OPEN SPACE	21 077 55 (0.50 40)		25	4,849 SF
L	(PRIVATE)	21,977 SF (0.50 AC)		26	3,895 SF
M **	OPEN SPACE (PRIVATE)	324,917 SF (7.46 AC)		27	3,325 SF
	CRITICAL AREA TRACT			28	3,325 SF
N	(PRIVATE)	32,121 SF (0.74 AC)		29	3,325 SF
0	OPEN SPACE (PRIVATE)	1,731 SF (0.04 AC)		<i>30</i>	3,429 SF
	OPEN SPACE			31	4,006 SF
P	(PRIVATE)	17,962 SF (0.41 AC)		<i>32</i>	4,398 SF
Q	CRITICAL AREA	61,370 SF (1.41 AC)		<i>33</i>	4,398 SF
	(PRIVATE)	01,070 GF (1.47 NO)		34	4,428 SF
R*	STORM WATER & OPEN SPACE (PRIVATE)	39,888 SF (0.92 AC)		<i>3</i> 5	5,459 SF
s*	STORM WATER & OPEN SPACE	40.047.05 (0.40.40)		36	5,552 SF
<u> </u>	(PRIVATE)	18,217 SF (0.42 AC)		37	5,719 SF
<i>t</i> *	STORM WATER & OPEN SPACE (PRIVATE)	14,954 SF (0.34 AC)		38	5,487 SF
	CRITICAL AREA	_		39	6,000 SF
U	(PRIVATE)	11,425 SF (0.26 AC)	-	40	6,633 SF
v *	STORM WATER & OPEN SPACE (PRIVATE)	18,682 SF (0.43 AC)	-	41	5,396 SF
	OPEN SPACE	,	-	42	6,554 SF
W	(PRIVATE)	2,003 SF (0.05 AC)	\vdash	43	6,226 SF
х	OPEN SPACE	2,000 SF (0.05 AC)		44	6,577 SF
	(PRIVATE)	2,000 07 (0.00 70)	\vdash	45	5,481 SF
Y	OPEN SPACE (PRIVATE)	2,274 SF (0.05 AC)	-	46	5,474 SF
	OPEN SPACE	0.044.05.40.40.40.	-	47	6,100 SF
Z	(PRIVATE)	2,814 SF (0.06 AC)		48	7,102 SF
	T AREA: 18.65 AC	TV (1/00=50=5)		49 50	6,757 SF
	ASEMENT TO ALLOW FOR CIT L BE PLACED OVER PRIVATE		-	50	5,664 SF
	FACILITIES. A DECLARATION OF COVENANT FOR				

TRACT TABLE

DESCRIPTION

LOT AREAS

BLUELINE

25 CENTRAL WAY, SUITE 400.

KIRKLAND, WA 98033

P: 425.216.4051 F: 425.216.4052

WWW.THEBLUELINEGROUP.COM

PROJECT MANAGER.

Brett K. Pudists, Pe

PROJECT ENGINEER.

- 0 W 4 0

E E

LYNDSEY FEDAK, PE

AS NOTED

DESIGNER:

11/15/2021

CHRIS WISCOMB

PROPOSED ROW AREAS THERE ARE 3.67 ACRES OF AREA ASSOCIATED WITH ROADS / ROW PROPOSED FOR DEDICATION.

AREA SUMI	MARY -
PHASE 1	
LOT AREA	6.78 AC
TRACT AREA	18.65 AC
ROW AREA	3.67 AC
TOTAL AREA	29.1 AC

62

60

TOTAL LOT AREA: 6.78 AC

6,736 SF 5,602 SF 6,872 SF

6,330 SF

7,371 SF

EXISTING UTILITY NOTE


EXISTING UTILITIES ARE SHOWN IN THE APPROXIMATE LOCATION. THERE IS NO GUARANTEE THAT ALL UTILITY LINES ARE SHOWN, OR THAT THE LOCATION, SIZE AND MATERIAL IS ACCURATE. THE CONTRACTOR SHALL UNCOVER ALL INDICATED PIPING WHERE CROSSING, INTERFERENCES, OR CONNECTIONS OCCUR PRIOR TO TRENCHING OR EXCAVATION FOR ANY PIPE OR STRUCTURES, TO DETERMINE ACTUAL LOCATIONS, SIZE AND MATERIAL. THE CONTRACTOR SHALL MAKE THE APPROPRIATE PROVISION FOR PROTECTION OF SAID FACILITIES. THE CONTRACTOR SHALL NOTIFY ONE CALL AT 8-1-1 (WASHINGTON811.COM) AND ARRANGE FOR FIELD LOCATION OF EXISTING FACILITIES BEFORE CONSTRUCTION.


19-349 SHEET NAME: GN-01

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11/15/21

of **48**



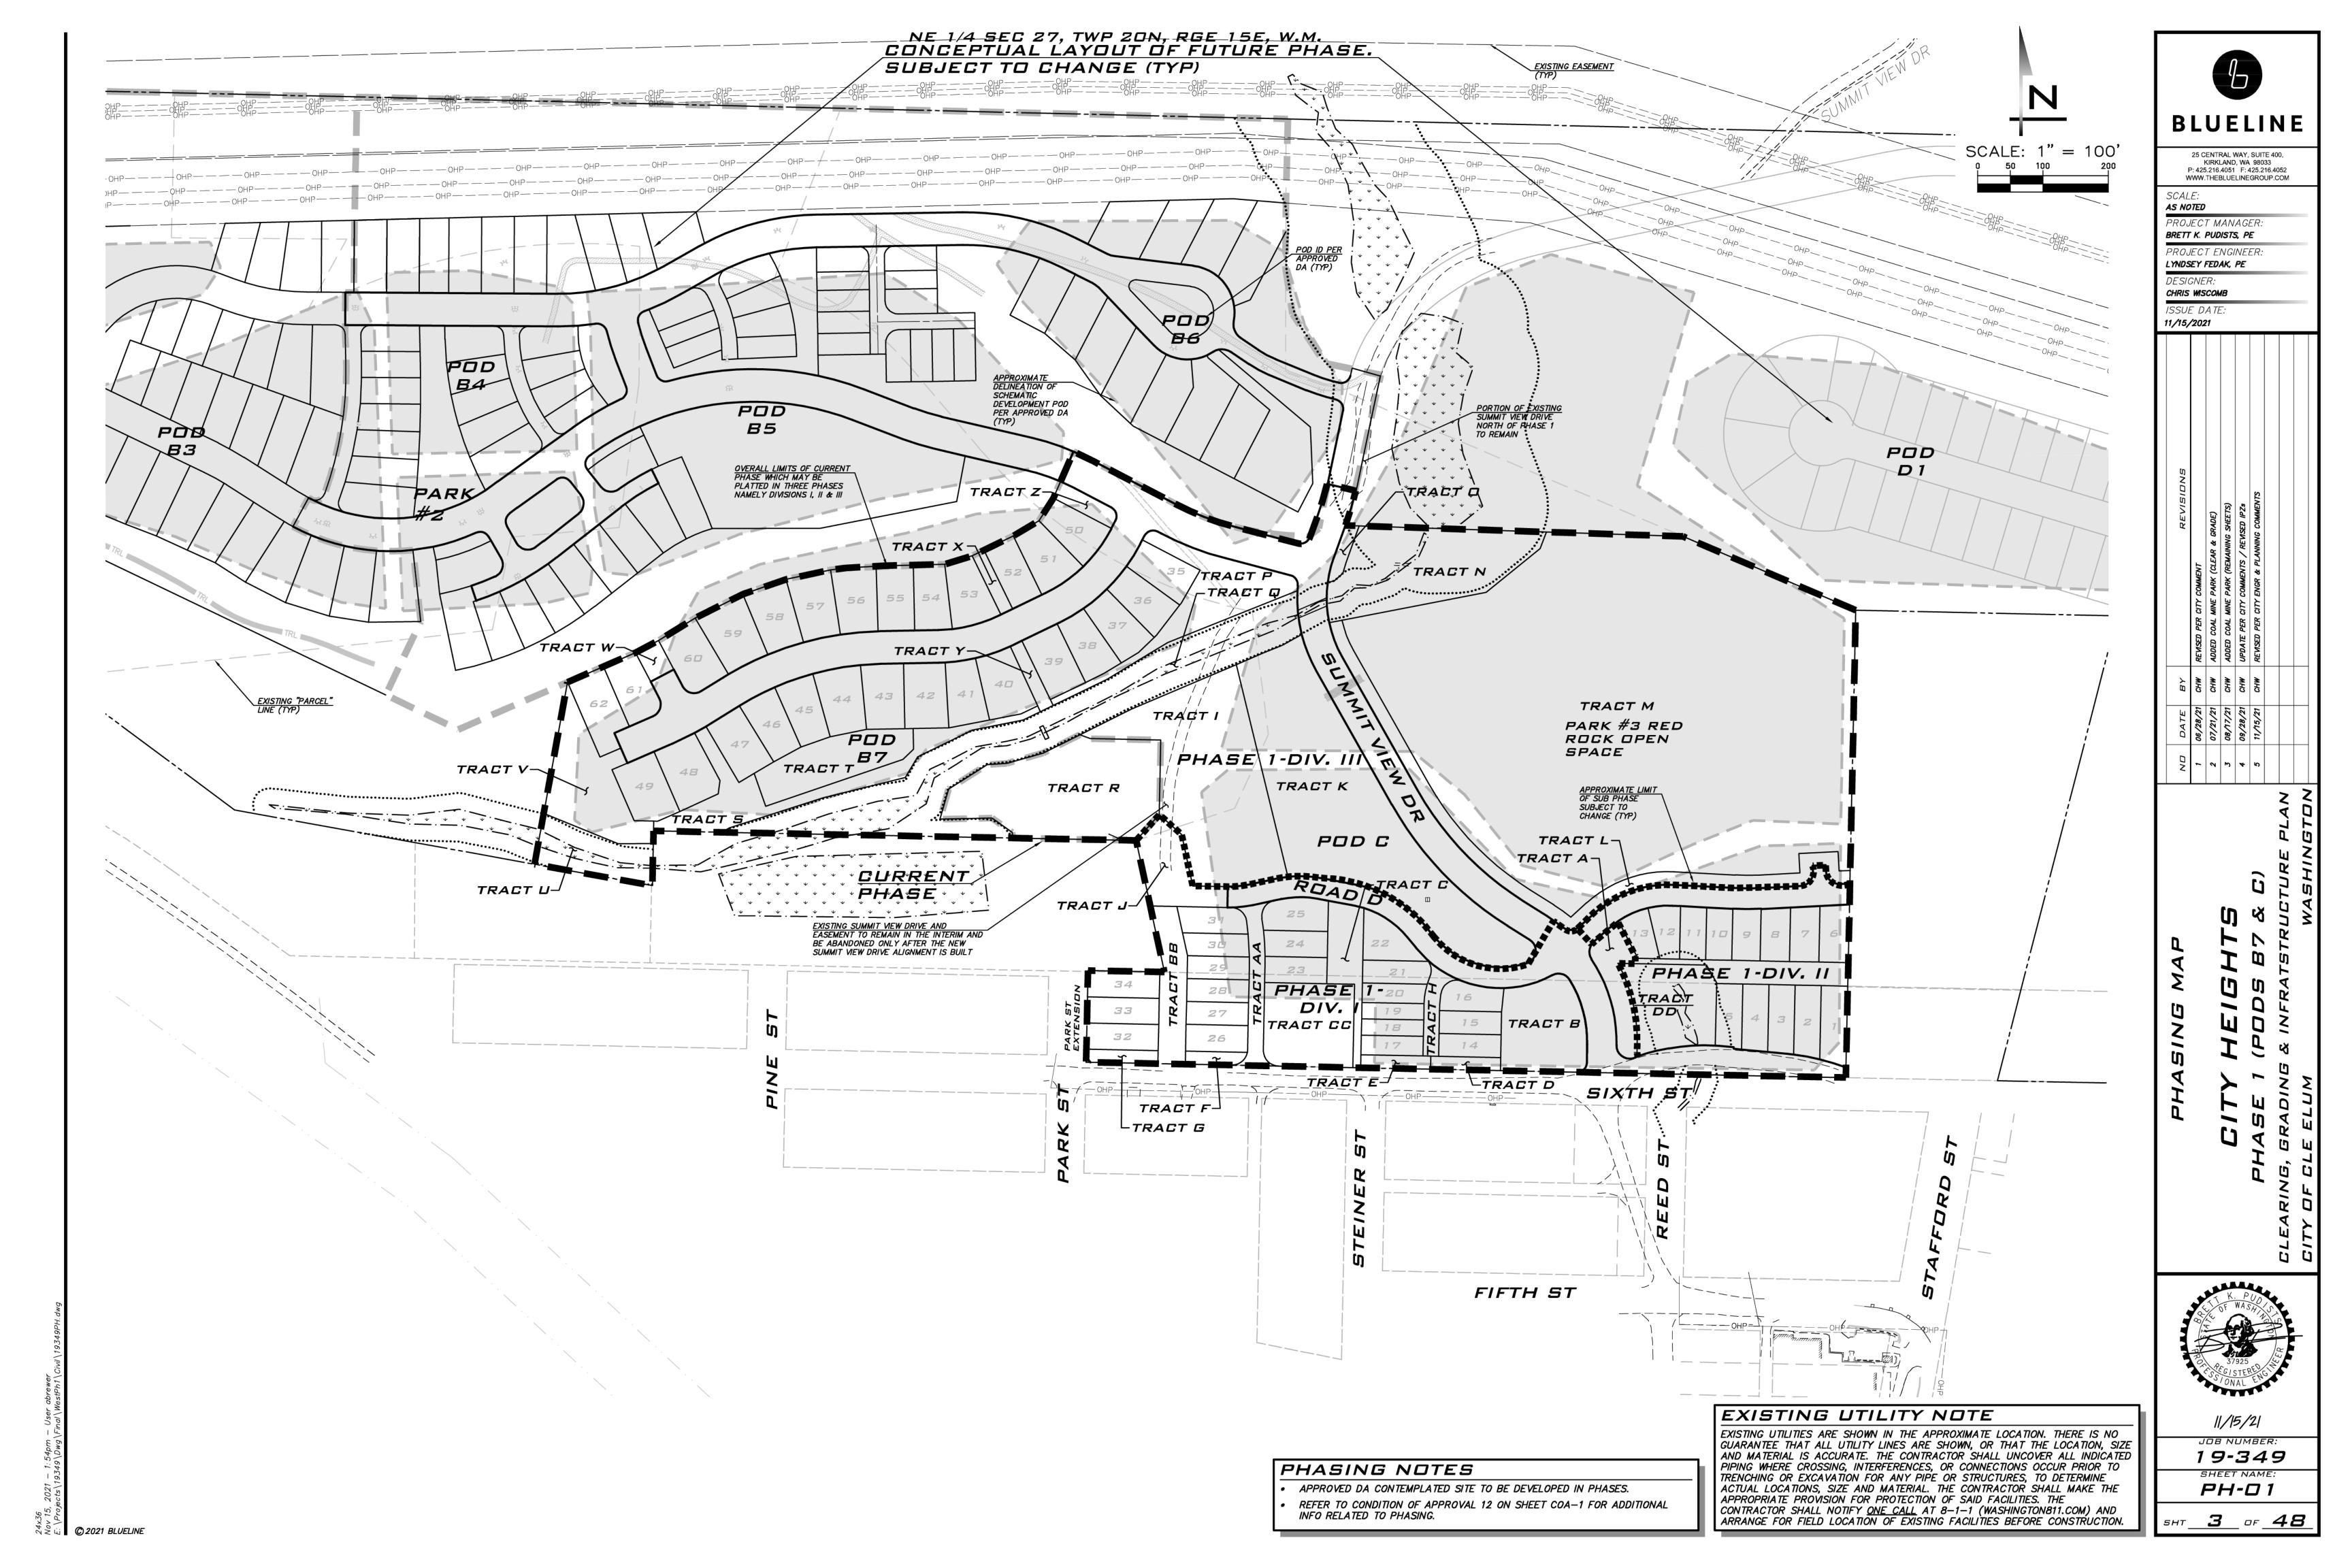

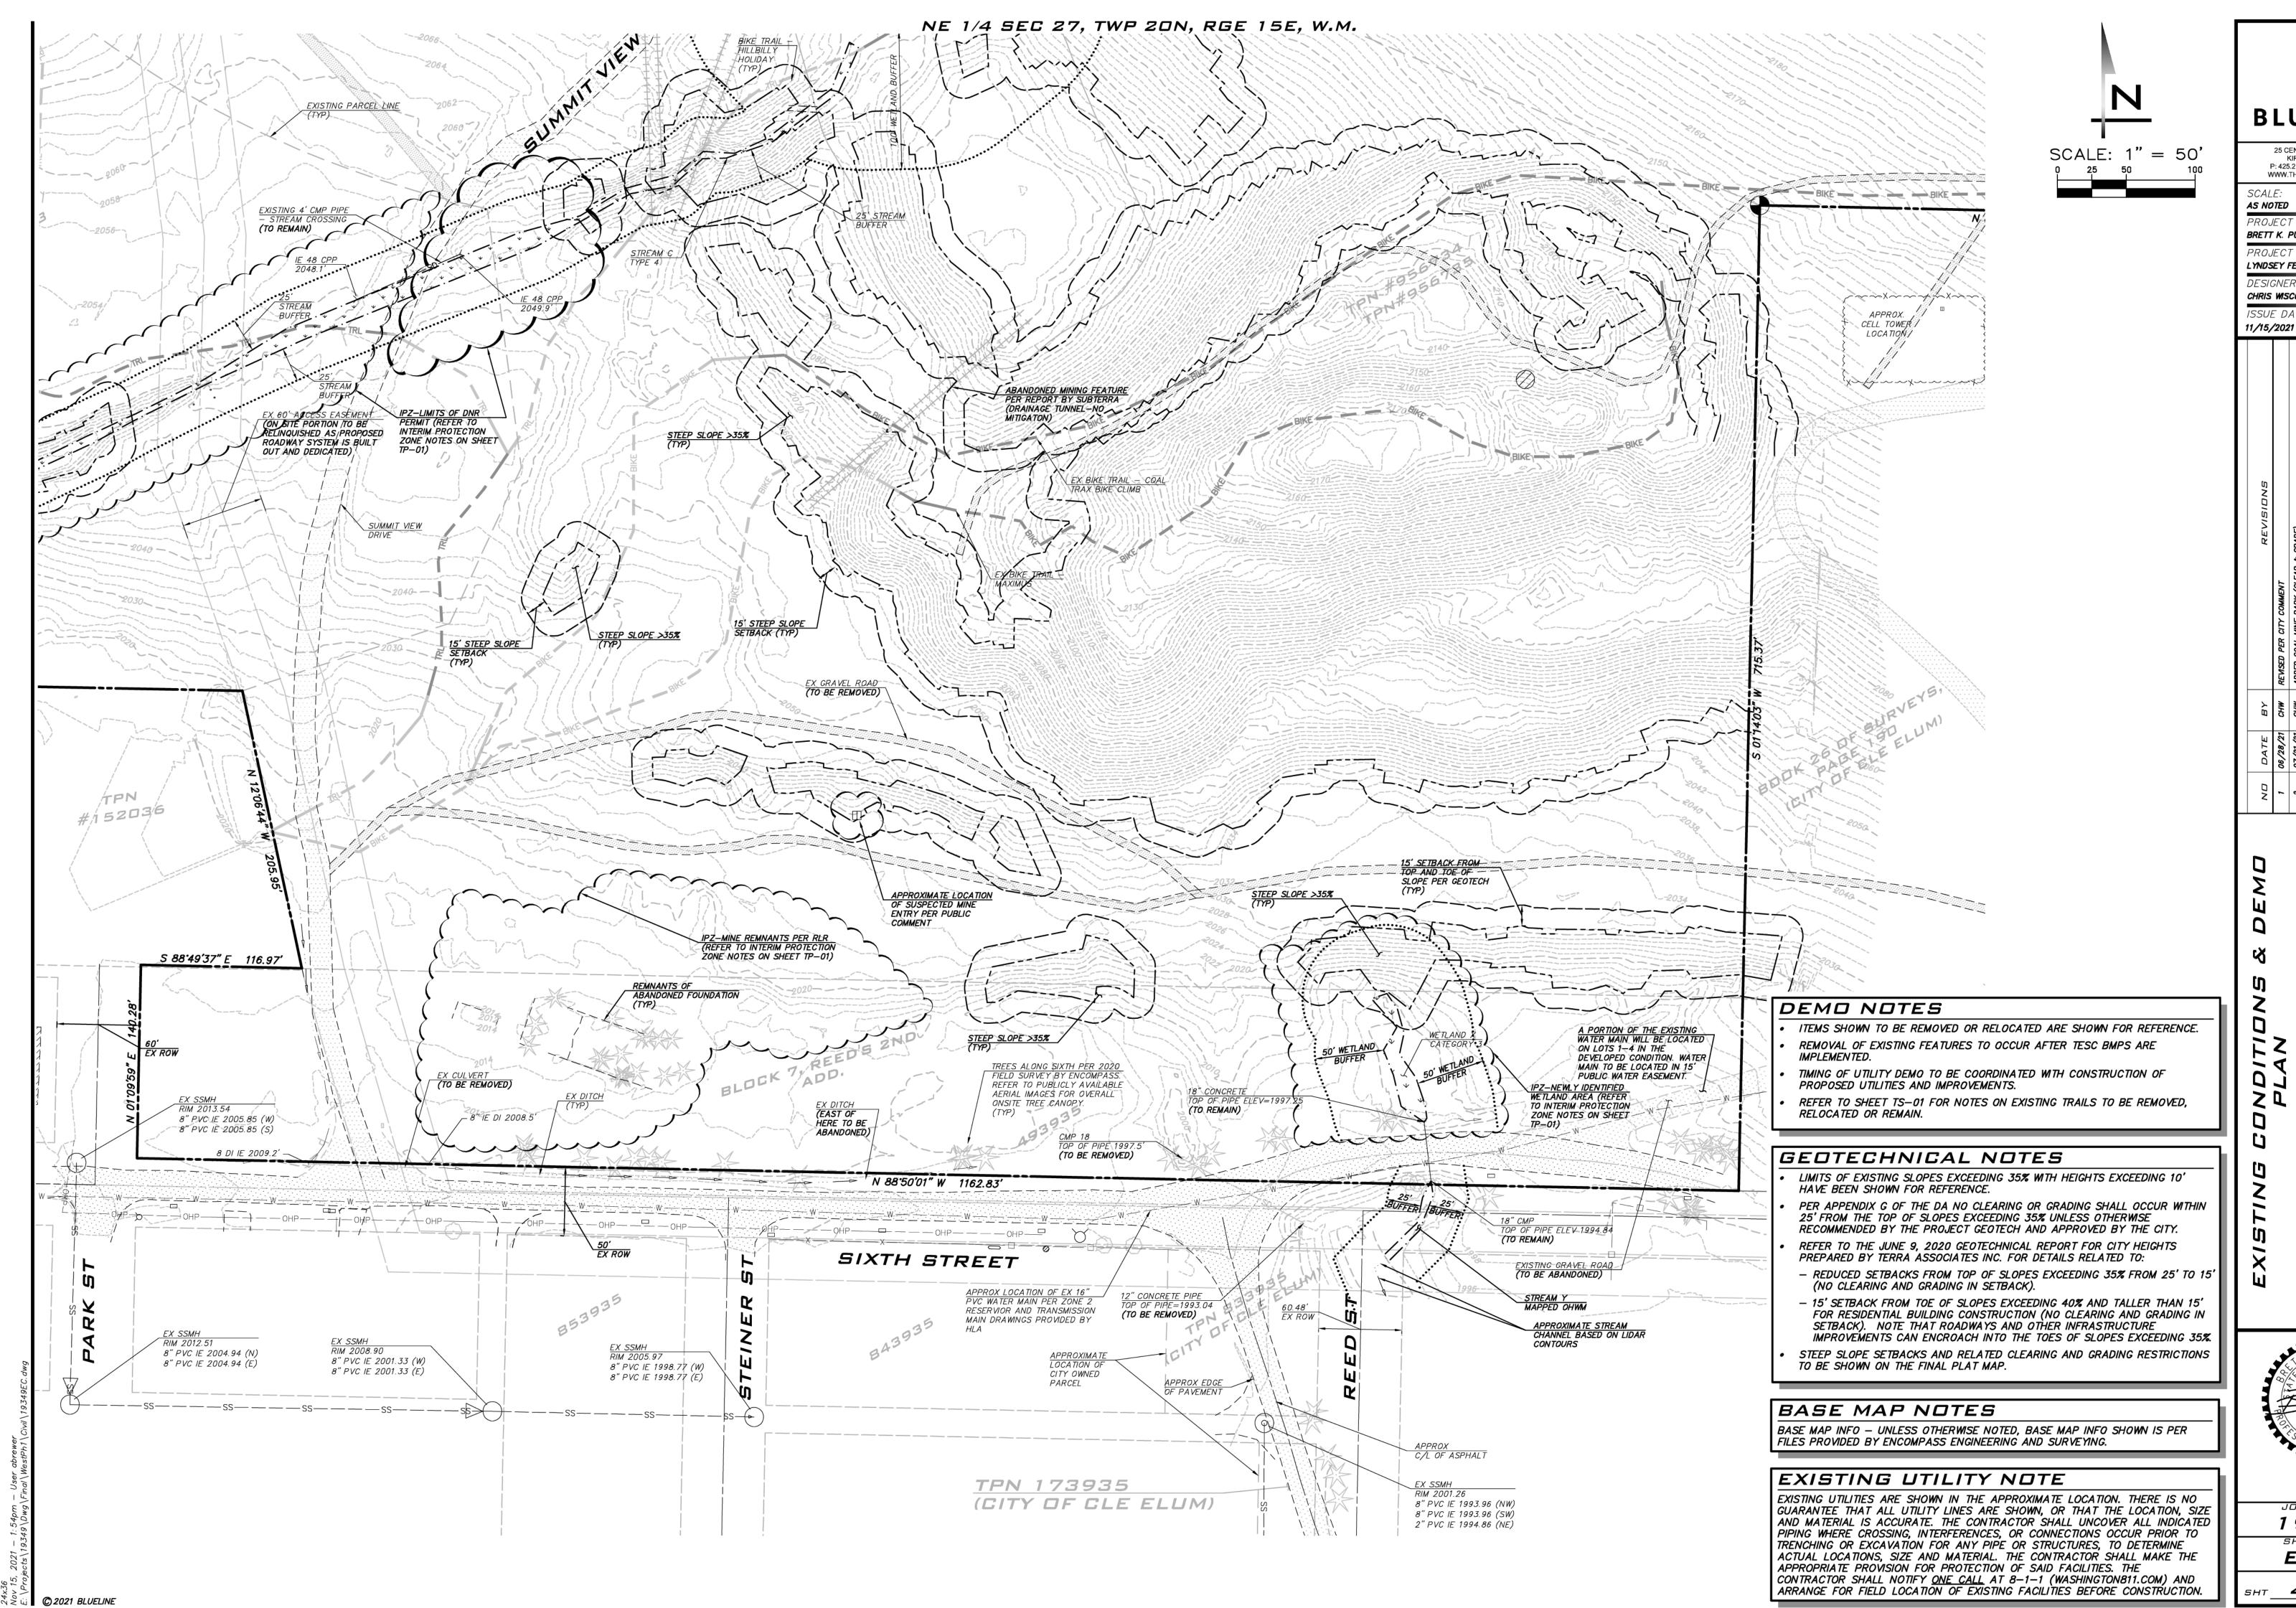BLUELINE

25 CENTRAL WAY, SUITE 400, KIRKLAND, WA 98033 P: 425.216.4051 F: 425.216.4052 WWW.THEBLUELINEGROUP.COM

PROJECT MANAGER. BRETT K. PUDISTS, PE

PROJECT ENGINEER. LYNDSEY FEDAK, PE


CHRIS WISCOMB

11/15/2021

11/15/21

19-349 EC-01

**4** of _**48**

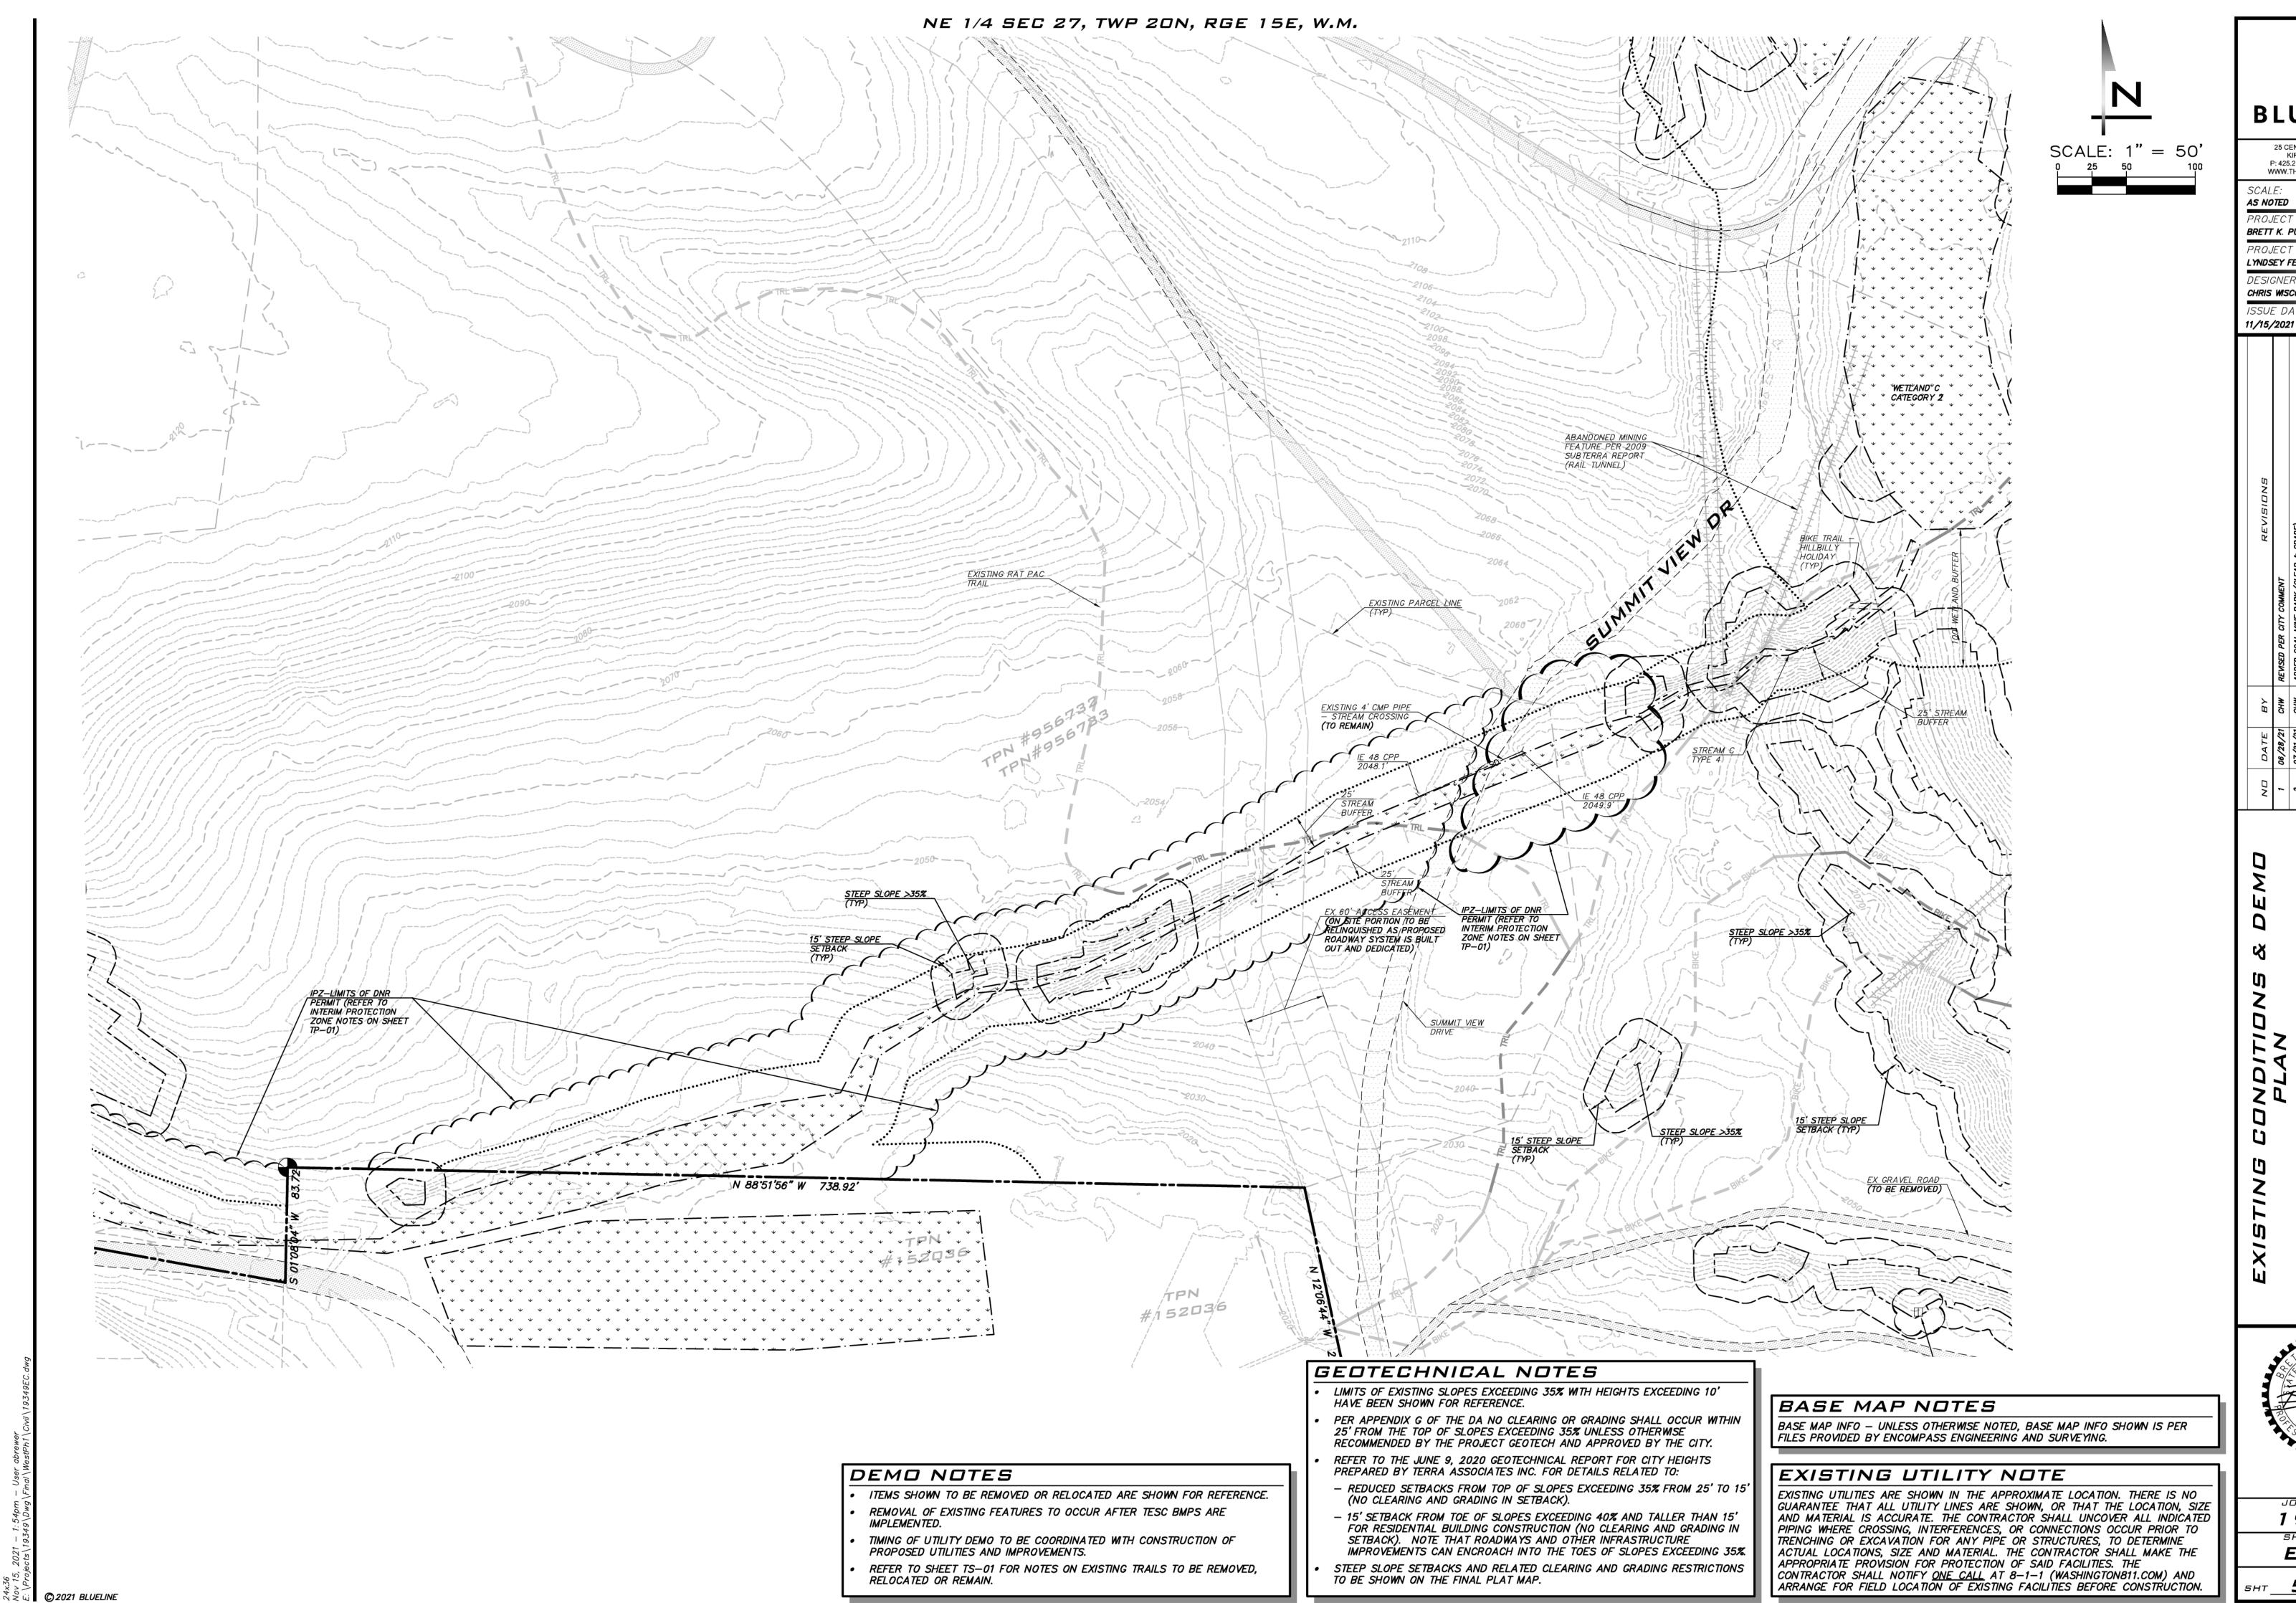

BLUELINE

25 CENTRAL WAY, SUITE 400, KIRKLAND, WA 98033 P: 425.216.4051 F: 425.216.4052 WWW.THEBLUELINEGROUP.COM

PROJECT MANAGER: BRETT K. PUDISTS, PE


PROJECT ENGINEER: LYNDSEY FEDAK, PE

CHRIS WISCOMB

11/15/21

19-349 EC-02

<u>5</u> of <u>48</u>

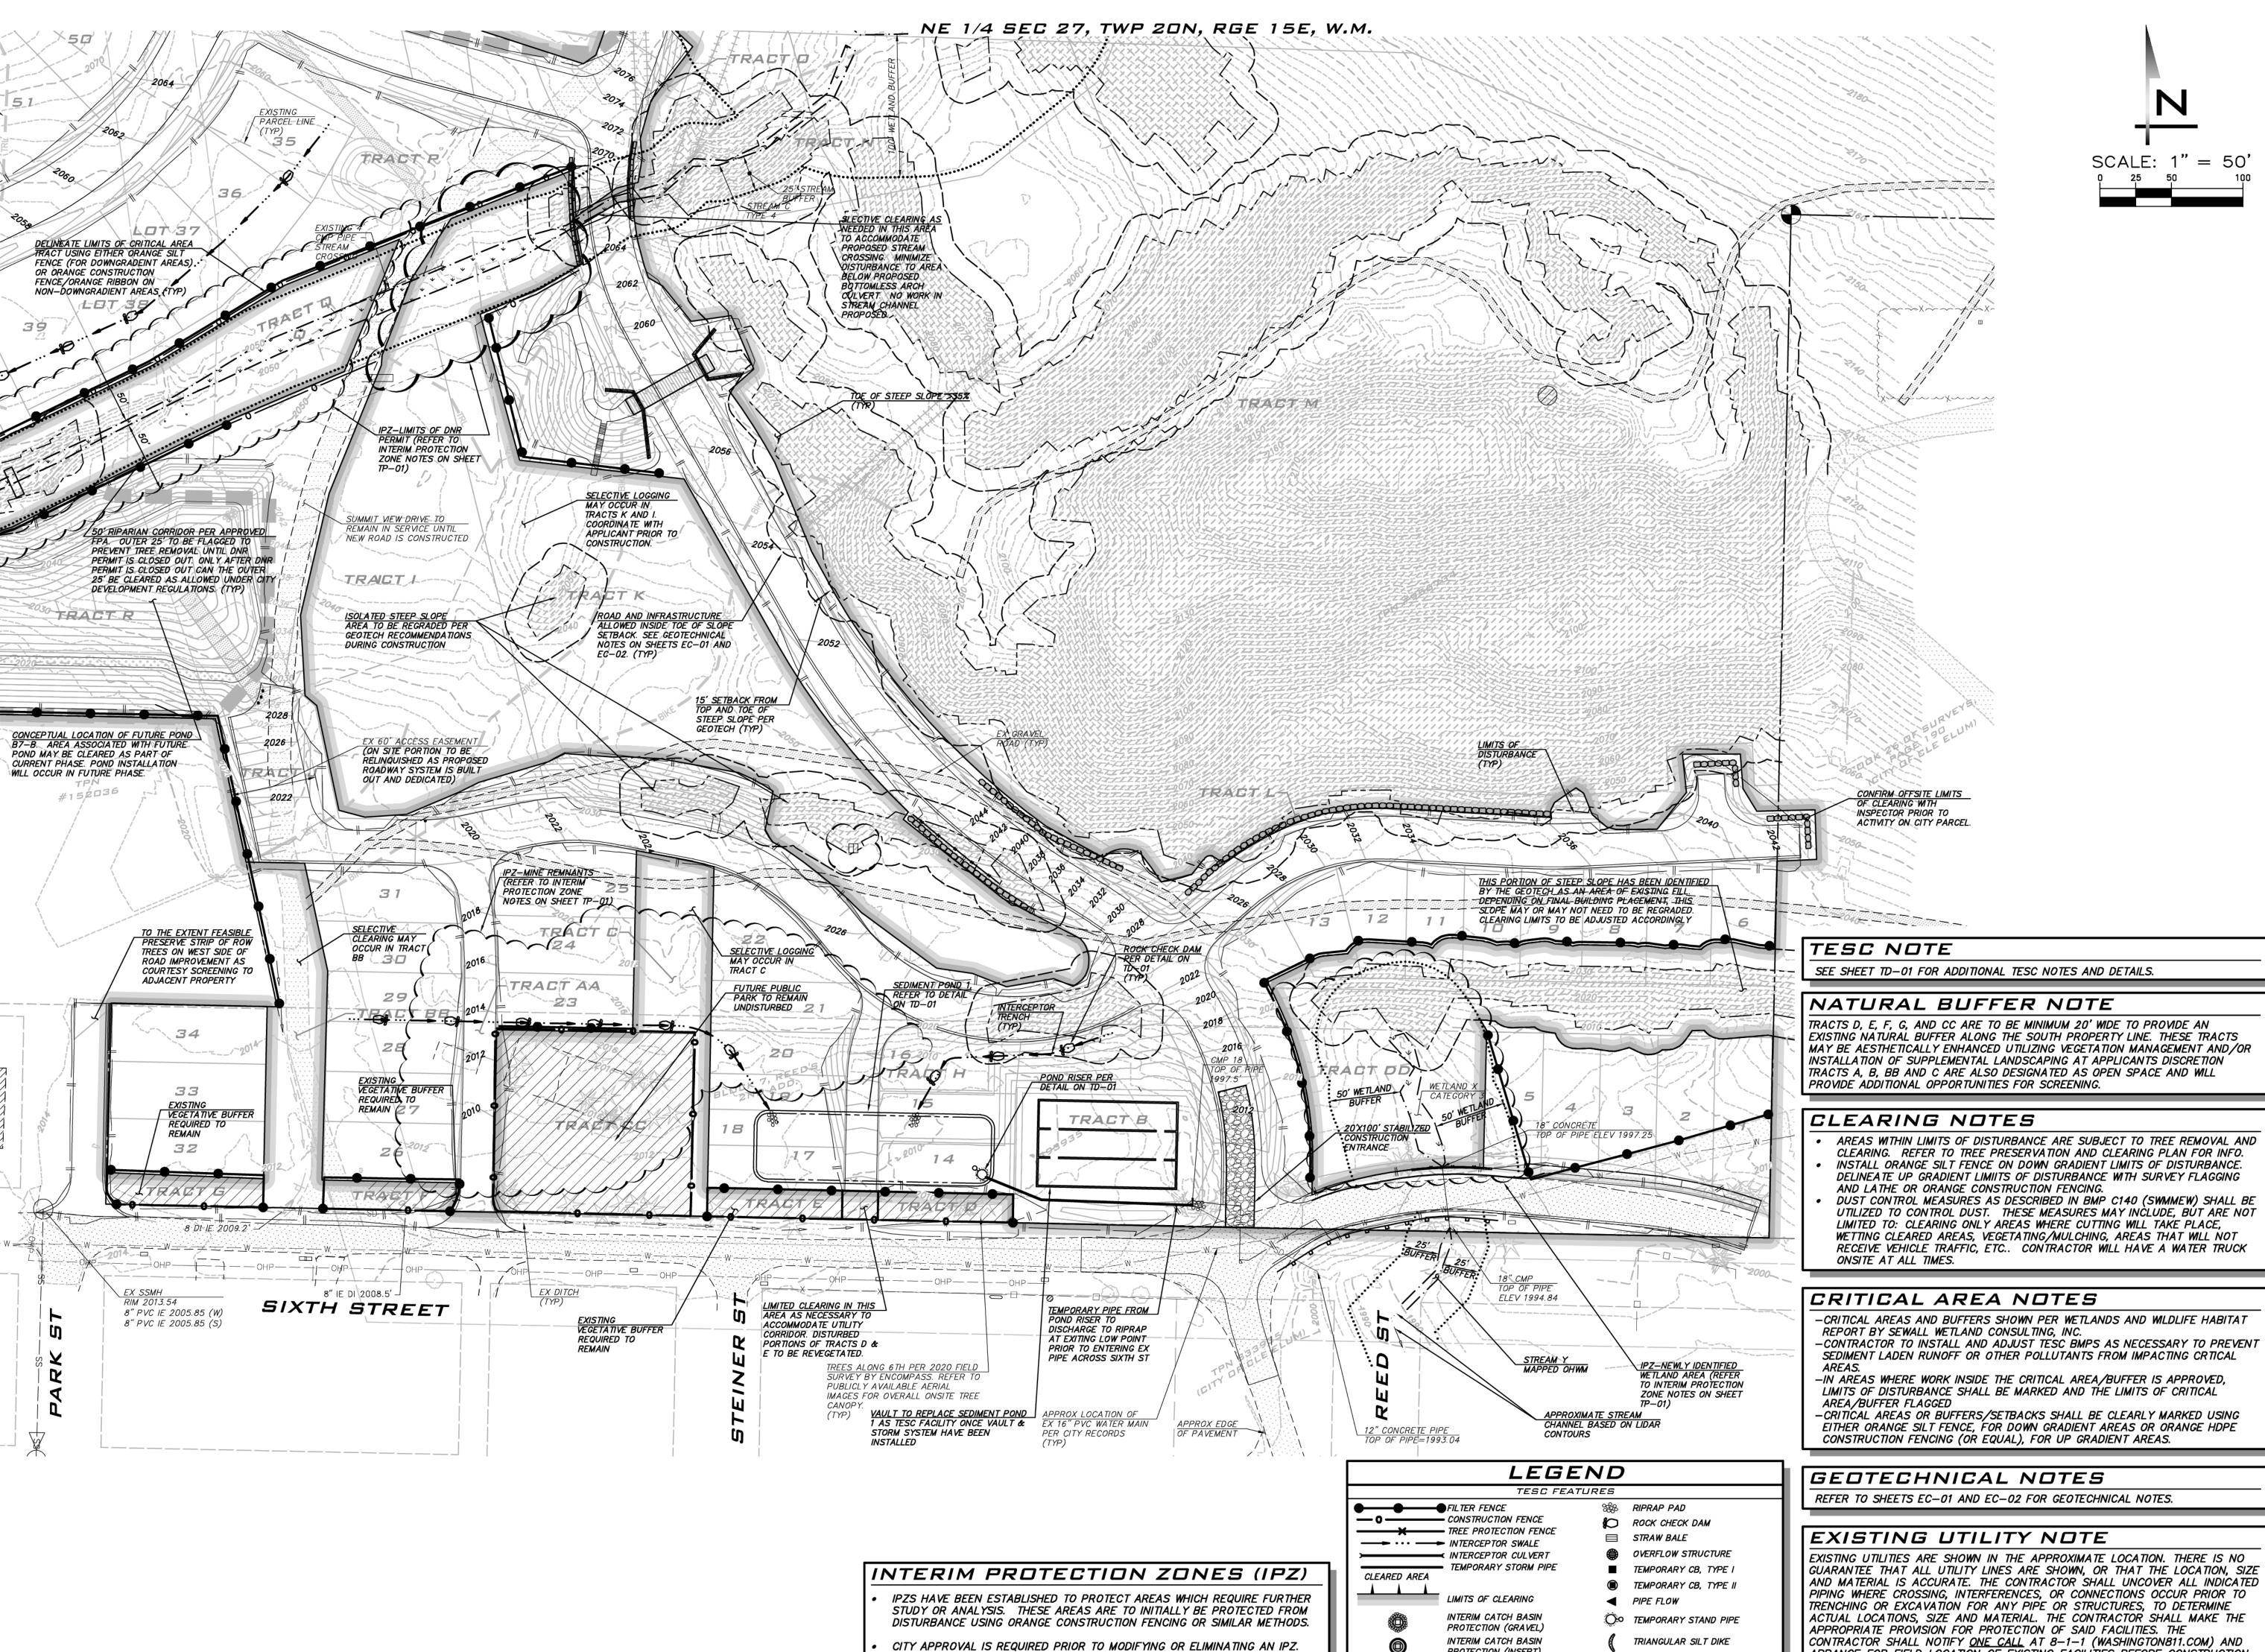

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PROTECTION (INSERT)

BLUELINE

25 CENTRAL WAY, SUITE 400, KIRKLAND, WA 98033 P: 425.216.4051 F: 425.216.4052

WWW.THEBLUELINEGROUP.COM

AS NOTED PROJECT MANAGER.

BRETT K. PUDISTS, PE PROJECT ENGINEER. LYNDSEY FEDAK, PE

CHRIS WISCOMB


11/15/2021

11/15/21

19-349 SHEET NAME: TP-01

<u>6</u> of 48

ARRANGE FOR FIELD LOCATION OF EXISTING FACILITIES BEFORE CONSTRUCTION.

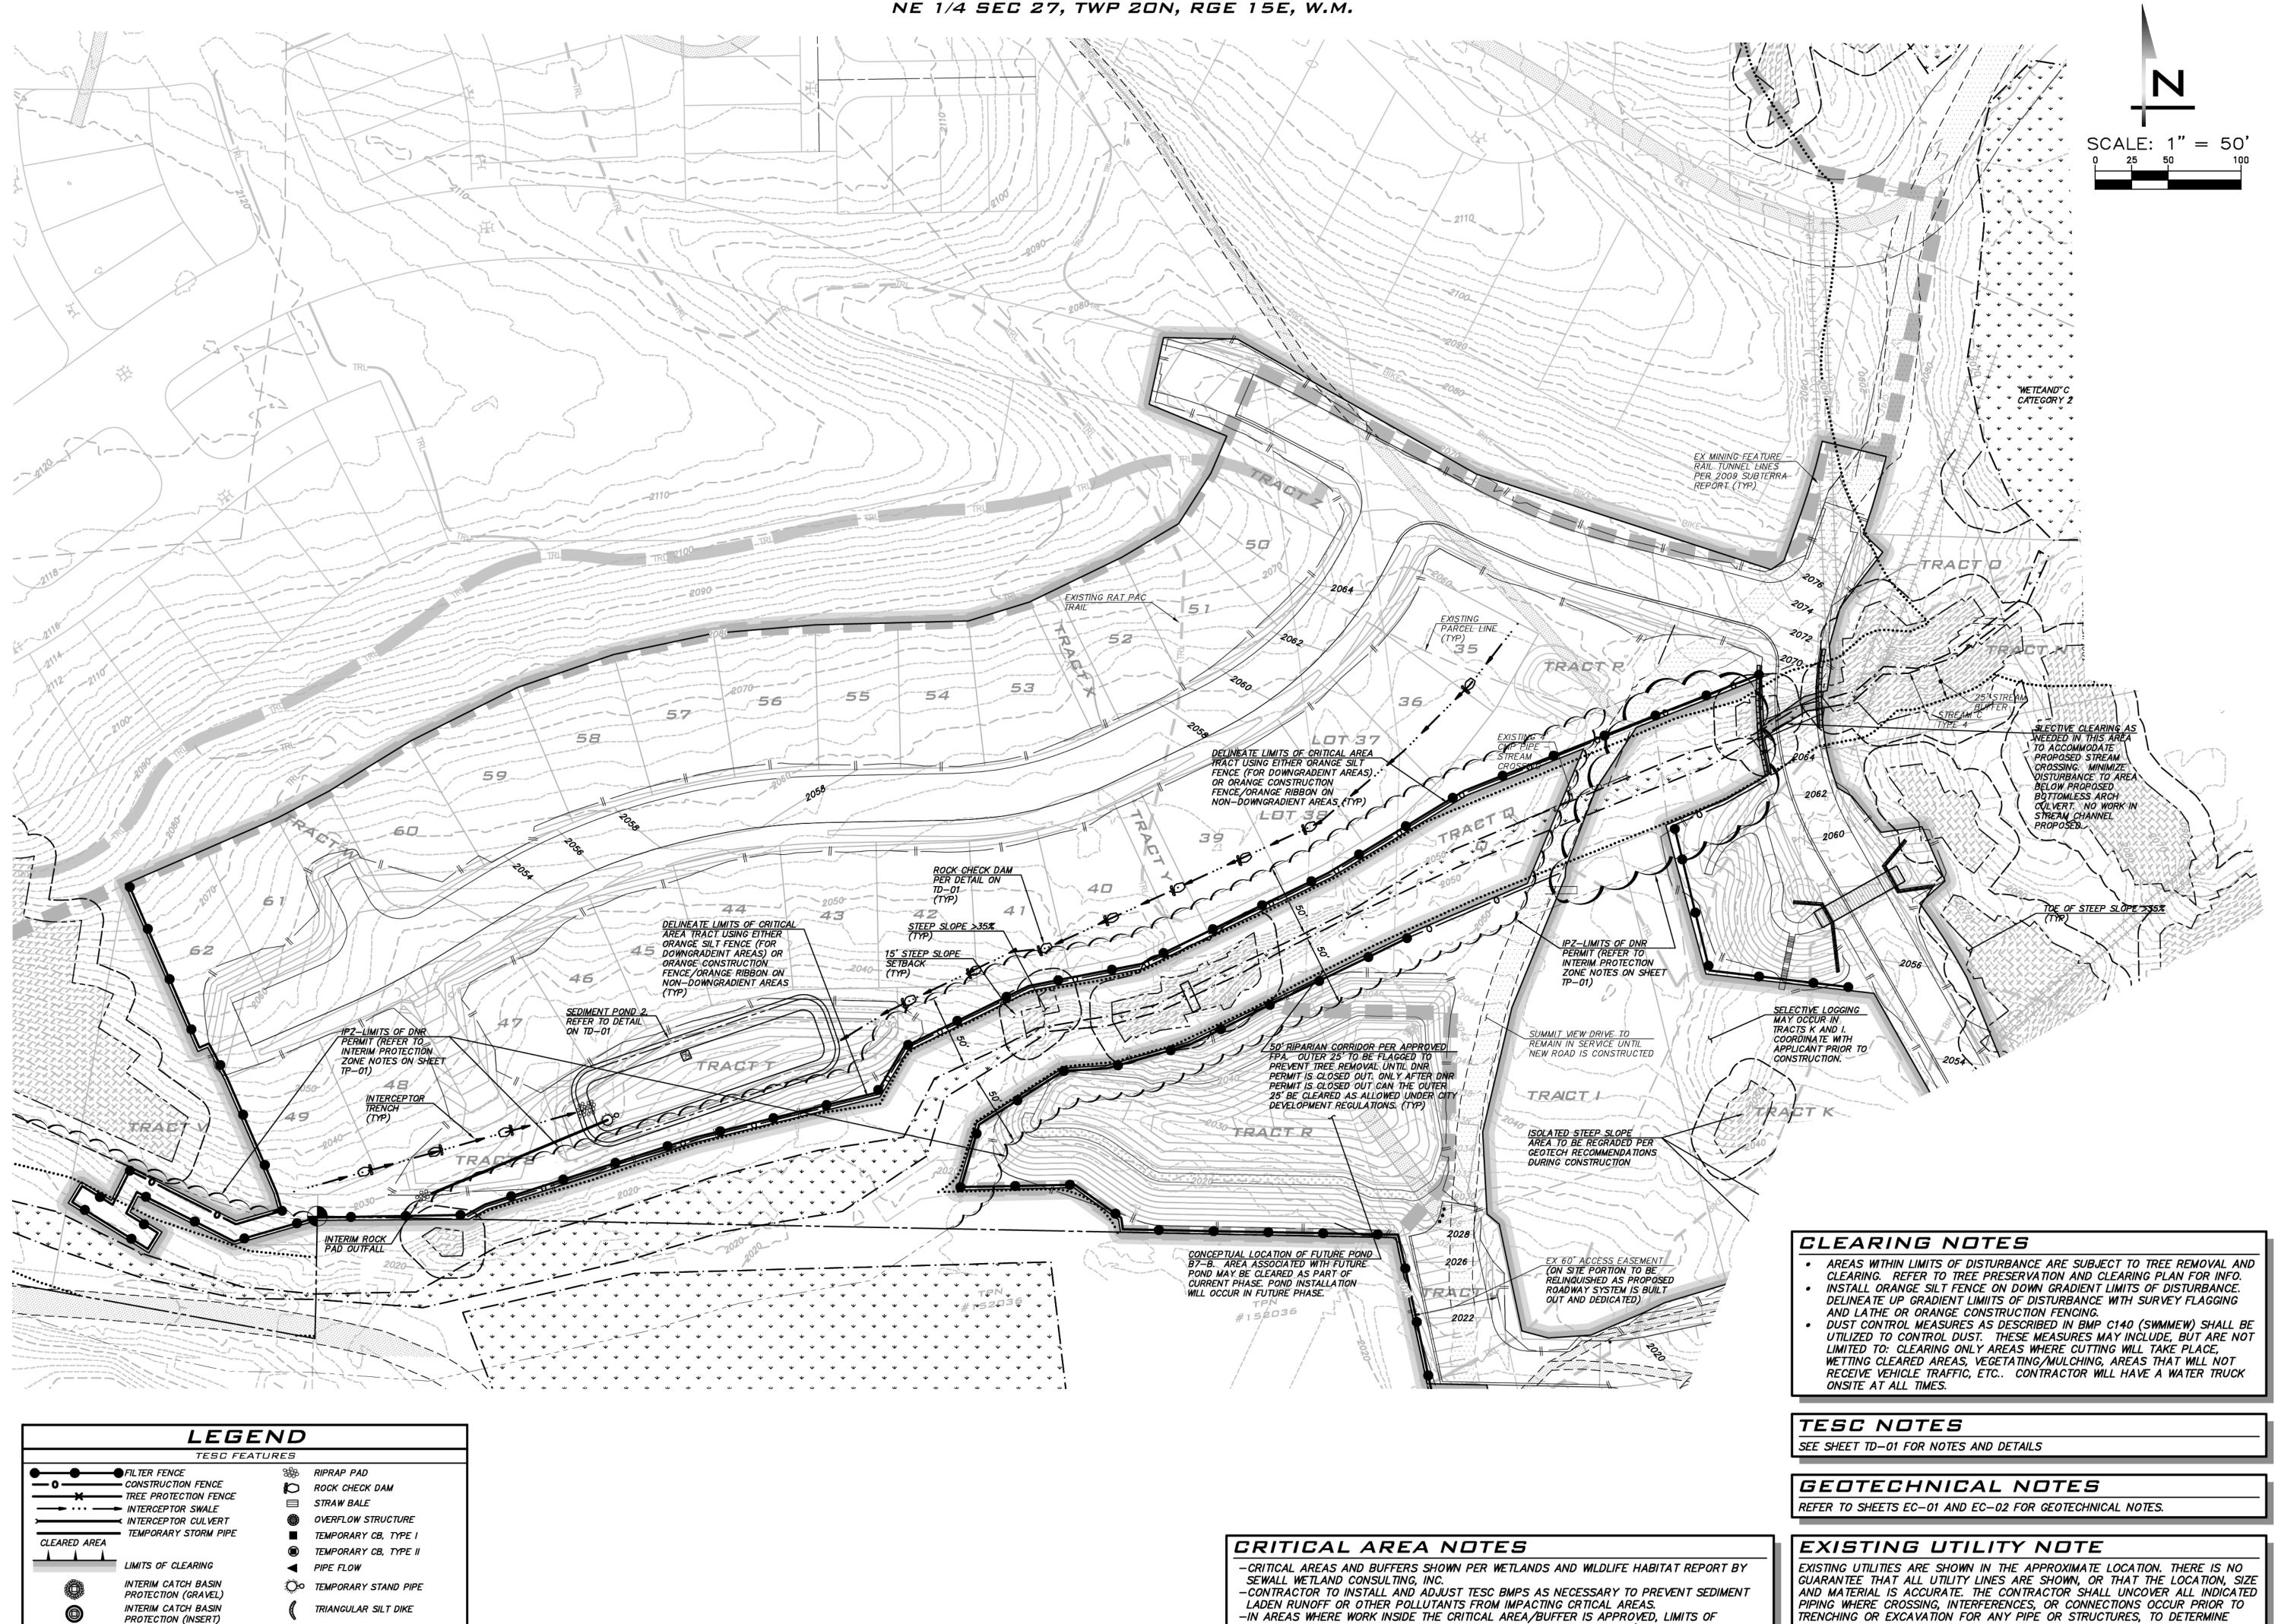

BLUELINE

25 CENTRAL WAY, SUITE 400, KIRKLAND, WA 98033 P: 425.216.4051 F: 425.216.4052 WWW.THEBLUELINEGROUP.COM

AS NOTED

PROJECT MANAGER: BRETT K. PUDISTS, PE

PROJECT ENGINEER: LYNDSEY FEDAK, PE

CHRIS WISCOMB ISSUE DATE:

11/15/2021

11/15/21

19-349 TP-02

ACTUAL LOCATIONS, SIZE AND MATERIAL. THE CONTRACTOR SHALL MAKE THE

CONTRACTOR SHALL NOTIFY ONE CALL AT 8-1-1 (WASHINGTON811.COM) AND ARRANGE FOR FIELD LOCATION OF EXISTING FACILITIES BEFORE CONSTRUCTION.

APPROPRIATE PROVISION FOR PROTECTION OF SAID FACILITIES. THE

<u>7</u> of <u>48</u>

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-IN AREAS WHERE WORK INSIDE THE CRITICAL AREA/BUFFER IS APPROVED, LIMITS OF

DISTURBANCE SHALL BE MARKED AND THE LIMITS OF CRITICAL AREA/BUFFER FLAGGED -CRITICAL AREAS OR BUFFERS/SETBACKS SHALL BE CLEARLY MARKED USING EITHER ORANGE SILT FENCE, FOR DOWN GRADIENT AREAS OR ORANGE HDPE CONSTRUCTION FENCING (OR EQUAL), FOR UP GRADIENT AREAS.

• THE IMPLEMENTATION OF THIS ESC PLAN AND THE CONSTRUCTION, MAINTENANCE, REPLACEMENT, AND UPGRADING OF THESE ESC BMPS IS THE RESPONSIBILITY OF THE APPLICANT UNTIL ALL CONSTRUCTION IS COMPLETED AND APPROVED AND VEGETATION/LANDSCAPING IS

• CLEARLY FLAG THE BOUNDARIES OF THE CLEARING LIMITS SHOWN ON THIS PLAN IN THE FIELD PRIOR TO CONSTRUCTION. DURING THE CONSTRUCTION PERIOD, NO DISTURBANCE BEYOND THE FLAGGED CLEARING LIMITS SHALL BE PERMITTED. THE FLAGGING SHALL BE

• CONSTRUCT THE ESC BMPS SHOWN ON THIS PLAN IN CONJUNCTION WITH ALL CLEARING AND GRADING ACTIVITIES, AND IN SUCH A MANNER AS TO ENSURE THAT SEDIMENT AND SEDIMENT LADEN WATER DO NOT ENTER THE DRAINAGE SYSTEM, ROADWAYS, OR VIOLATE APPLICABLE

• THE ESC BMPS SHOWN ON THIS PLAN ARE THE MINIMUM REQUIREMENTS FOR ANTICIPATED SITE CONDITIONS. DURING THE CONSTRUCTION PERIOD, UPGRADE THESE ESC BMPS AS NEEDED FOR UNEXPECTED STORM EVENTS AND TO ENSURE THAT SEDIMENT AND SEDIMENT-LADEN WATER DO NOT LEAVE THE SITE OR ENTER CRITICAL AREAS.

• THE APPLICANT SHALL INSPECT THE ESC BMPS DAILY AND MAINTAIN THEM AS NECESSARY TO ENSURE THEIR CONTINUED FUNCTIONALITY. • INSPECT AND MAINTAIN THE ESC BMPS ON INACTIVE SITES A MINIMUM OF ONCE A MONTH OR WITHIN THE 48 HOURS FOLLOWING A MAJOR

STORM EVENT (24-HOUR STORM EVENT WITH A 10-YEAR OR GREATER RECURRENCE INTERVAL). • CONTRACTOR TO STOCKPILE 200 LF OF EXTRA EROSION CONTROL FENCING ONSITE TO BE USED, AS NEEDED, IF ADVERSE WEATHER CONDITIONS WARRANT ADDITIONAL TESC MEASURES.

• AT NO TIME SHALL THE SEDIMENT EXCEED 60 PERCENT OF THE SUMP DEPTH OR HAVE LESS THAN 6 INCHES OF CLEARANCE FROM THE SEDIMENT SURFACE TO THE INVERT OF THE LOWEST PIPE. ALL CATCH BASINS AND CONVEYANCE LINES SHALL BE CLEANED PRIOR TO PAVING. THE CLEANING OPERATION SHALL NOT FLUSH SEDIMENT LADEN WATER INTO THE DOWNSTREAM SYSTEM.

• INSTALL STABILIZED CONSTRUCTION ENTRANCES AT THE BEGINNING OF CONSTRUCTION AND MAINTAIN FOR THE DURATION OF THE PROJECT. ADDITIONAL MEASURES MAY BE REQUIRED TO ENSURE THAT ALL PAVED AREAS ARE KEPT CLEAN FOR THE DURATION OF THE PROJECT.

CONSTRUCTION SEQUENCE

1. HOLD THE PRE-CONSTRUCTION MEETING.

2.FLAG OR FENCE CLEARING LIMITS. 3.INSTALL CATCH BASIN PROTECTION, IF REQUIRED. INSTALL FLOW CONTROL BMP AREA PROTECTION, IF REQUIRED.

4. GRADE AND INSTALL CONSTRUCTION ENTRANCE(S).

5.INSTALL PERIMETER PROTECTION (SILT FENCE, BRUSH BARRIER, ETC.).

MAINTAINED BY THE APPLICANT FOR THE DURATION OF CONSTRUCTION.

6. CONSTRUCT TEMPORARY SEDIMENT PONDS AND TRAPS. 7. GRADE AND STABILIZE CONSTRUCTION ROADS.

8. CONSTRUCT SURFACE WATER CONTROLS (INTERCEPTOR DIKES, PIPE SLOPE DRAINS, ETC.) SIMULTANEOUSLY WITH CLEARING AND GRADING FOR PROJECT DEVELOPMENT.

9. MAINTAIN EROSION CONTROL AND SWPPS MEASURES IN ACCORDANCE WITH DOE STANDARDS, CITY OF CLE ELUM AND MANUFACTURER'S

10. RELOCATE EROSION CONTROL AND SWPPS MEASURES, OR INSTALL NEW MEASURES SO THAT AS SITE CONDITIONS CHANGE, THE EROSION AND SEDIMENT CONTROL AND POLLUTANT PROTECTION IS ALWAYS IN ACCORDANCE WITH THE DOE CONSTRUCTION STORMWATER POLLUTION

11. COVER ALL AREAS THAT WILL BE UNWORKED FOR MORE THAN SEVEN DAYS DURING THE DRY SEASON OR TWO DAYS DURING THE WET SEASON WITH STRAW, WOOD FIBER MULCH, COMPOST, PLASTIC SHEETING, OR EQUIVALENT.

12. STABILIZE ALL AREAS WITHIN SEVEN DAYS OF REACHING FINAL GRADE.

14. UPON COMPLETION OF THE PROJECT, STABILIZE ALL DISTURBED AREAS AND REMOVE BMPS IF APPROPRIATE.

13. SEED, SOD, STABILIZE, OR COVER ANY AREAS TO REMAIN UNWORKED FOR MORE THAN 30 DAYS.

WET SEASON SPECIAL PROVISIONS

• THE ALLOWED TIME THAT A DISTURBED AREA MAY REMAIN UNWORKED WITHOUT COVER MEASURES IS REDUCED TO TWO CONSECUTIVE WORKING DAYS, RATHER THAN SEVEN.

• STOCKPILES AND STEEP CUT AND FILL SLOPES ARE TO BE PROTECTED IF UNWORKED FOR MORE THAN 12 HOURS. • COVER MATERIALS SUFFICIENT TO COVER ALL DISTURBED AREAS SHALL BE STOCKPILED ON SITE.

• ALL AREAS THAT ARE TO BE UNWORKED DURING THE WET SEASON SHALL BE SEEDED WITHIN ONE WEEK OF THE BEGINNING OF THE WET

• MULCH IS REQUIRED TO PROTECT ALL SEEDED AREAS.


• FIFTY LINEAR FEET OF SILT FENCE (AND THE NECESSARY STAKES) PER ACRE OF DISTURBANCE MUST BE STOCKPILED ON SITE. • CONSTRUCTION ROAD AND PARKING LOT STABILIZATION ARE REQUIRED FOR ALL SITES UNLESS THE SITE IS UNDERLAIN BY COARSE-GRAINED

• SEDIMENT RETENTION IS REQUIRED UNLESS NO OFFSITE DISCHARGE IS ANTICIPATED FOR THE SPECIFIED DESIGN FLOW. • SURFACE WATER CONTROLS ARE REQUIRED UNLESS NO OFFSITE DISCHARGE IS ANTICIPATED FOR THE SPECIFIED DESIGN FLOW.

• PHASING AND MORE CONSERVATIVE BMPS MUST BE EVALUATED FOR CONSTRUCTION ACTIVITY NEAR SURFACE WATERS.

• ANY RUNOFF GENERATED BY DEWATERING MAY BE REQUIRED TO DISCHARGE TO THE SANITARY SEWER (WITH APPROPRIATE DISCHARGE AUTHORIZATION), PORTABLE SAND FILTER SYSTEMS, OR HOLDING TANKS.

AS AND REMOVE BMPS IF APPROPRIATE.

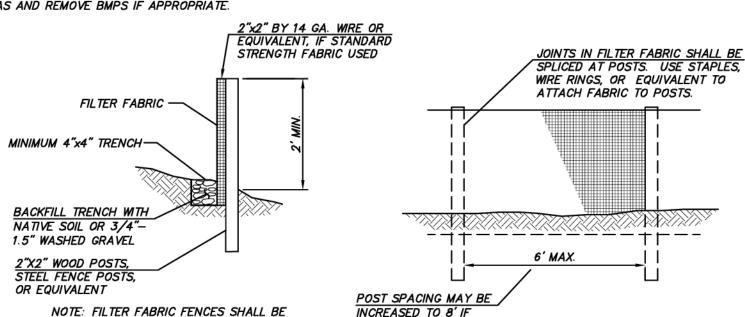

INSTALLED ALONG CONTOUR WHENEVER POSSIBLE WIRE BACKING IS USED

SILT FENCE

(NOT TO SCALE)

CSWPP & SPILL PREVENTION NOTES

1. LIQUID POLLUTANTS SUCH AS PETROLEUM PRODUCTS, FUEL, SOLVENTS, DETERGENTS, PAINTS, PESTICIDES, CONCRETE ADMIXTURES, FORM OILS, ETC. SHALL NOT BE STORED ON SITE.

2. CONSTRUCTION MATERIALS AND WASTES SHALL BE STORED AT THE DESIGNATED STOCKPILE AREA WHICH WILL BE IDENTIFIED BY THE CONTRACTOR AT THE ONSET OF CONSTRUCTION.

3. REFUELING SHALL BE PROVIDED BY A FUELING TRUCK. NO FUEL SHALL BE STORED ON SITE. REFUELING SHALL OCCUR IN A MANNER THAT DOES NOT CAUSE CONTAMINATION OF SOIL AND STORM WATER INCLUDING STREAMS, WETLANDS, AND MAN MADE CONVEYANCE SYSTEMS. SPILL KITS SHOULD BE KEPT ON HAND AND ACCESSIBLE DURING REFUELING ACTIVITIES.

4. VEHICLE MAINTENANCE AND REPAIRS SHALL BE DONE OFFSITE TO THE EXTENT FEASIBLE. IF TEMPORARY WORK IS CONDUCTED ONSITE IT SHALL BE DONE IN ACCORDANCE WITH THE CONTRACTOR'S SITE SPECIFIC SPILL PREVENTION PLAN WHICH, AT A MINIMUM, SHALL OUTLINE MEASURES TO (A) PREVENT CONTAMINATION OF THE ENVIRONMENT (WATER, AIR, SOIL, ETC) (B) ENSURE ONSITE WORKERS ARE TRAINED IN THE PROPER HANDLING, STÒRAGE, DISPOSAL, AND EMÉRGENCY CLEAN UP OF VEHICLE AND EQUIPMENT FLUIDS.

5. CONCRETE WASTE SHALL BE HANDLED AS LISTED:

A. UNUSED CONCRETE REMAINING IN THE TRUCK AND PUMP SHALL BE RETURNED TO ORIGINATING BATCH PLANT FOR RECYCLING.

CONCRETE TRUCK CHUTES, PUMPS, INTERNALS, HAND TOOLS, ETC SHALL BE WASHED OFF ONLY INTO FORMED AREAS AWAITING INSTALLATION OF CONCRETE OR ASPHALT OR IN DESIGNATED WASH OUT

C. WHEN NO FORMED AREAS ARE AVAILABLE, CONCRETE WASTE SHALL BE DISCHARGED TO A PAVED OR LINED SUMP (WASH OUT AREA). LOCATION OF SUMP TO BE DETERMINED BY EROSION CONTROL SUPERVISOR. WASTE WATER WITHIN THE SUMP SHALL EITHER BE NEUTRALIZED PRIOR TO DISCHARGE TO THE SEDIMENTATION FACILITY OR DISPOSED OF IN A MANNER THAT DOES NOT VIOLATE GROUNDWATER OR SURFACE WATER QUALITY STANDARDS.


D. EQUIPMENT THAT CANNOT BE EASILY MOVED, SUCH AS CONCRETE PAVERS, SHALL ONLY BE WASHED IN AREAS THAT DO NOT DIRECTLY DRAIN TO NATURAL OR CONSTRUCTED STORMWATER CONVEYANCES.

6. SLURRY, CUTTINGS, AND PROCESS WATER FROM SAWCUTTING AND SURFACING SHALL BE DISCHARGED TO FORMED AREAS AWAITING INSTALLATION OF CONCRETE OR ASPHALT OR TO PAVED OR LINED SUMP.

7. PH NEUTRALIZATION SHALL BE USED WHEN PH LEVELS IN STORMWATER RISE ABOVE 8.5, STORMWATER WITH PH LEVELS EXCEEDING WATER QUALITY STDANDADRDS MAY BE TREATED BY DOE BMP'S SUCH AS INFILTRATION, DISPERSION IN VEGETATION OR COMPOST, PUMPING TO A SANITARY SEWER, DISPOSAL AT A PERMITTED CONCRETE BATCH PLANT WITH PH NEUTRALIZATION CAPABILITIES, OR CARBON DIOXIDE

8. APPLICATION OF AGRICULTURAL CHEMICALS, INCLUDING FERTILIZERS AND PESTICIDES, SHALL BE CONDUCTED IN A MANNER AND AT APPLICATION RATES THAT WILL NOT RESULT IN LOSS OF CHEMICAL TO STORMWATER RUNOFF. MANUFACTURERS' RECOMMENDATIONS FOR APPLICATION RATES AND PROCEDURES SHALL BE FOLLOWED.


9. THE CONTRACTOR SHALL DESIGNATE A PERSON AS THE RESPONSIBLE REPRESENTATIVE IN CHARGE OF EROSION CONTROL AND MAINTENANCE OF ALL EROSION CONTROL AND STORMWATER POLLUTION PREVENTION FACILITIES.

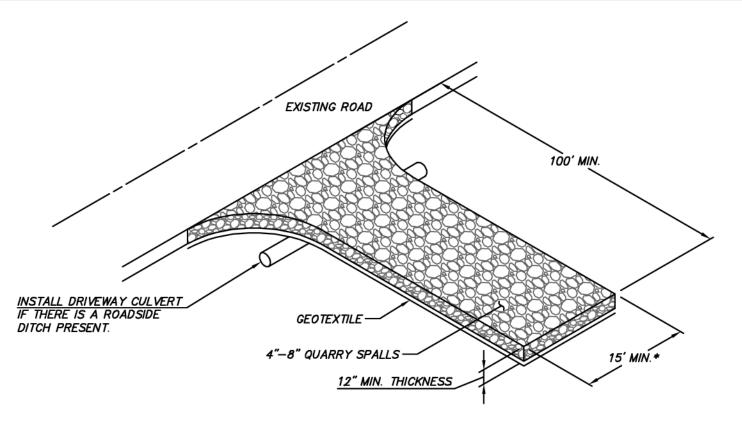

DRIVEWAY SHALL MEET THE REQUIREMENTS OF THE CITY OF CLE ELUM IT IS RECOMMENDED THAT THE ENTRANCE BE CROWNED SO THAT RUNOFF DRAINS OFF THE PAD


STABILIZED CONSTRUCTION ENTRANCE

(NOT TO SCALE)

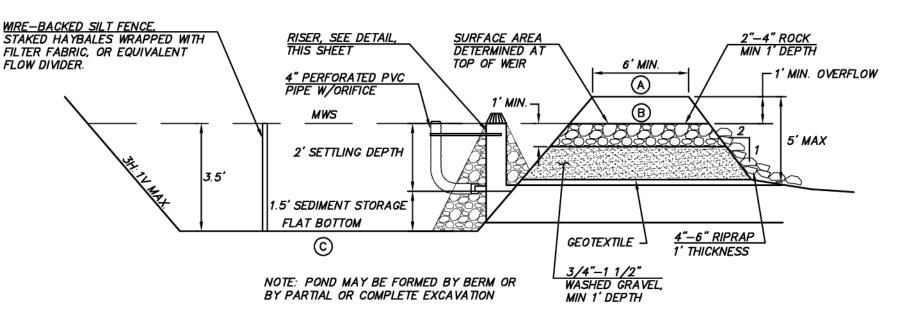


TEMPORARY SEDIMENT POND

(NOT TO SCALE)

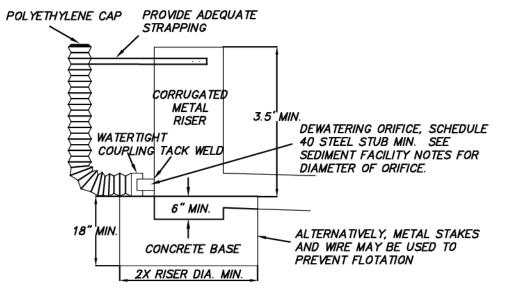


TEMPORARY SEDIMENT POND RISER (NOT TO SCALE)

L = THE DISTANCE SUCH THAT POINTS A AND B ARE OF EQUAL ELEVATION

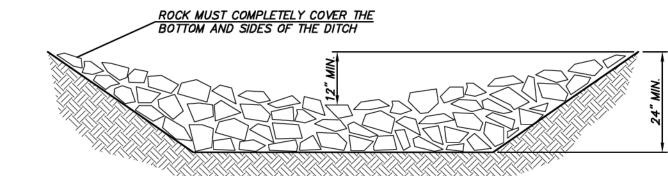


ROCK CHECK DAM

(NOT TO SCALE)

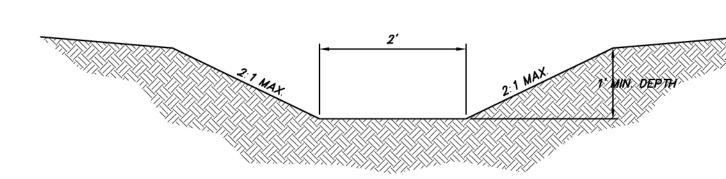

INTERCEPTOR TRENCH

(NOT TO SCALE)

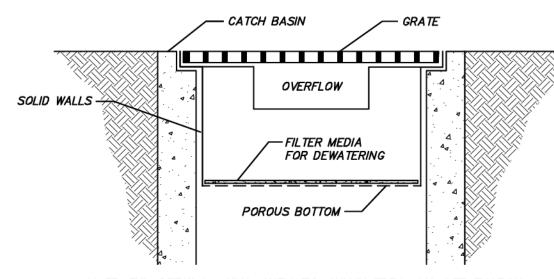

NOTE: THIS DETAIL IS ONLY SCHEMATIC. ANY INSERT IS ALLOWED THAT HAS A MIN. 0.5 C.F. OF STORAGE, THE MEANS TO DEWATER THE STORED SEDIMENT, AN OVERFLOW, AND CAN BE EASILY MAINTAINED.

CATCH BASIN INSERT

(NOT TO SCALE)

SEDIMENT POI NOTES	V <i>D</i>
SEDIMENT POND 1 MAX TRIBUTARY AREA 2-YEAR FLOW APPROX DIMENSION AT W.S. REQUIRED POND SURFACE AREA PROVIDED POND SURFACE AREA DEWATERING ORIFICE DIA	7.33 AC 3.81 CFS 168'x50' 7,925 SF 8,400 SF 3–3/4 IN
SEDIMENT POND 2 MAX TRIBUTARY AREA 2—YEAR FLOW APPROX DIMENSION AT W.S. REQUIRED POND SURFACE AREA PROVIDED POND SURFACE AREA DEWATERING ORIFICE DIA	8.60 AC 4.40 CFS 230'x50' 9,152 SF 11,427 SF 4-3/8 IN

SEDIMENT POND ELEVATION TABLE				
POND	A	B	0	
1	2012.0	2011.0	2007.5	
2	2031.0	2030.0	2026.5	
NOTE: RISER AND DEWATERING DEVICE PER DOE SWMMEW FIGURE 7.32.				

EXISTING UTILITY NOTE

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BLUELINE

25 CENTRAL WAY, SUITE 400, KIRKLAND, WA 98033 P: 425.216.4051 F: 425.216.4052 WWW.THEBLUELINEGROUP.COM

AS NOTED PROJECT MANAGER:

PROJECT ENGINEER: LYNDSEY FEDAK, PE CHRIS WISCOMB

BRETT K. PUDISTS, PE

ISSUE DATE.

11/15/2021


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19-349 SHEET NAME: TD-01

> 8 of **48**



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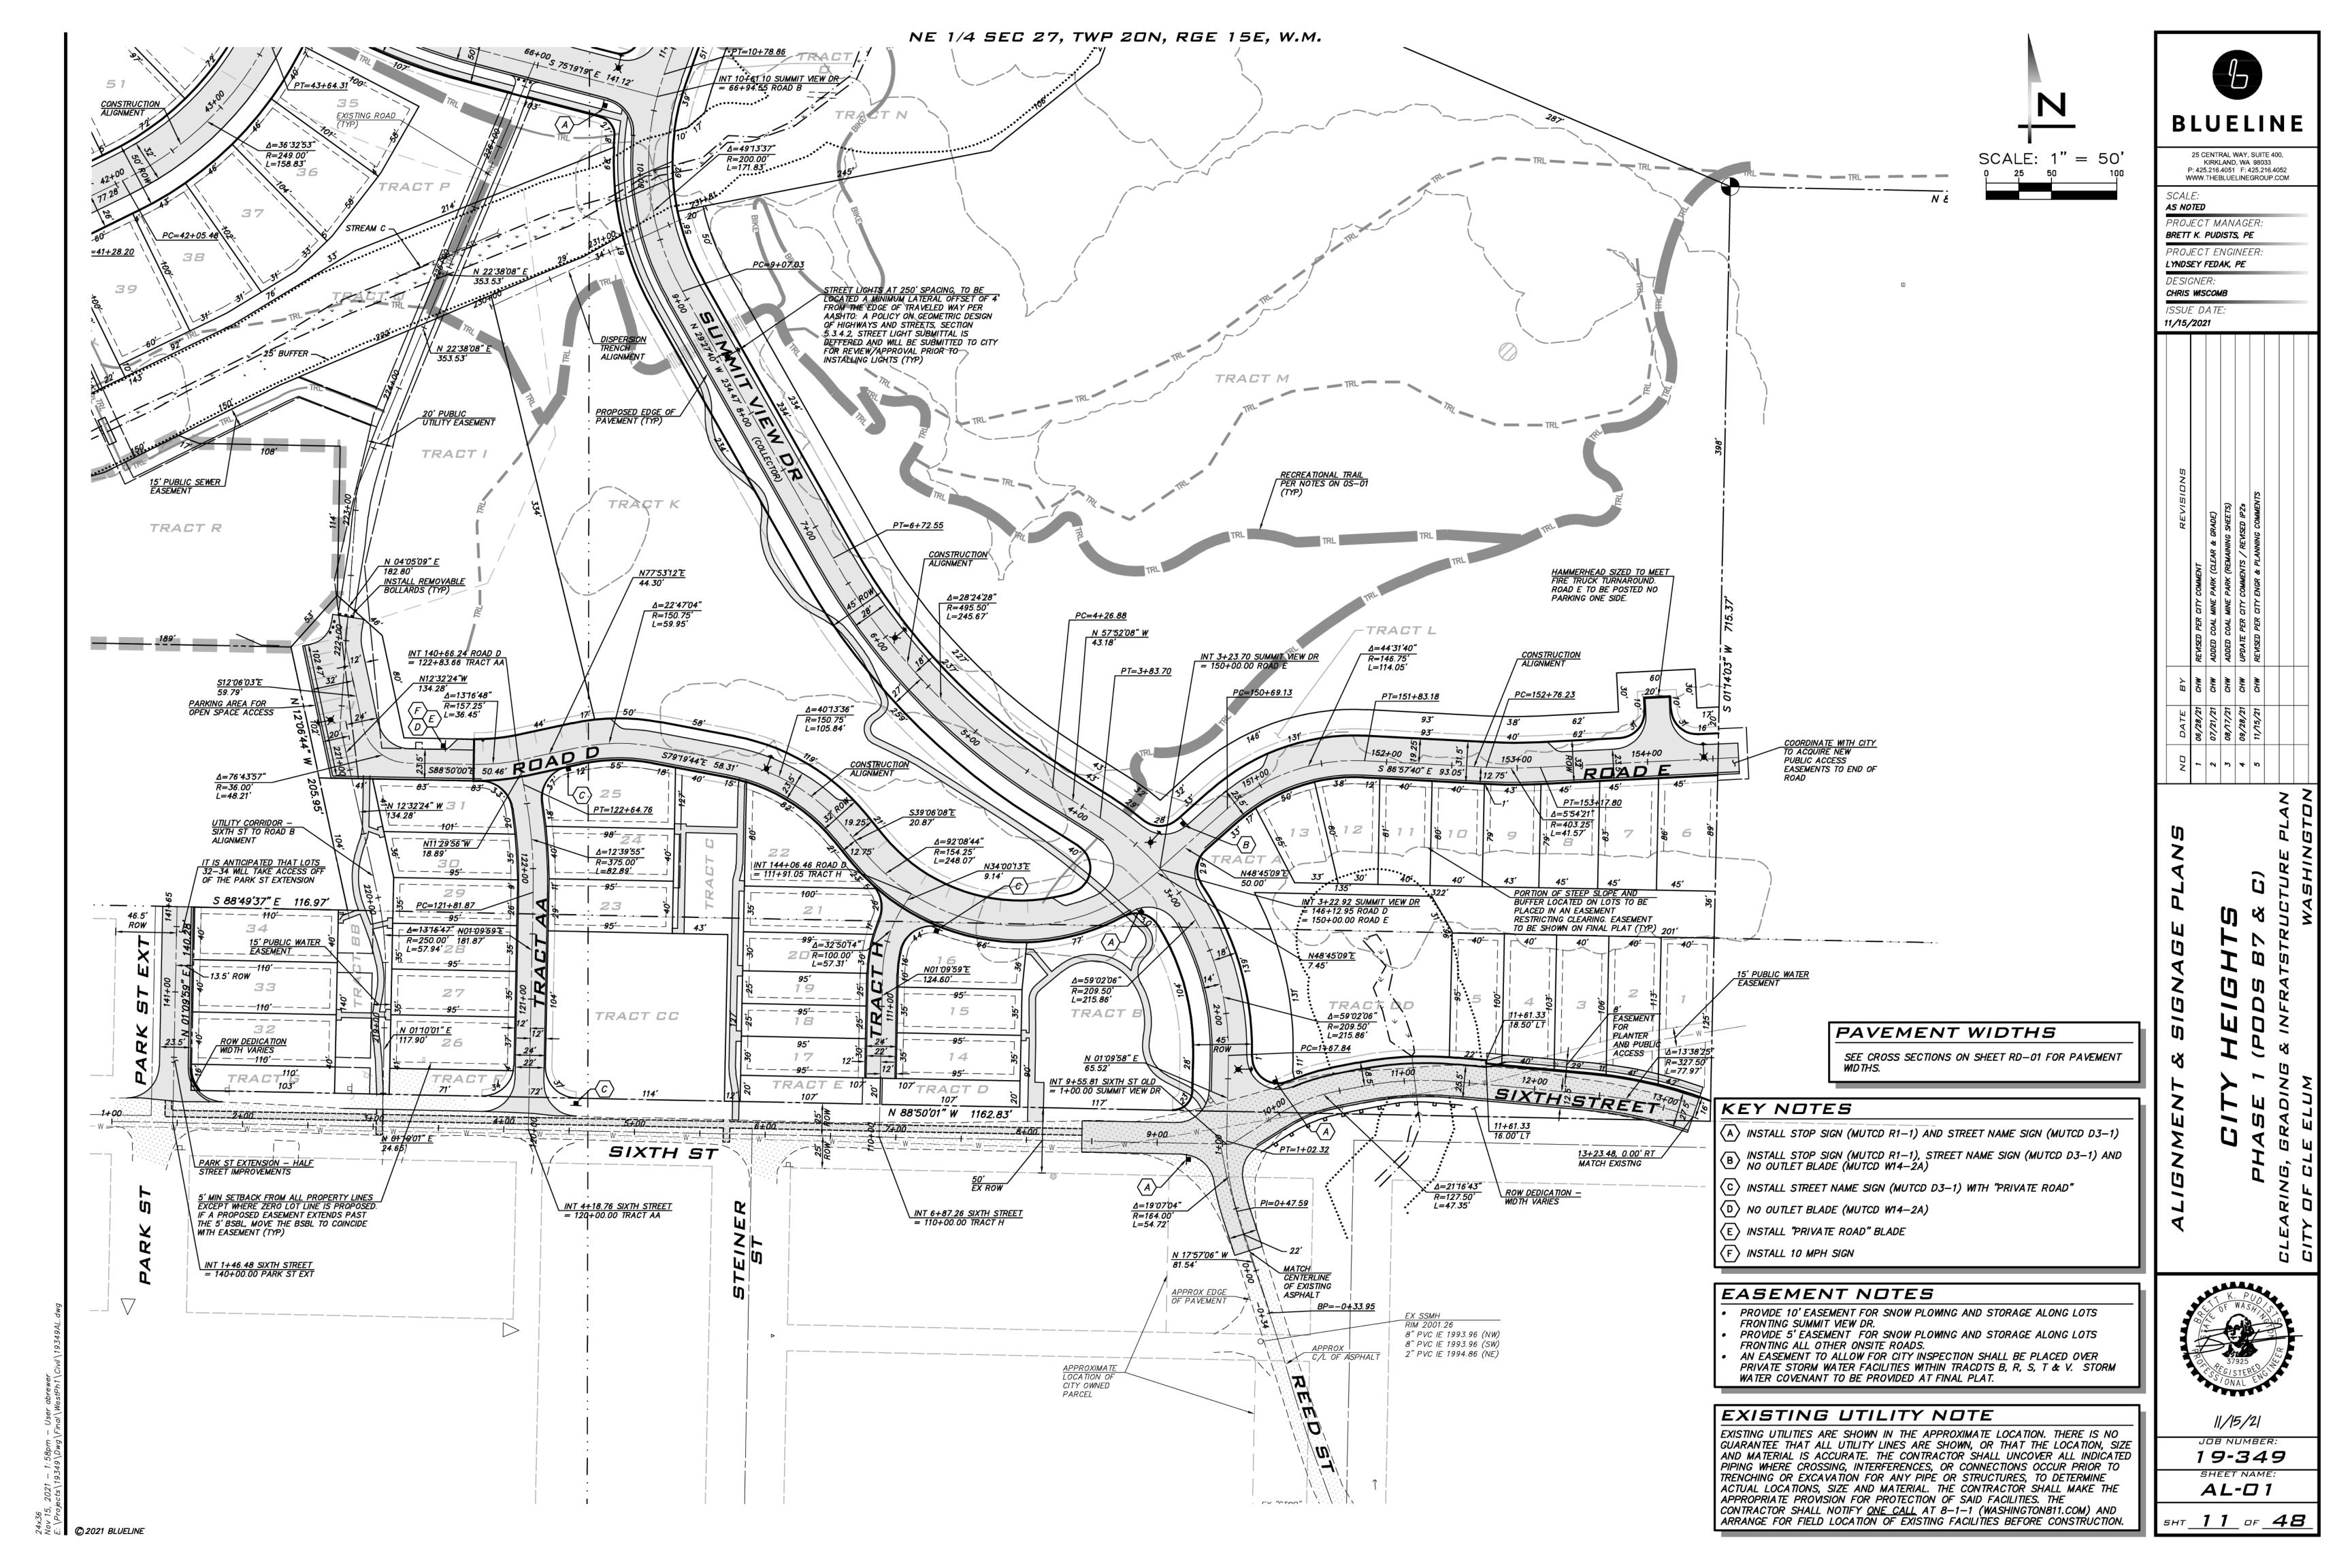
WWW.THEBLUELINEGROUP.COM


PROJECT MANAGER. BRETT K. PUDISTS, PE

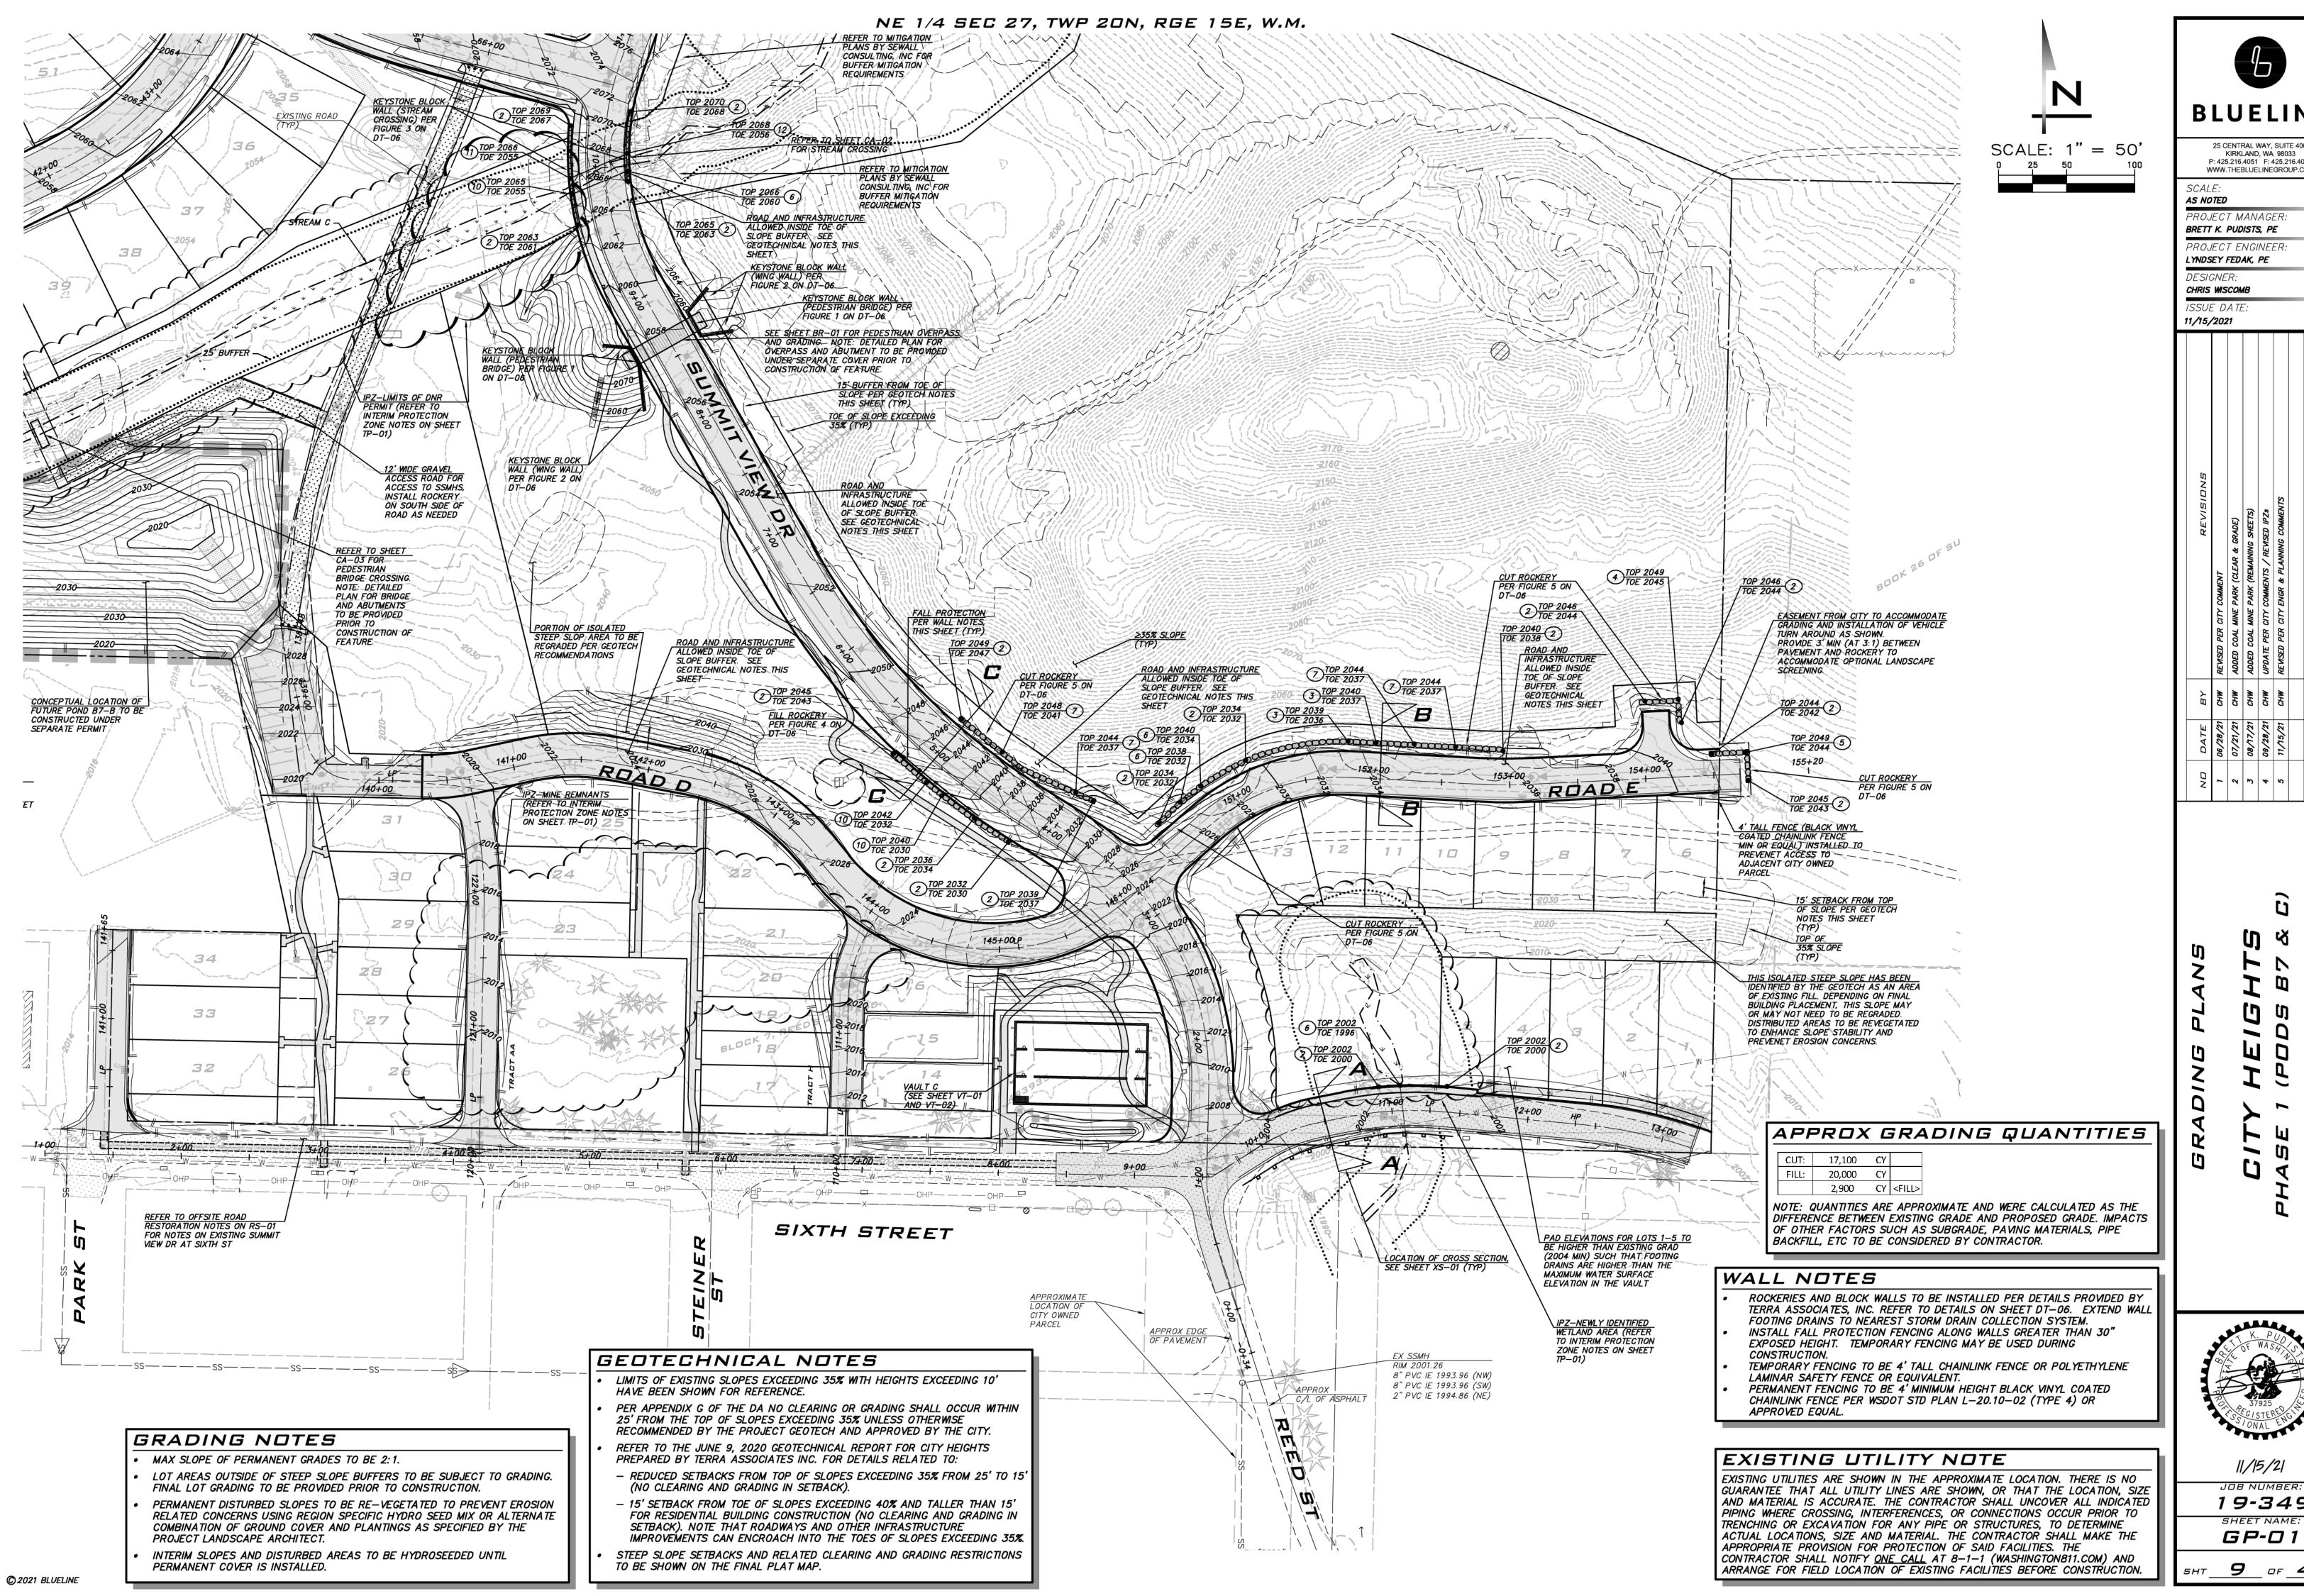
19-349

<u>9</u> of <u>48</u>

^{*}ໄຂື່ພ່**ີ ©2021 BLUELINE**



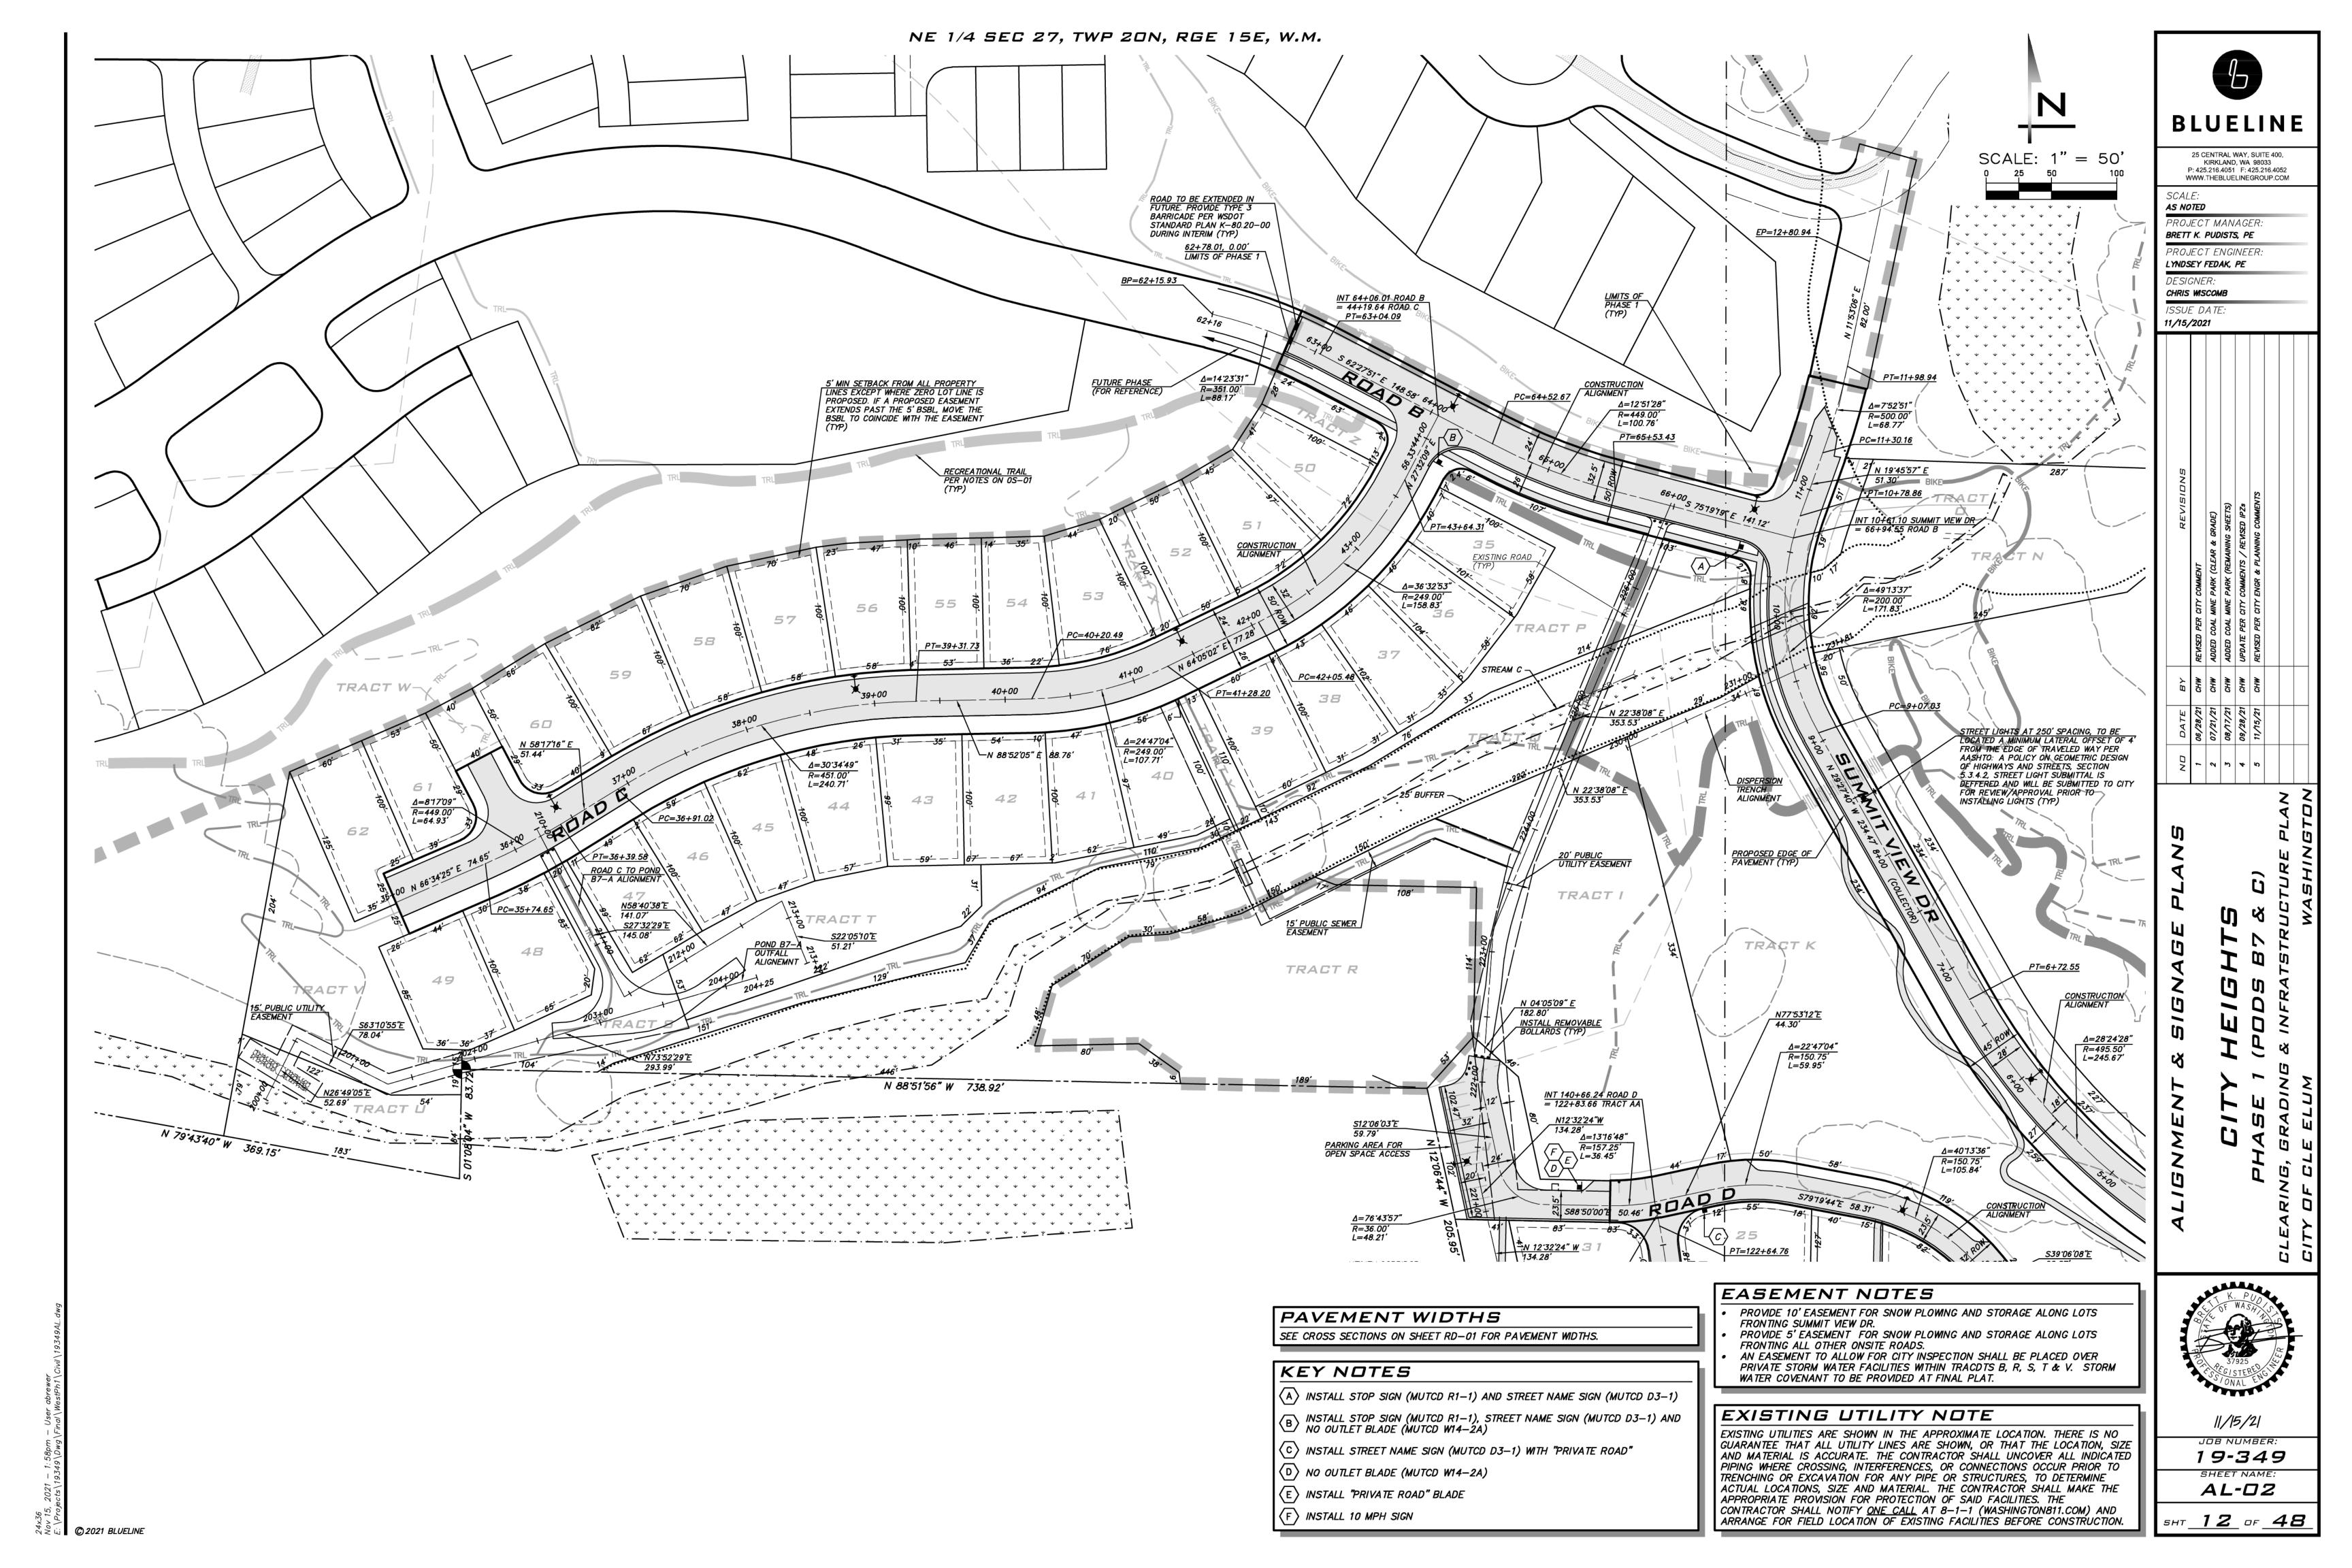

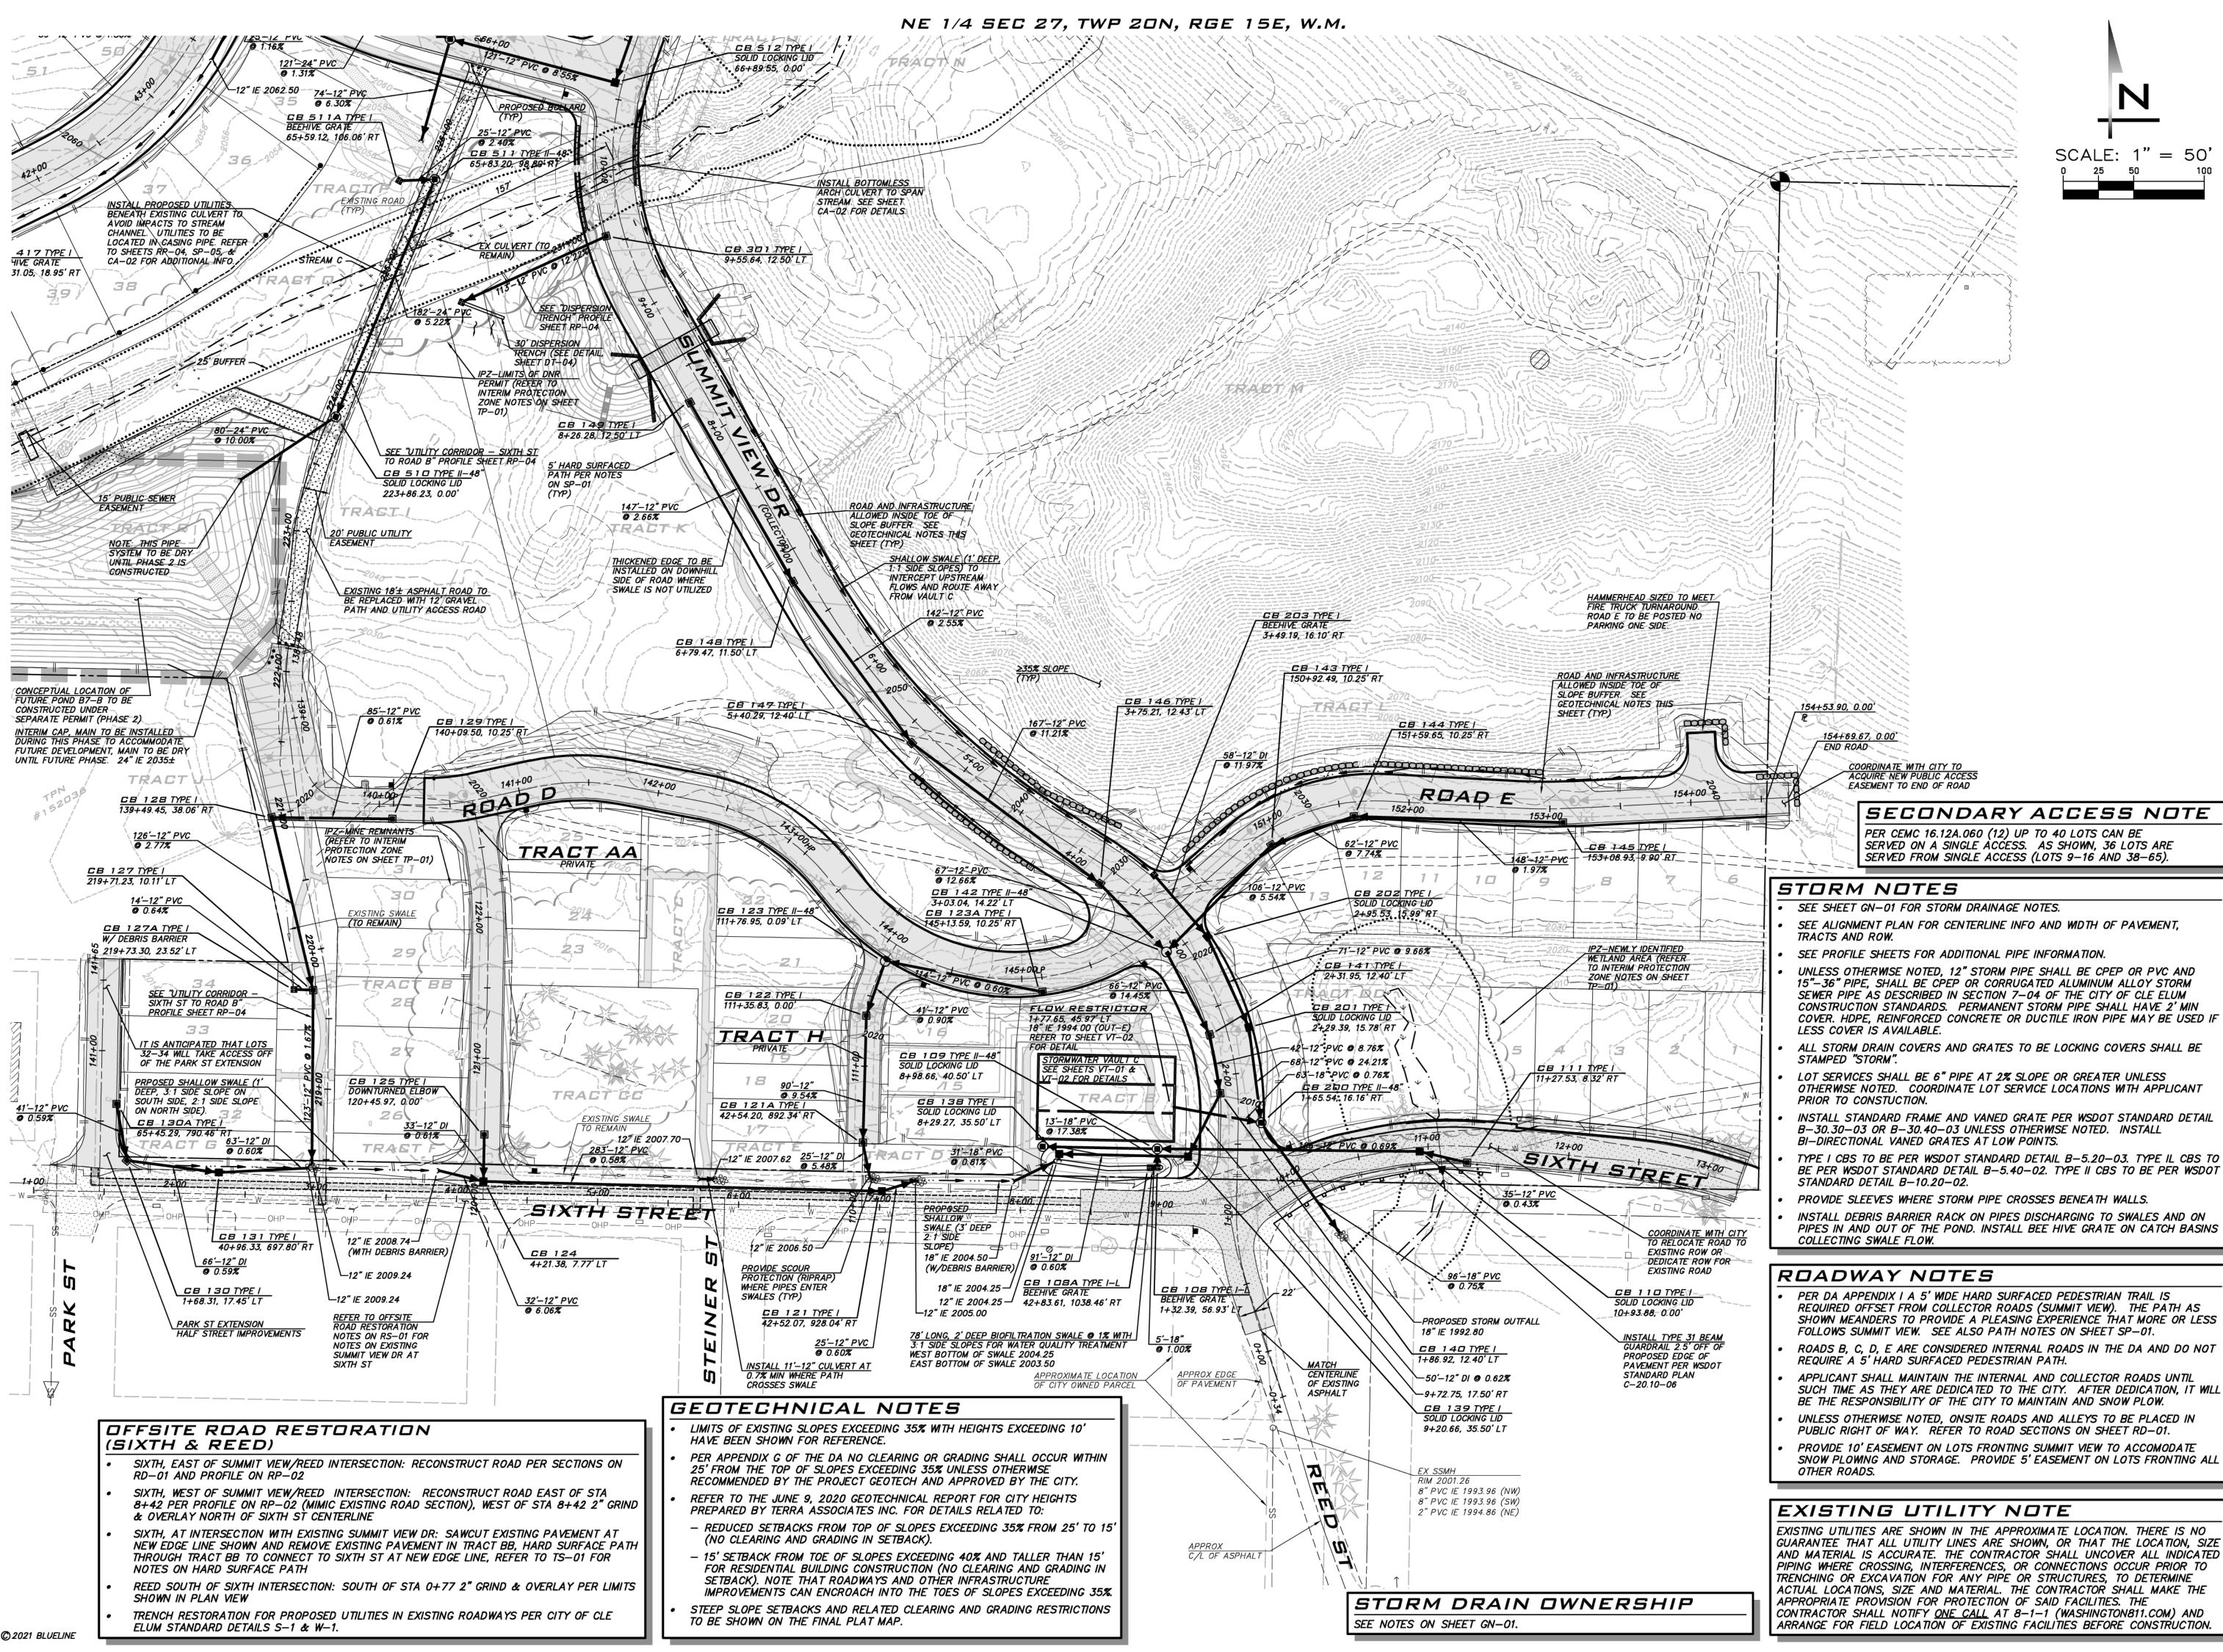

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25 CENTRAL WAY, SUITE 400, KIRKLAND, WA 98033 P: 425.216.4051 F: 425.216.4052

WWW.THEBLUELINEGROUP.COM AS NOTED

PROJECT MANAGER Brett K. Pudists, Pe

PROJECT ENGINEER. LYNDSEY FEDAK, PE DESIGNER:

CHRIS WISCOMB

11/15/2021

SERVED ON A SINGLE ACCESS. AS SHOWN, 36 LOTS ARE SERVED FROM SINGLE ACCESS (LOTS 9-16 AND 38-65).

SEE ALIGNMENT PLAN FOR CENTERLINE INFO AND WIDTH OF PAVEMENT,

SEE PROFILE SHEETS FOR ADDITIONAL PIPE INFORMATION.

UNLESS OTHERWISE NOTED, 12" STORM PIPE SHALL BE CPEP OR PVC AND 15"-36" PIPE, SHALL BE CPEP OR CORRUGATED ALUMINUM ALLOY STORM SEWER PIPE AS DESCRIBED IN SECTION 7-04 OF THE CITY OF CLE ELUM CONSTRUCTION STANDARDS. PERMANENT STORM PIPE SHALL HAVE 2' MIN COVER. HDPE, REINFORCED CONCRETE OR DUCTILE IRON PIPE MAY BE USED IF

ALL STORM DRAIN COVERS AND GRATES TO BE LOCKING COVERS SHALL BE

LOT SERVICES SHALL BE 6" PIPE AT 2% SLOPE OR GREATER UNLESS OTHERWISE NOTED. COORDINATE LOT SERVICE LOCATIONS WITH APPLICANT

INSTALL STANDARD FRAME AND VANED GRATE PER WSDOT STANDARD DETAIL B-30.30-03 OR B-30.40-03 UNLESS OTHERWISE NOTED. INSTALL

TYPE I CBS TO BE PER WSDOT STANDARD DETAIL B-5.20-03. TYPE IL CBS TO BE PER WSDOT STANDARD DETAIL B-5.40-02. TYPE II CBS TO BE PER WSDOT

INSTALL DEBRIS BARRIER RACK ON PIPES DISCHARGING TO SWALES AND ON PIPES IN AND OUT OF THE POND. INSTALL BEE HIVE GRATE ON CATCH BASINS

- PER DA APPENDIX I A 5' WIDE HARD SURFACED PEDESTRIAN TRAIL IS REQUIRED OFFSET FROM COLLECTOR ROADS (SUMMIT VIEW). THE PATH AS SHOWN MEANDERS TO PROVIDE A PLEASING EXPERIENCE THAT MORE OR LESS FOLLOWS SUMMIT VIEW. SEE ALSO PATH NOTES ON SHEET SP-01.
- ROADS B, C, D, E ARE CONSIDERED INTERNAL ROADS IN THE DA AND DO NOT
- APPLICANT SHALL MAINTAIN THE INTERNAL AND COLLECTOR ROADS UNTIL SUCH TIME AS THEY ARE DEDICATED TO THE CITY. AFTER DEDICATION, IT WILL BE THE RESPONSIBILITY OF THE CITY TO MAINTAIN AND SNOW PLOW.
- UNLESS OTHERWISE NOTED, ONSITE ROADS AND ALLEYS TO BE PLACED IN PUBLIC RIGHT OF WAY. REFER TO ROAD SECTIONS ON SHEET RD-01. PROVIDE 10' EASEMENT ON LOTS FRONTING SUMMIT VIEW TO ACCOMODATE


EXISTING UTILITIES ARE SHOWN IN THE APPROXIMATE LOCATION. THERE IS NO GUARANTEE THAT ALL UTILITY LINES ARE SHOWN, OR THAT THE LOCATION, SIZE AND MATERIAL IS ACCURATE. THE CONTRACTOR SHALL UNCOVER ALL INDICATED PIPING WHERE CROSSING, INTERFERENCES, OR CONNECTIONS OCCUR PRIOR TO TRENCHING OR EXCAVATION FOR ANY PIPE OR STRUCTURES, TO DETERMINE ACTUAL LOCATIONS, SIZE AND MATERIAL. THE CONTRACTOR SHALL MAKE THE APPROPRIATE PROVISION FOR PROTECTION OF SAID FACILITIES. THE CONTRACTOR SHALL NOTIFY ONE CALL AT 8-1-1 (WASHINGTON811.COM) AND ARRANGE FOR FIELD LOCATION OF EXISTING FACILITIES BEFORE CONSTRUCTION.




11/15/21

19-349 SHEET NAME: RS-01

sнт <u>13</u> ог <u>48</u>

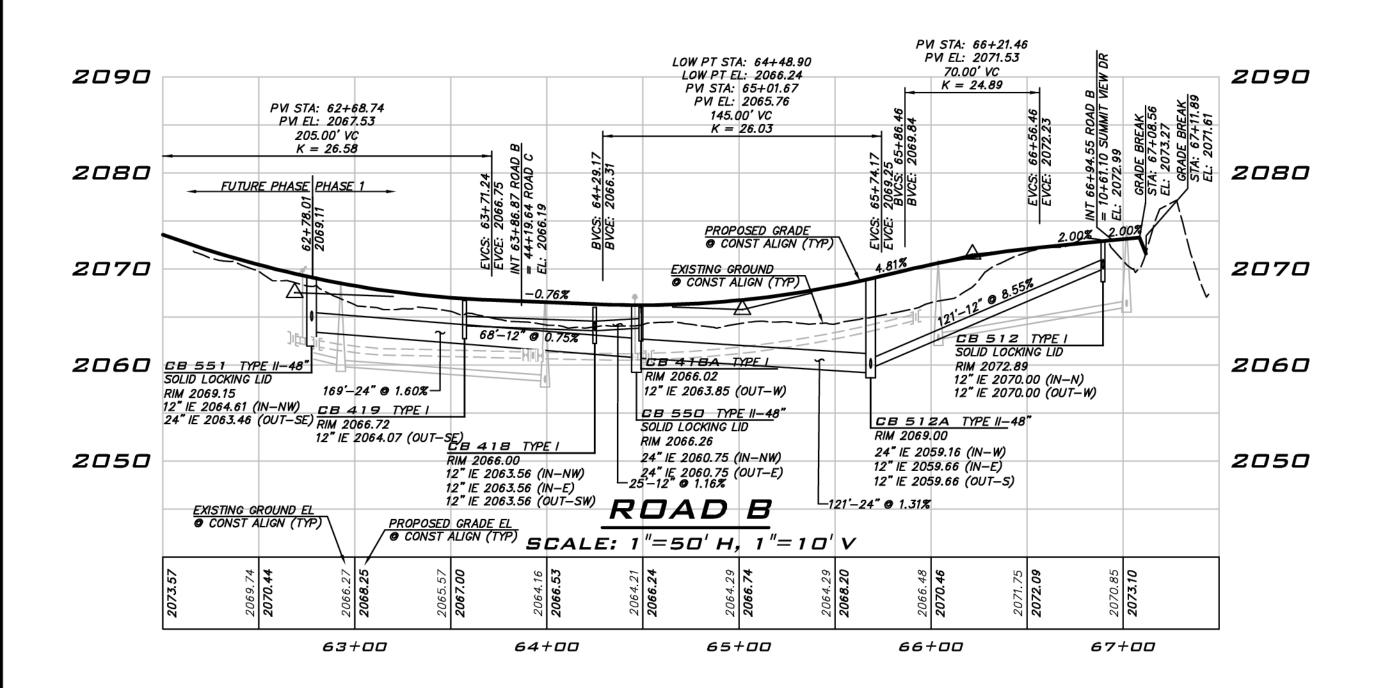

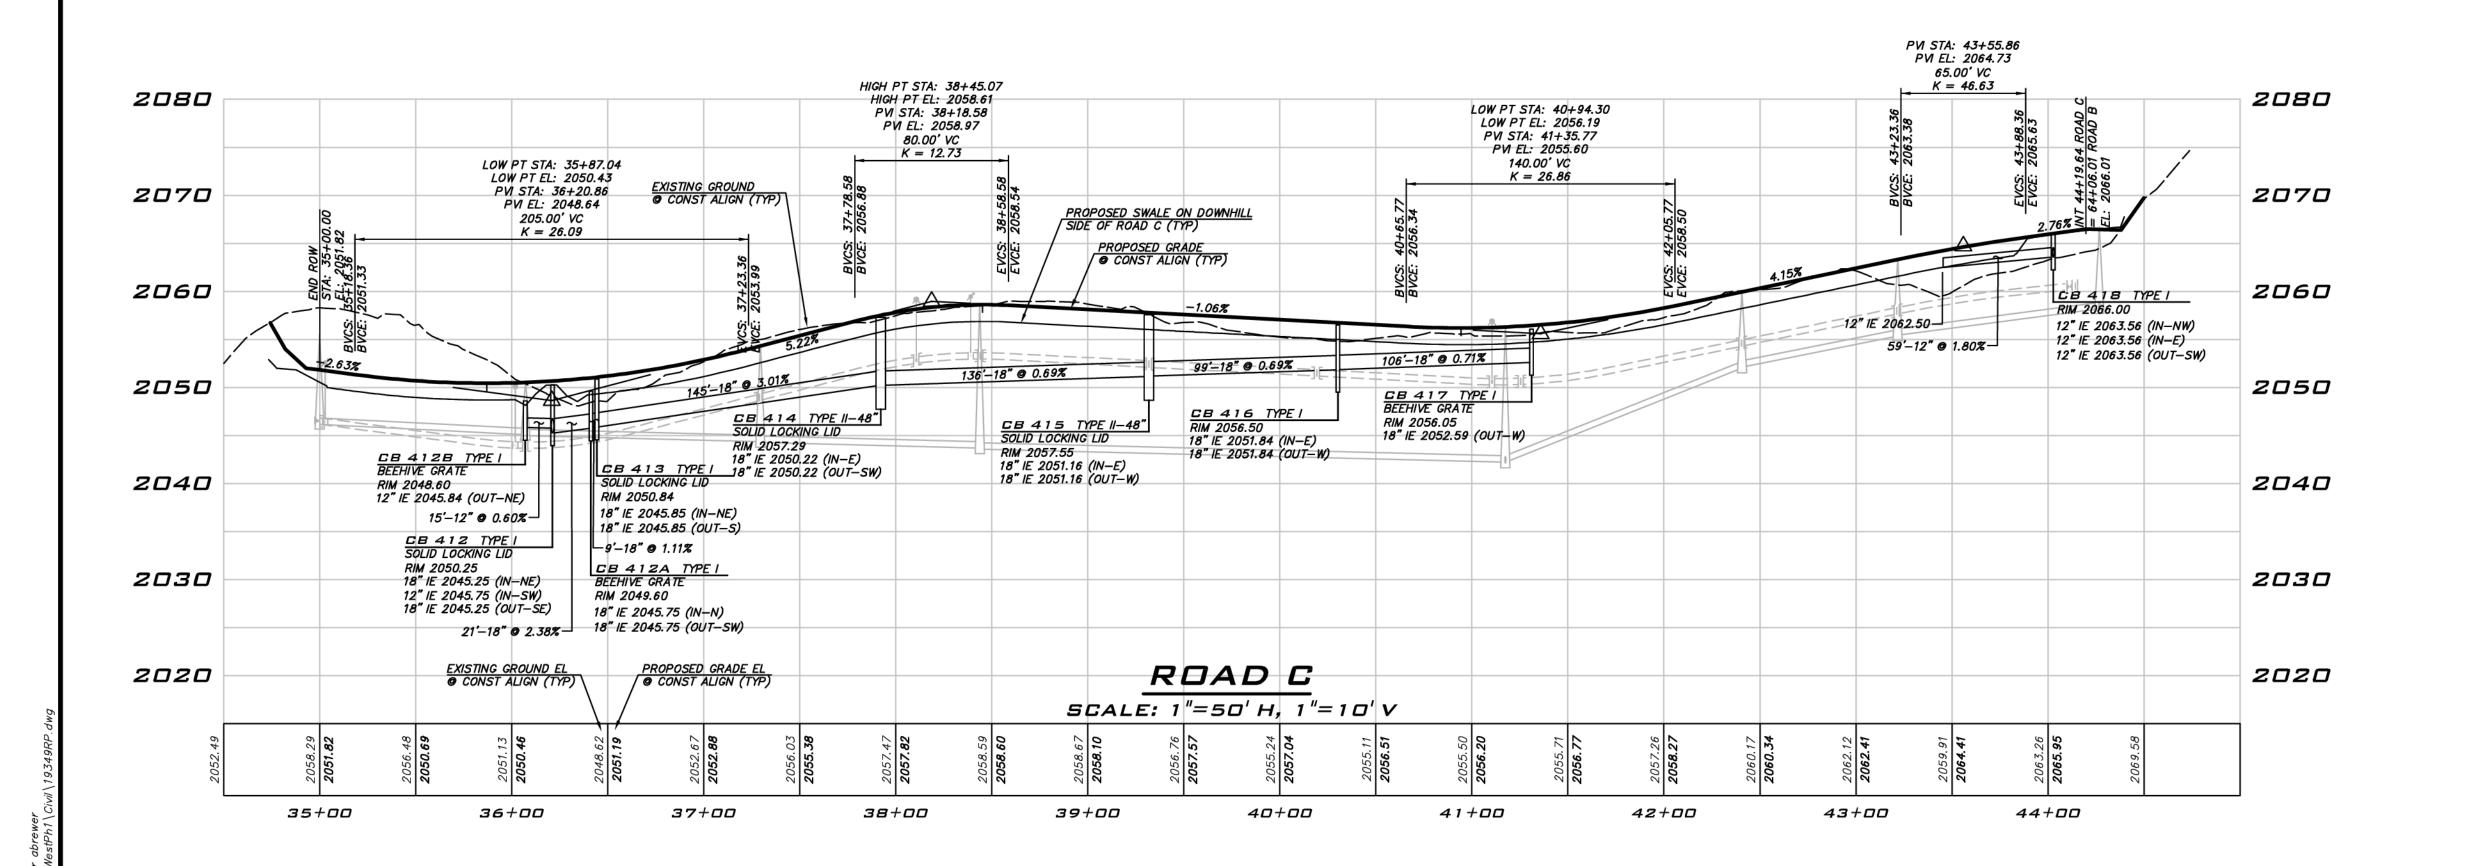



25 CENTRAL WAY, SUITE 400, KIRKLAND, WA 98033 P: 425.216.4051 F: 425.216.4052 WWW.THEBLUELINEGROUP.COM

SCALE: AS NOTED

PROJECT MANAGER: BRETT K. PUDISTS, PE

PROJECT ENGINEER: LYNDSEY FEDAK, PE

DESIGNER: CHRIS WISCOMB

ISSUE DATE: 11/15/2021

NOTES

ROADS ARE PUBLIC UNLESS OTHERWISE NOTED.

DESIGN SPEED FOR PROPOSED PUBLIC ROADS 25 MPH.

EXISTING UTILITY NOTE

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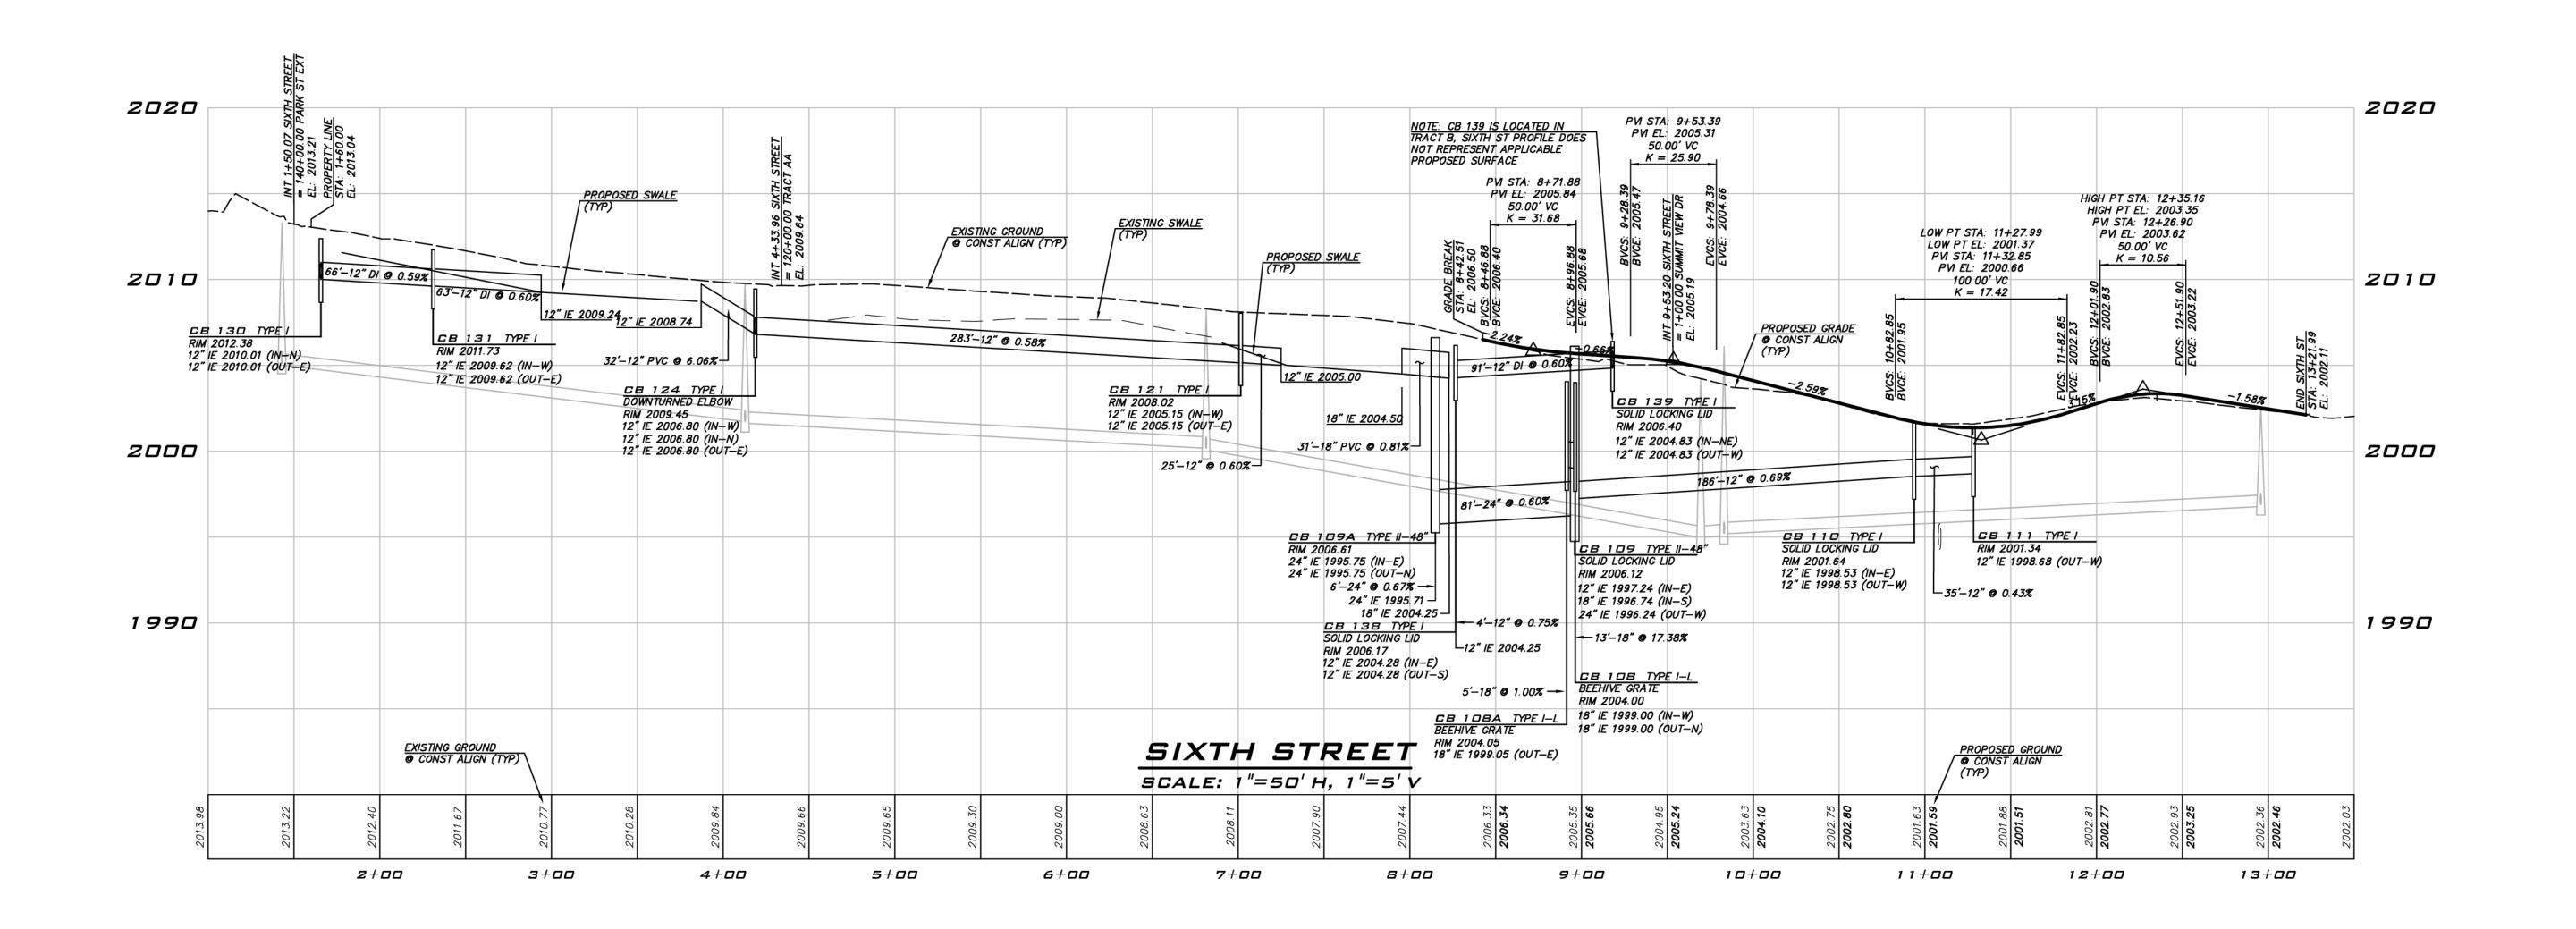
11/15/21


JOB NUMBER:

19-349 SHEET NAME: RP-01

sнт <u>15</u> оғ <u>48</u>

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145+00

146+00

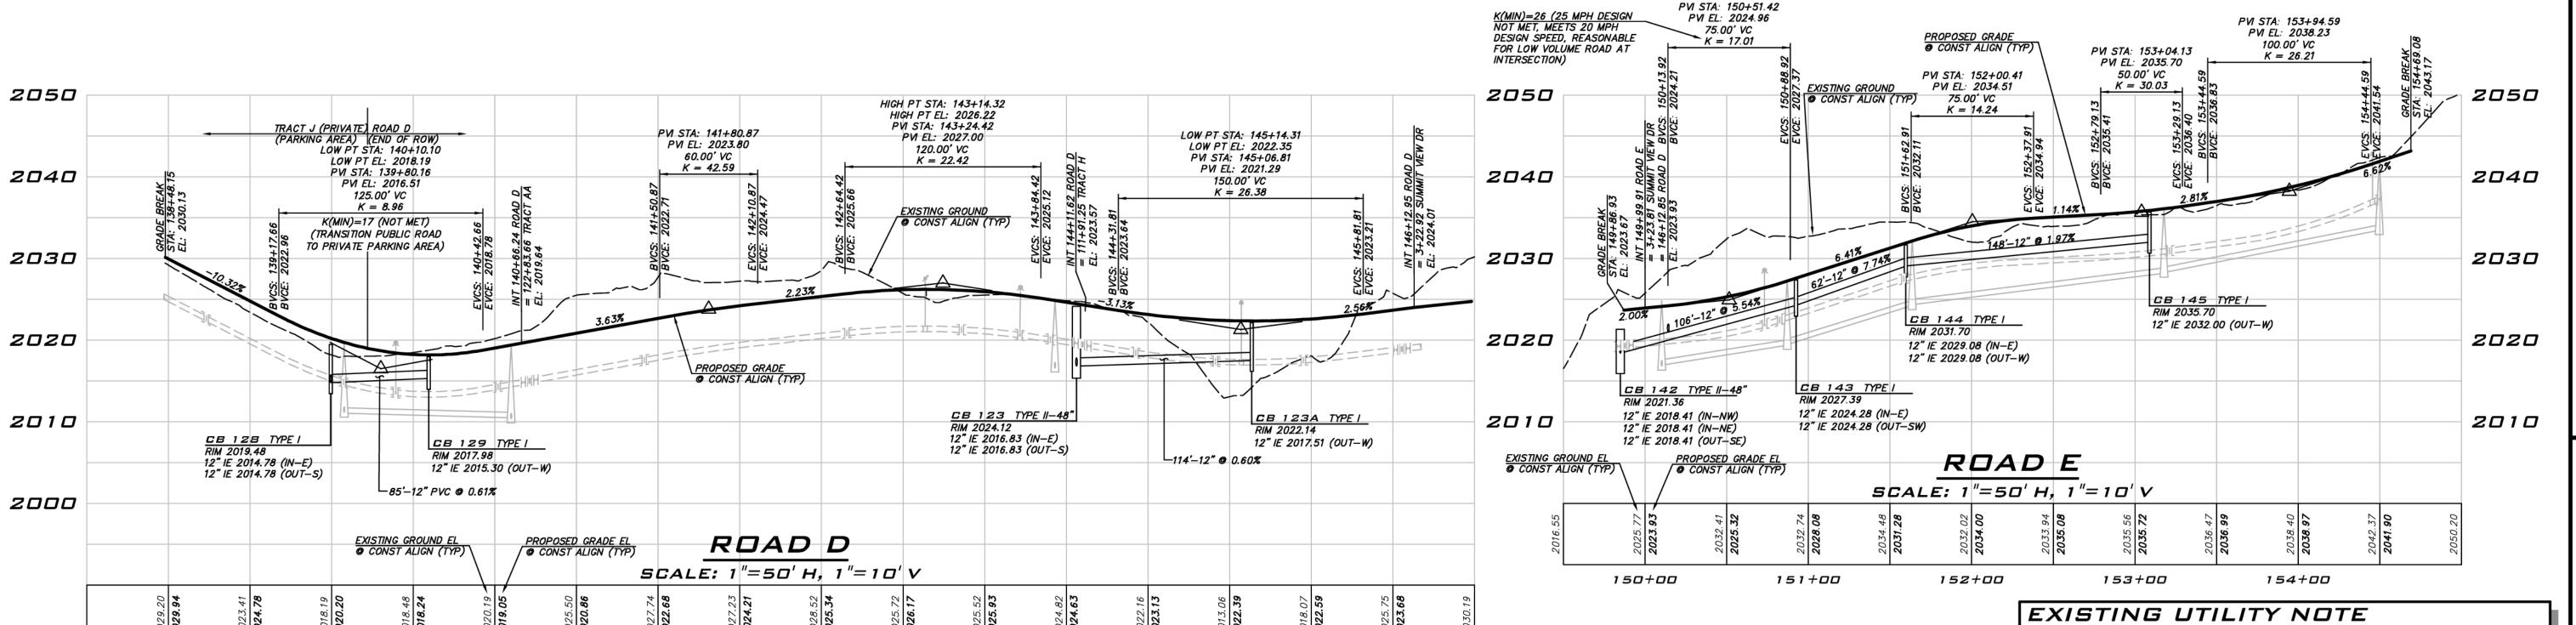NOTES

ROADS ARE PUBLIC UNLESS OTHERWISE NOTED.

DESIGN SPEED FOR PROPOSED PUBLIC ROADS 25 MPH. EXISTING ROAD

GRADES ALONG SIXTH ST MEET CRITERIA FOR 20 MPH DESIGN SPEED.

BLUELINE

25 CENTRAL WAY, SUITE 400, KIRKLAND, WA 98033 P: 425.216.4051 F: 425.216.4052


WWW.THEBLUELINEGROUP.COM SCALE: AS NOTED

PROJECT MANAGER: BRETT K. PUDISTS, PE PROJECT ENGINEER:

LYNDSEY FEDAK, PE DESIGNER: CHRIS WISCOMB

ISSUE DATE: 11/15/2021

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11/15/21
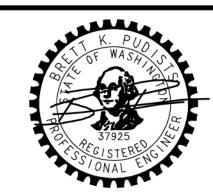
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AND MATERIAL IS ACCURATE. THE CONTRACTOR SHALL UNCOVER ALL INDICATED

PIPING WHERE CROSSING, INTERFERENCES, OR CONNECTIONS OCCUR PRIOR TO

ACTUAL LOCATIONS, SIZE AND MATERIAL. THE CONTRACTOR SHALL MAKE THE

CONTRACTOR SHALL NOTIFY ONE CALL AT 8-1-1 (WASHINGTON811.COM) AND

ARRANGE FOR FIELD LOCATION OF EXISTING FACILITIES BEFORE CONSTRUCTION.

TRENCHING OR EXCAVATION FOR ANY PIPE OR STRUCTURES, TO DETERMINE

APPROPRIATE PROVISION FOR PROTECTION OF SAID FACILITIES. THE

19-349 SHEET NAME: RP-02

sнт <u>16</u> ог <u>48</u>

139+00


140+00


141+00


142+00


143+00

144+00

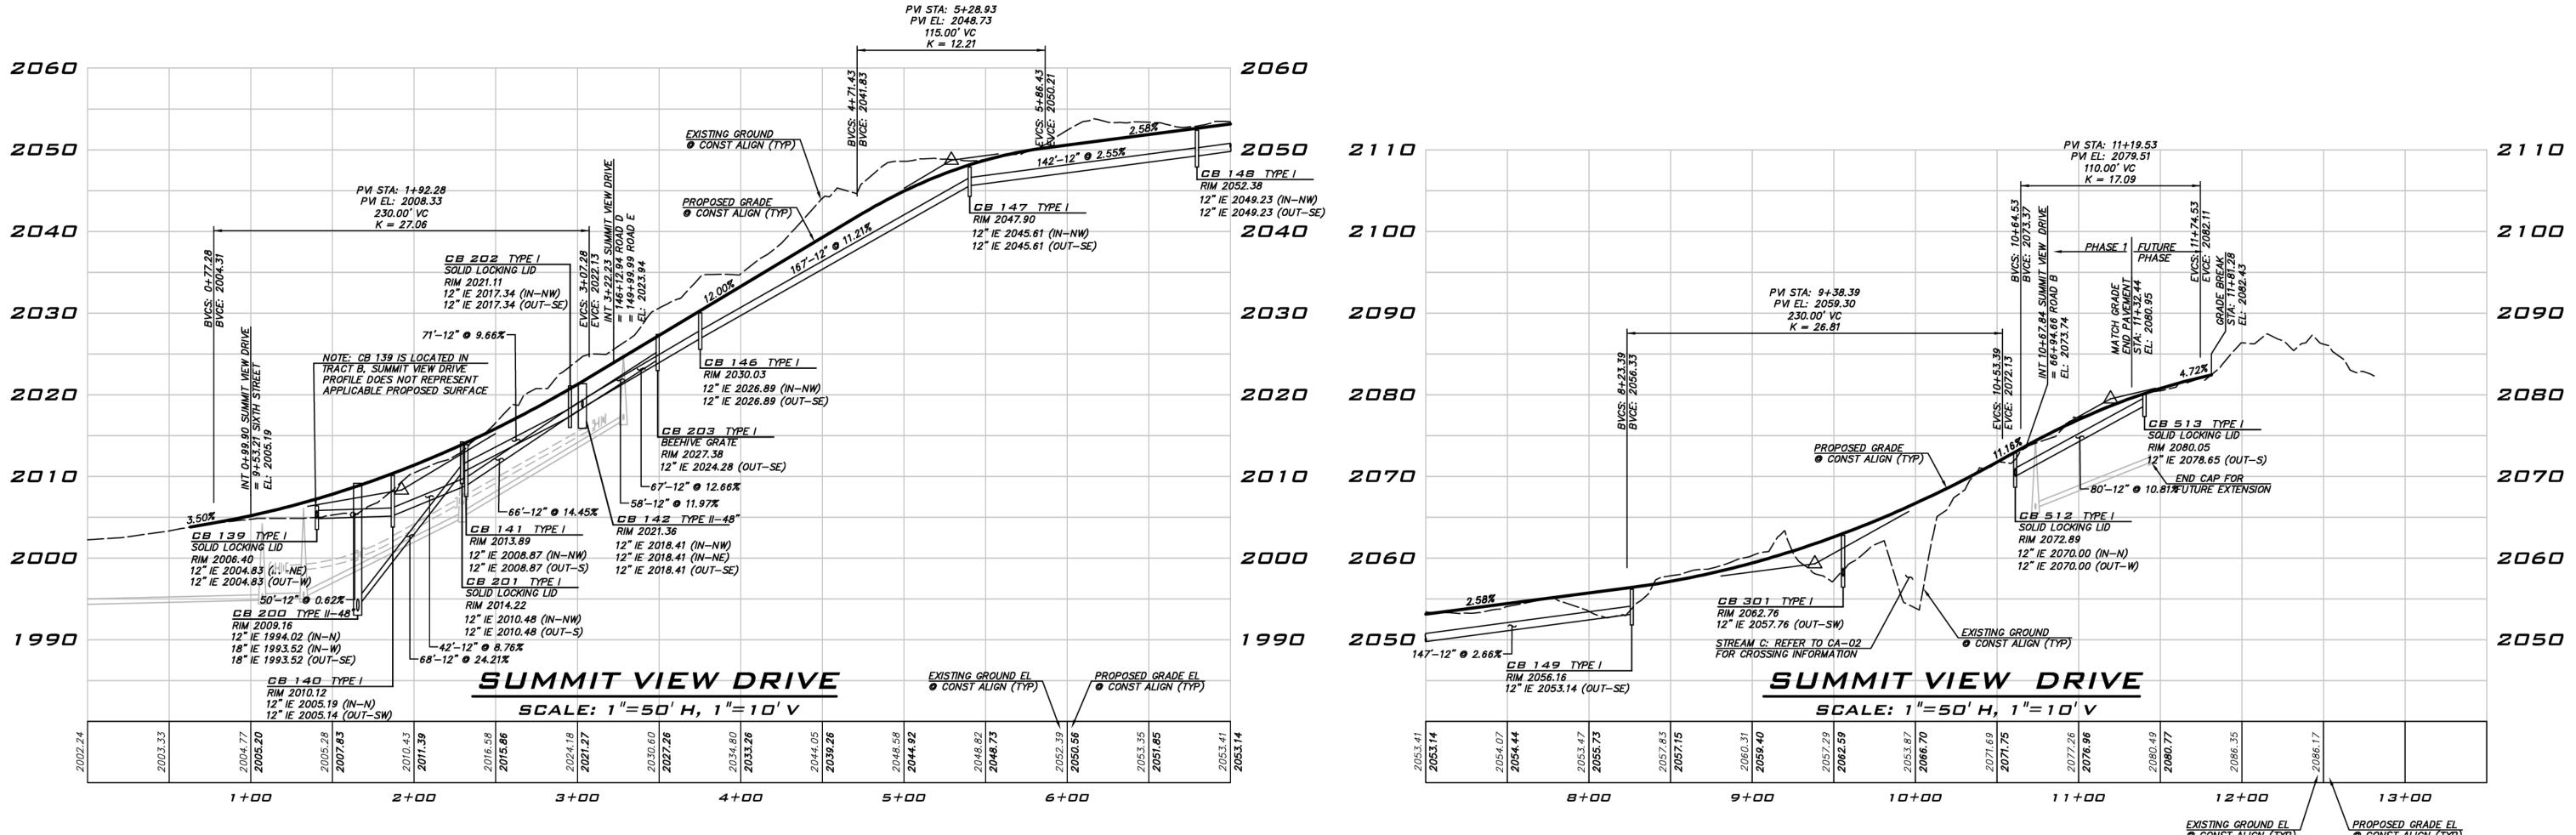

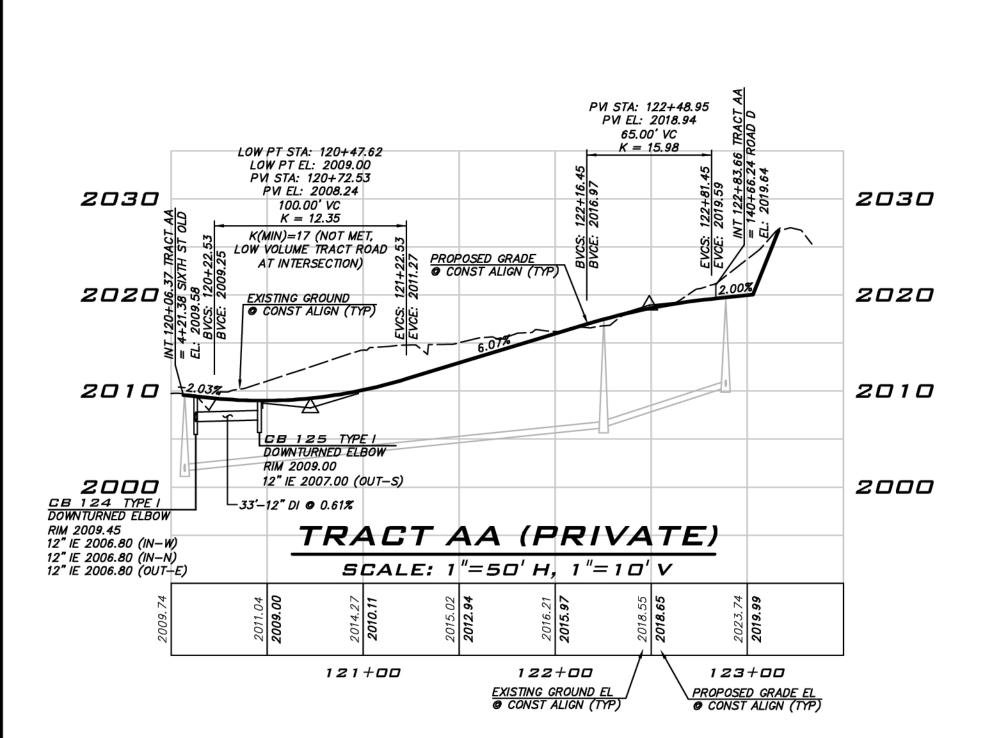

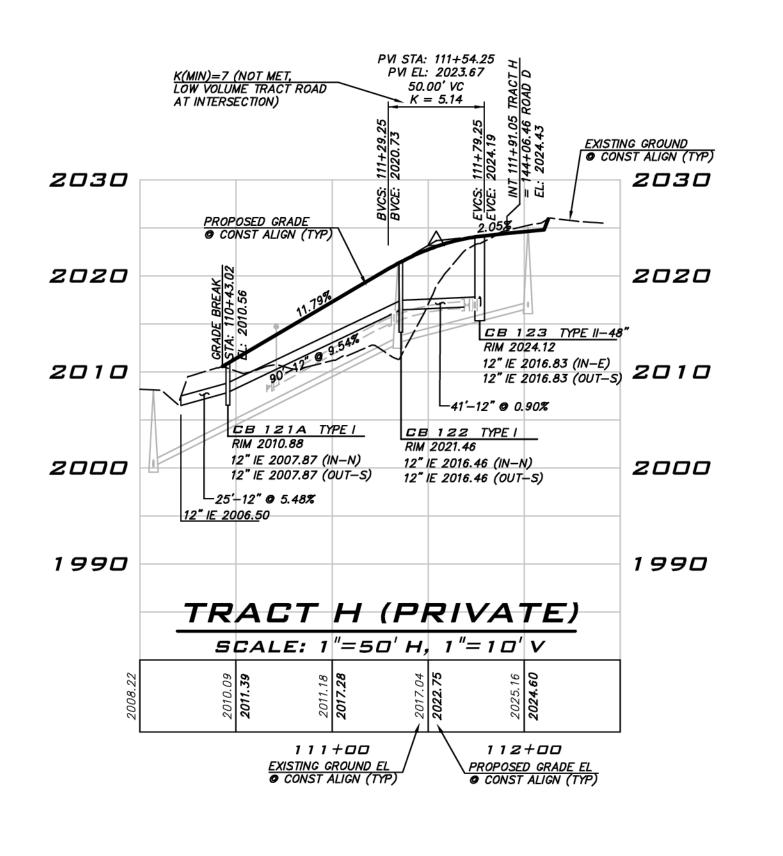

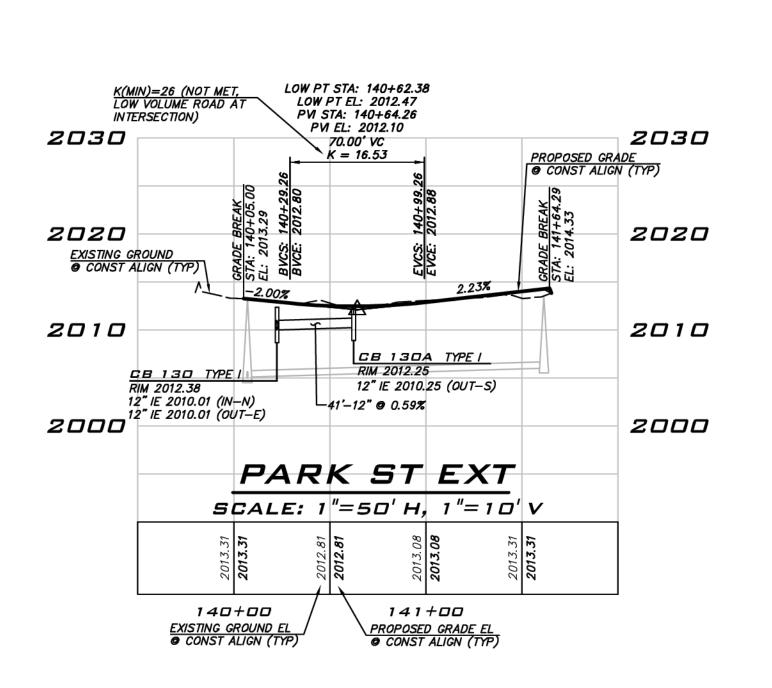

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EXISTING UTILITY NOTE

BLUELINE 25 CENTRAL WAY, SUITE 400, KIRKLAND, WA 98033 P: 425.216.4051 F: 425.216.4052 WWW.THEBLUELINEGROUP.COM AS NOTED PROJECT MANAGER: BRETT K. PUDISTS, PE PROJECT ENGINEER: LYNDSEY FEDAK, PE CHRIS WISCOMB 11/15/2021


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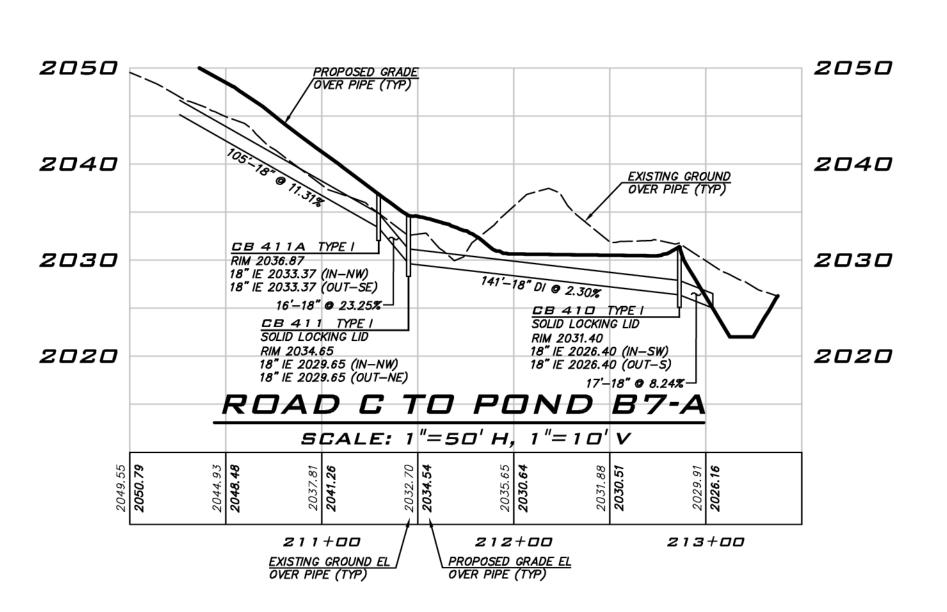
11/15/21


19-349 SHEET NAME: RP-03

sнт <u>17</u> ог <u>48</u>

ROADS ARE PUBLIC UNLESS OTHERWISE NOTED. DESIGN SPEED FOR PROPOSED PUBLIC ROADS 25 MPH.



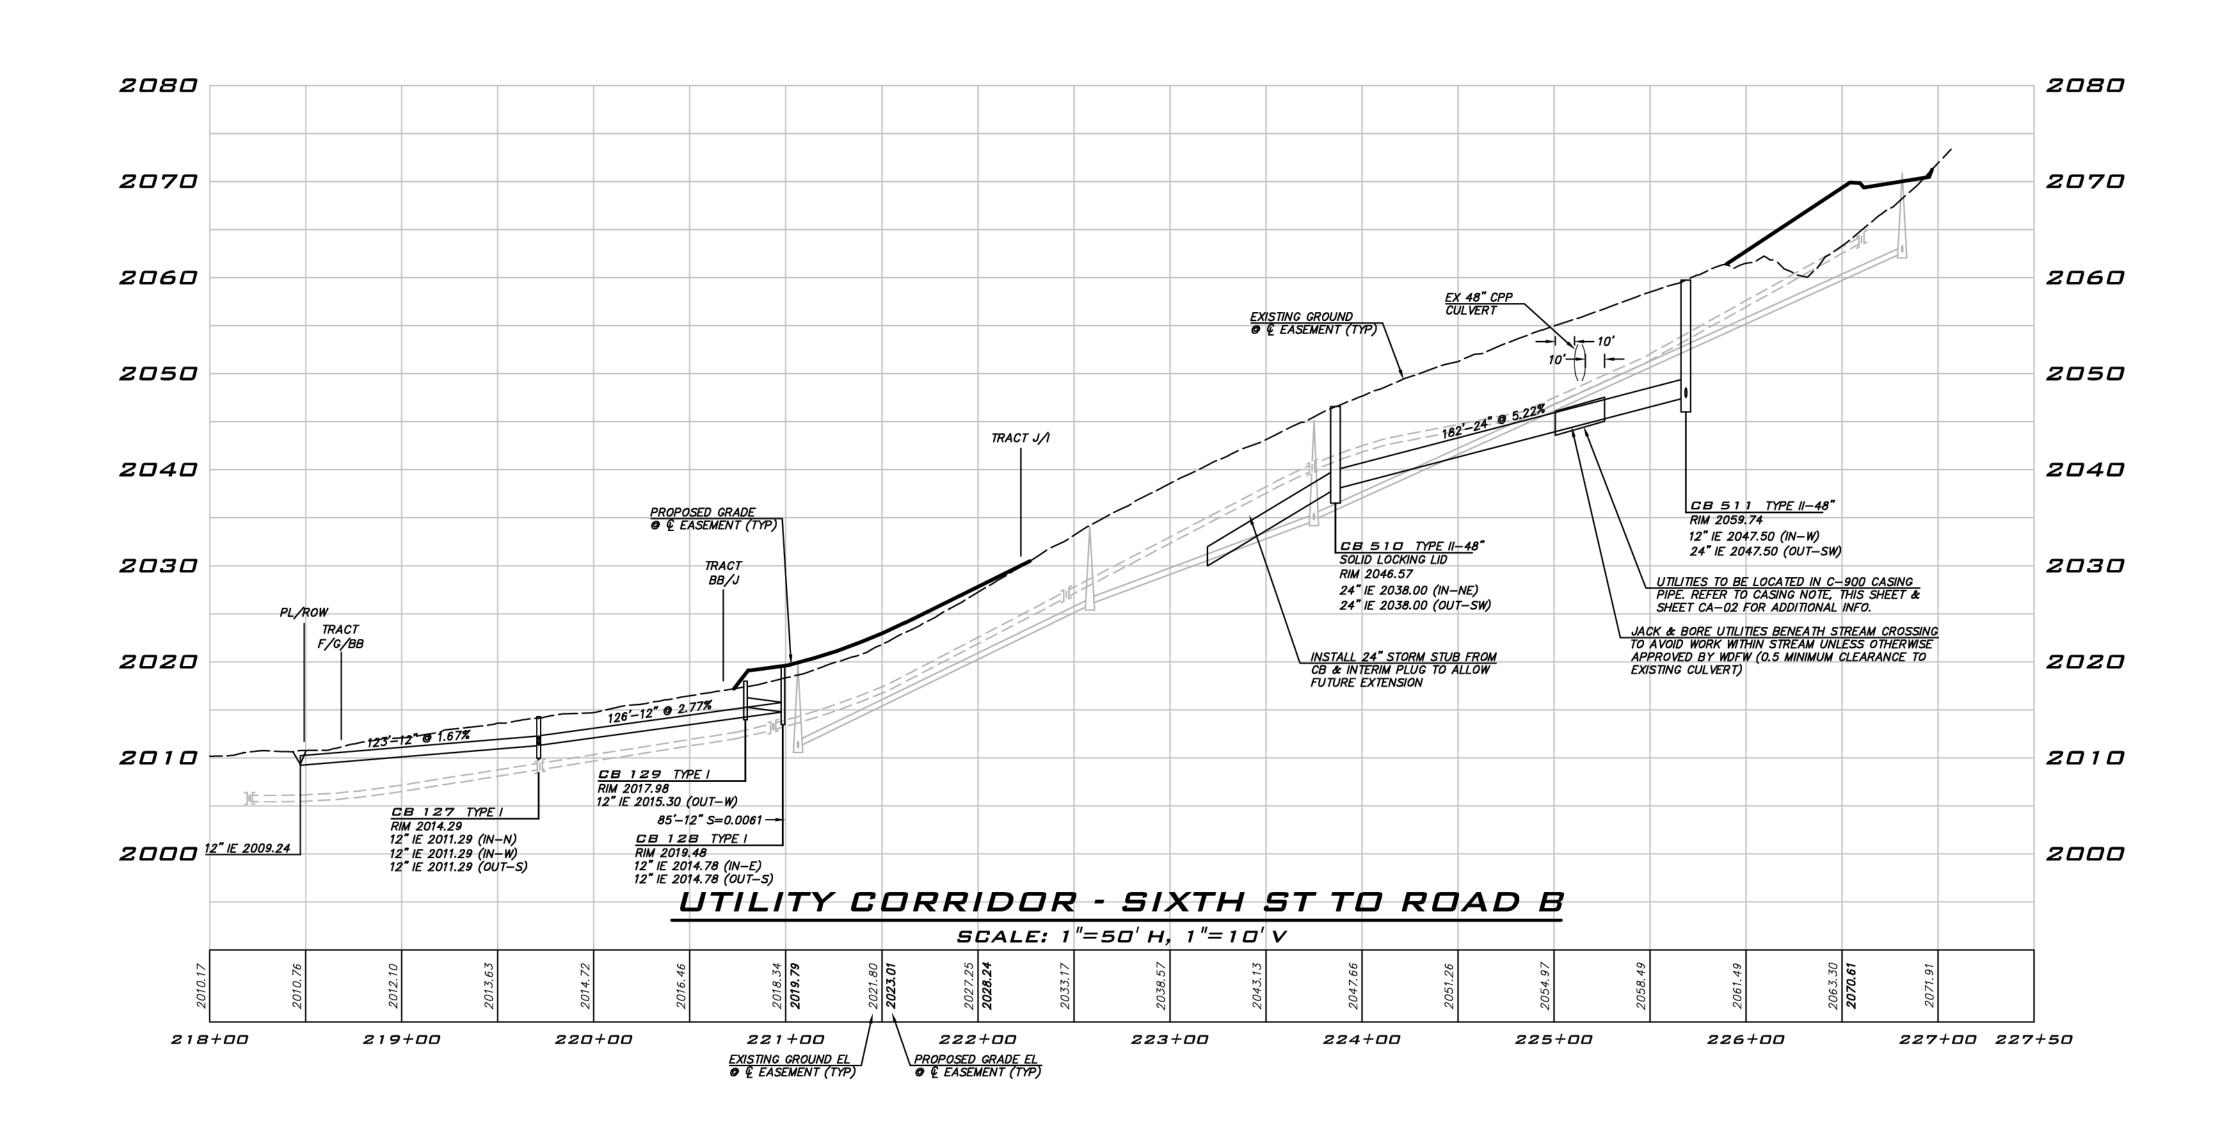

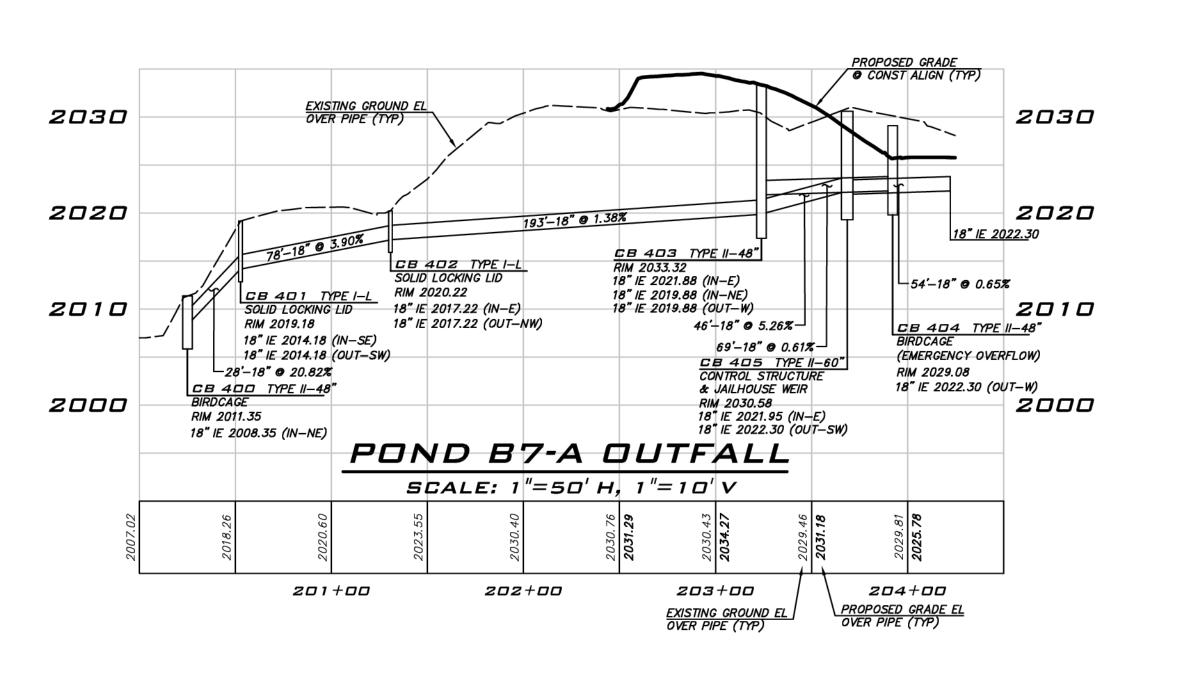

CASING NOTES

- C-900 CASING DIAMETER TO BE A MINIMUM OF 4" LARGER THAN THE CARRIER (SEWER/WATER/STORM) PIPE DIAMETER. CONTRACTOR TO CONFIRM FILL
- CASING TO HAVE CASING SPACERS INSTALLED PER MANUFACTURER'S RECOMMENDATIONS.
- CASING (UNLESS CASING IS GROUTED).

2070

2060

2050

2040

2030

EXISTING GROUND OVER PIPE (TYP)

CB 300 TYPE I BEEHIVE GRATE


12" IE 2043.95 (IN-NE)

RIM 2048.95

MATERIAL FOR SPACE BETWEEN CARRIER PIPE AND CASING.

PROVIDE END SEAL BETWEEN CARRIER PIPE (SEWER/WATER/STORM) AND

CONTRACTOR TO PROVIDE CUT SHEETS AND/OR SHOP DRAWINGS ON SPACERS, CASINGS, END SEALS AND GROUT PRIOR TO CONSTRUCTION.

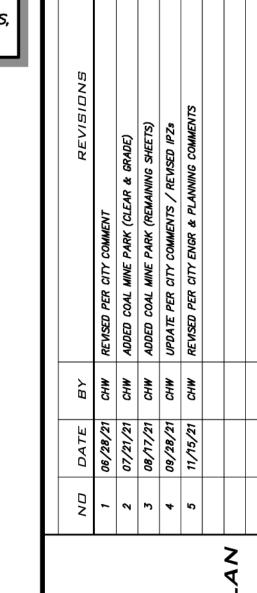

BLUELINE

25 CENTRAL WAY, SUITE 400, KIRKLAND, WA 98033 P: 425.216.4051 F: 425.216.4052 WWW.THEBLUELINEGROUP.COM

AS NOTED

DESIGNER: CHRIS WISCOMB

ISSUE DATE:

11/15/2021

PROJECT MANAGER: BRETT K. PUDISTS, PE PROJECT ENGINEER: LYNDSEY FEDAK, PE

2070


2060

2050

2040

2030

CB 3D1 TYPE! RIM 2062.76 12" IE 2057.76 (OUT-SW)

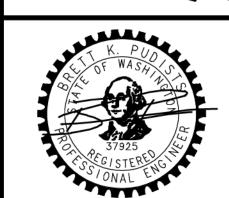

EXISTING UTILITY NOTE

DISPERSION TRENCH

SCALE: 1"=50' H, 1"=10' V

231+00

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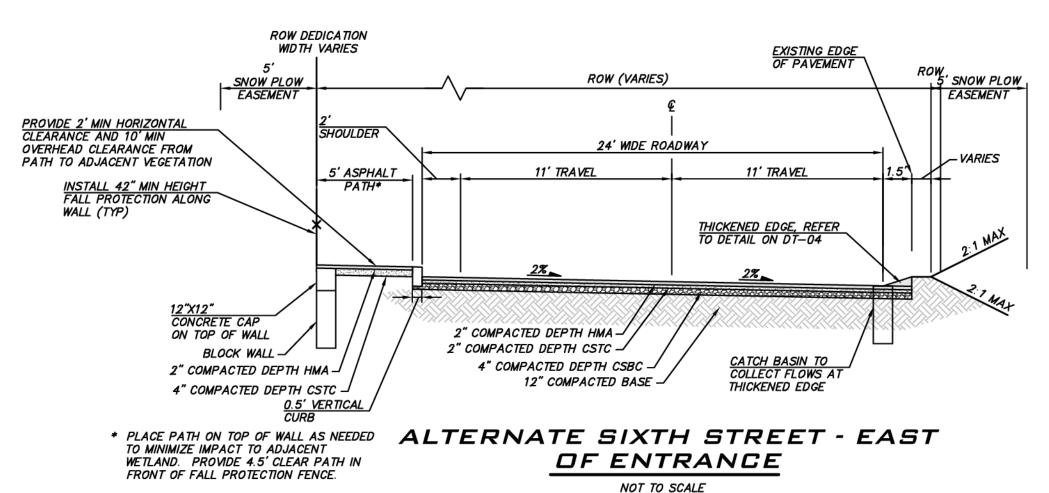


11/15/21

19-349 SHEET NAME: RP-04

sнт <u>18</u> ог <u>48</u>

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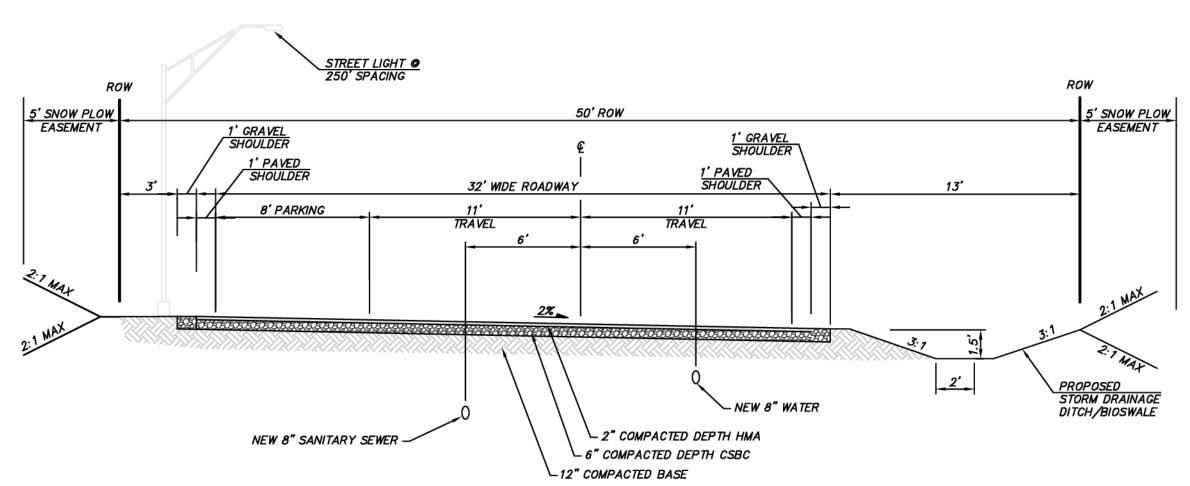


ROW DEDICATION **WIDTH VARIES** EXISTING EDGE OF PAVEMENT 8' EASEMENT FOR PLANTER ROW, 5 SNOW PLOW ROW (VARIES) AND PUBLIC ACCESS EASEMENT SNOW PLOW EASEMENT 26' WIDE ROADWAY -VARIES SHOULDER PROVIDE 2' MIN HORIZONTAL CLEARANCE AND 10' MIN OVERHEAD CLEARANCE FROM 11' TRAVEL 11' TRAVEL 5' ASPHALT 4'
PATH * PLANTER PATH TO ADJACENT VEGETATION 2" COMPACTED DEPTH HMA -2" COMPACTED DEPTH HMA 2" COMPACTED DEPTH CSTC -4" COMPACTED DEPTH CSTC THICKENED EDGE 4" COMPACTED DEPTH CSBC -12" COMPACTED BASE -* LOCATION OF PEDESTRIAN PATH VARIES


> SIXTH STREET - EAST OF ENTRANCE NOT TO SCALE

> > STA 11+30 TO 13+30

STA 10+00 TO 11+30




50' ROW ROAD CROSS SECTION INTERNAL ROAD (ROAD C) (W/ PARKING ON ONE SIDE) NOT TO SCALE

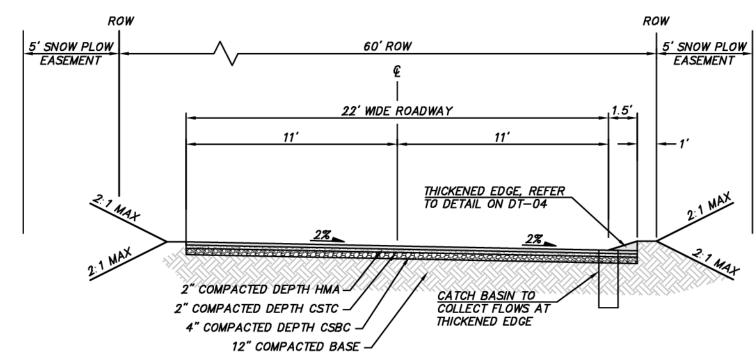


TO MINIMIZE IMPACT TO WETLAND AREA. SEE ALTERNATE SIXTH STREET

SECTION (STA 10+00 TO 11+30)


PARK ST EXTENSION (HALF STREET IMPROVEMENTS) NOT TO SCALE

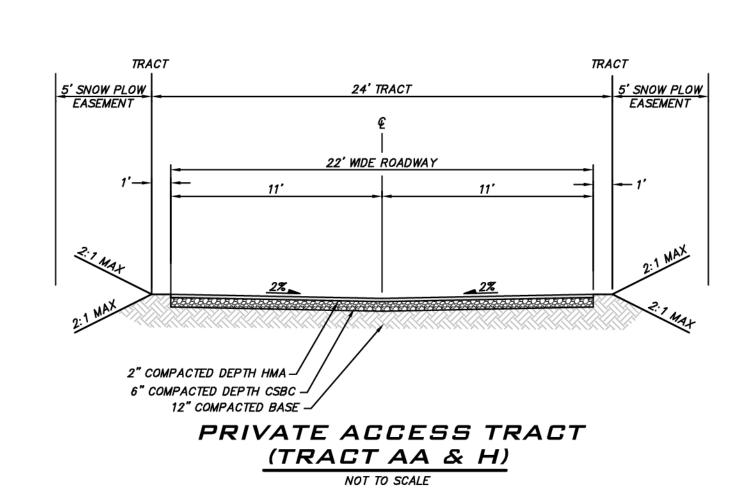

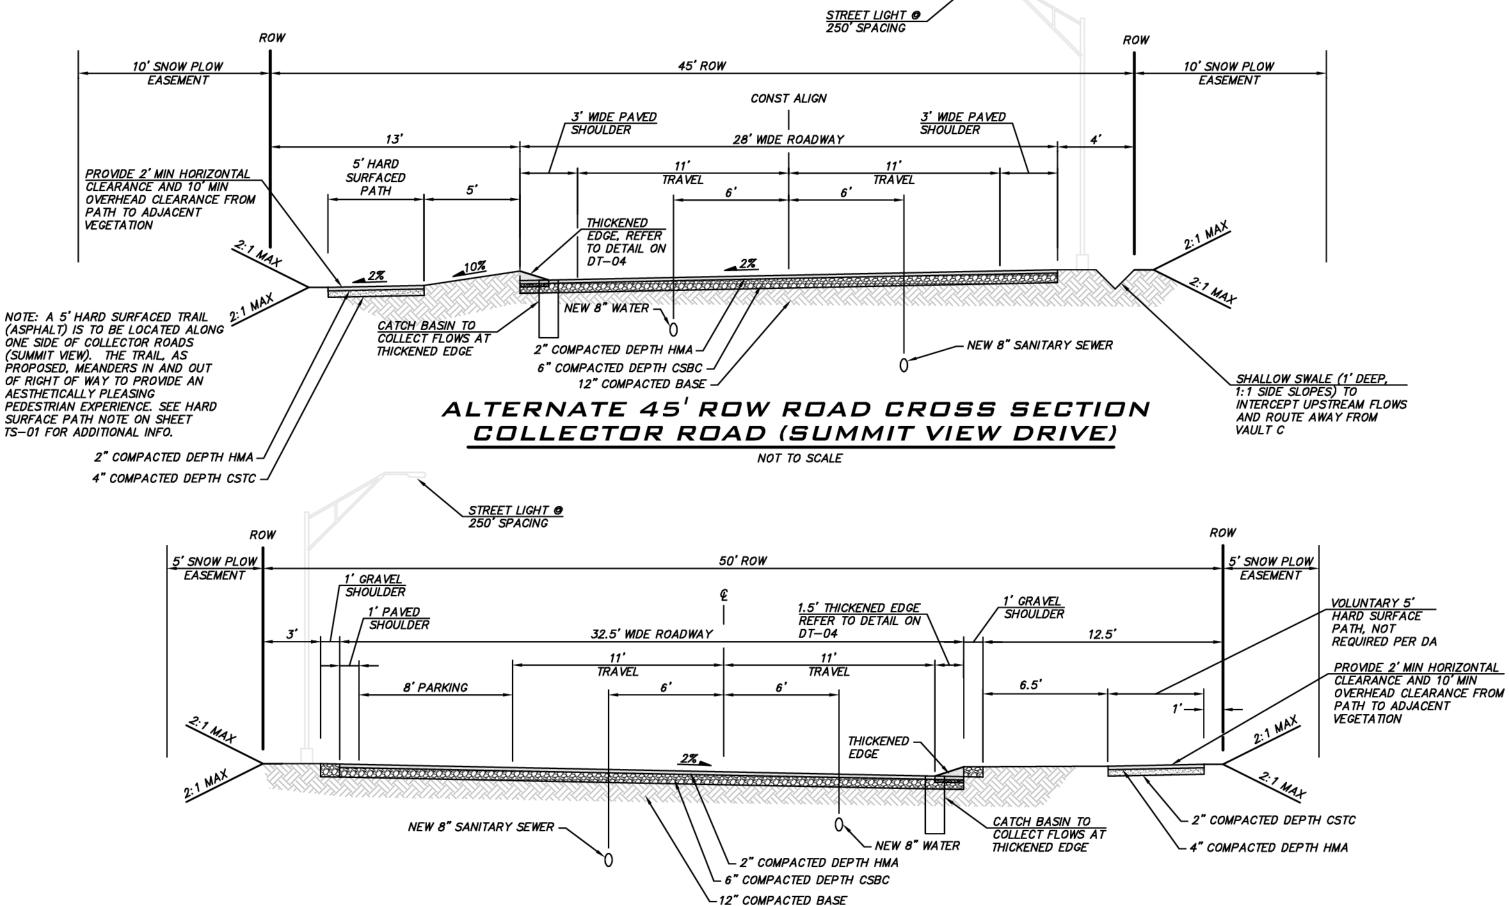


ALTERNATE 50' ROW ROAD CROSS SECTION INTERNAL ROAD (ROAD B) (W/ PARKING ON ONE SIDE)

NOT TO SCALE

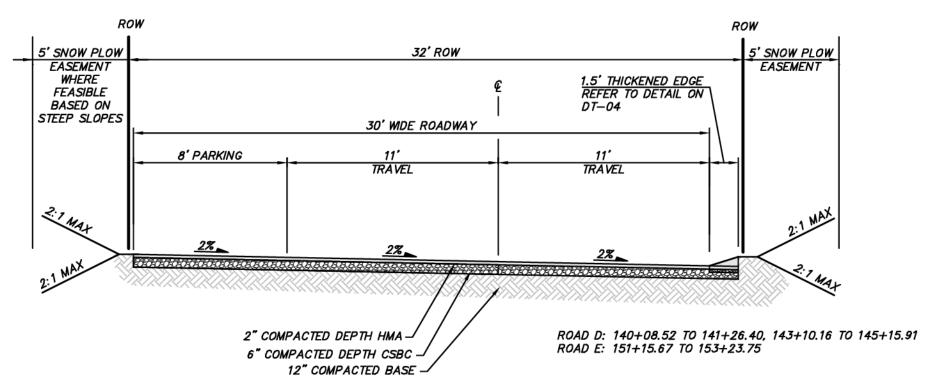


MODIFIED ROAD W/ PARKING (ROAD D&E)

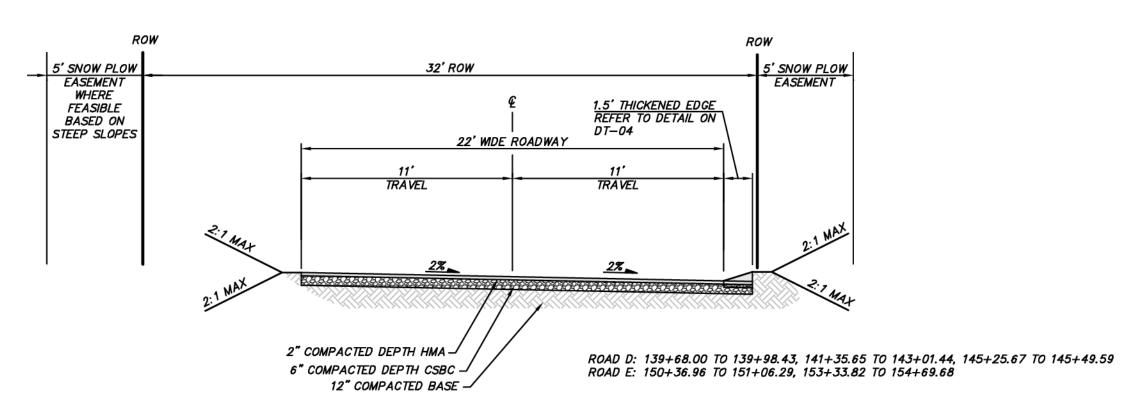

MODIFIED ROAD W/O PARKING (ROAD D&E) NOT TO SCALE

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11/15/21

19-349 SHEET NAME: RD-01

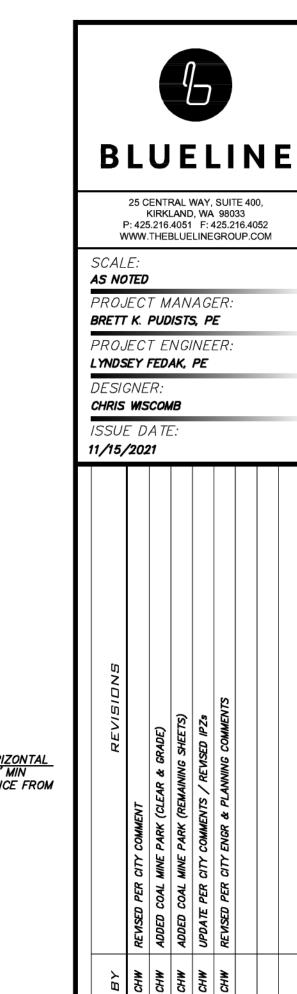sнт <u>19</u> ог <u>48</u>

^{*}ໄຂື່ພ່**ີ ©2021 BLUELINE**

1.5' THICKENED EDGE REFER TO DETAIL ON DT-04


PROPOSED GRADE

SECTION B-B

30' WIDE ROADWAY


SECTION B-B ROAD E

NOT TO SCALE REFER TO SHEET GP-01 FOR LOCATION OF CROSS SECTION

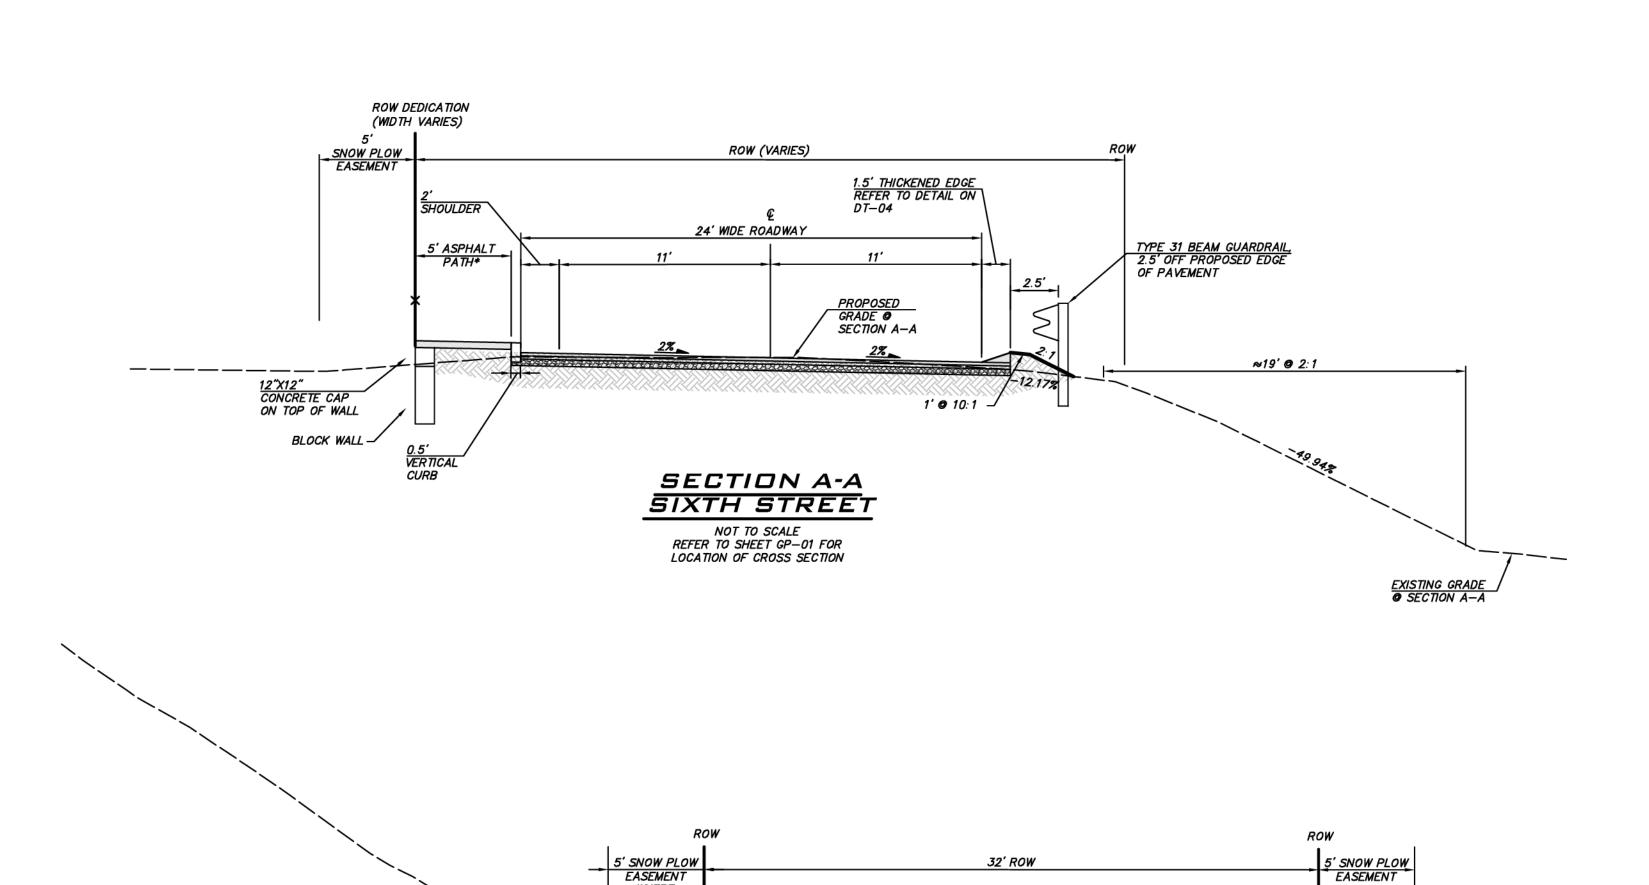

WHERE FEASIBLE BASED ON STEEP SLOPES

8' PARKING

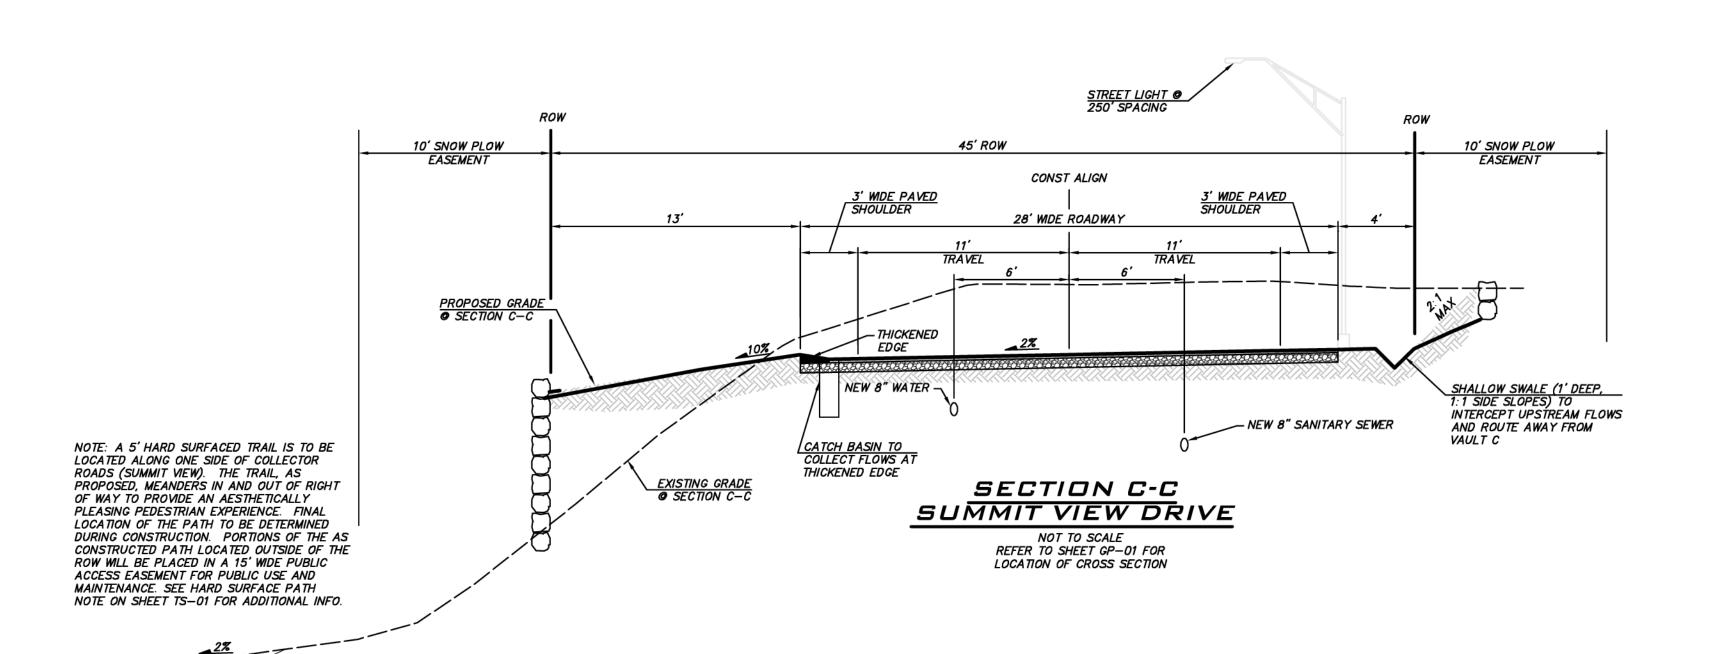



25 CENTRAL WAY, SUITE 400, KIRKLAND, WA 98033 P: 425.216.4051 F: 425.216.4052 WWW.THEBLUELINEGROUP.COM

SCALE: AS NOTED

PROJECT MANAGER: BRETT K. PUDISTS, PE

PROJECT ENGINEER: LYNDSEY FEDAK, PE

DESIGNER:

CHRIS WISCOMB ISSUE DATE:

11/15/2021



11/15/21

19-349 SHEET NAME: XS-01

EXISTING UTILITIES ARE SHOWN IN THE APPROXIMATE LOCATION. THERE IS NO GUARANTEE THAT ALL UTILITY LINES ARE SHOWN, OR THAT THE LOCATION, SIZE

EXISTING UTILITY NOTE

AND MATERIAL IS ACCURATE. THE CONTRACTOR SHALL UNCOVER ALL INDICATED

PIPING WHERE CROSSING, INTERFERENCES, OR CONNECTIONS OCCUR PRIOR TO


ACTUAL LOCATIONS, SIZE AND MATERIAL. THE CONTRACTOR SHALL MAKE THE


CONTRACTOR SHALL NOTIFY ONE CALL AT 8-1-1 (WASHINGTON811.COM) AND ARRANGE FOR FIELD LOCATION OF EXISTING FACILITIES BEFORE CONSTRUCTION.

TRENCHING OR EXCAVATION FOR ANY PIPE OR STRUCTURES, TO DETERMINE

APPROPRIATE PROVISION FOR PROTECTION OF SAID FACILITIES. THE

sнт **20** ог **48**

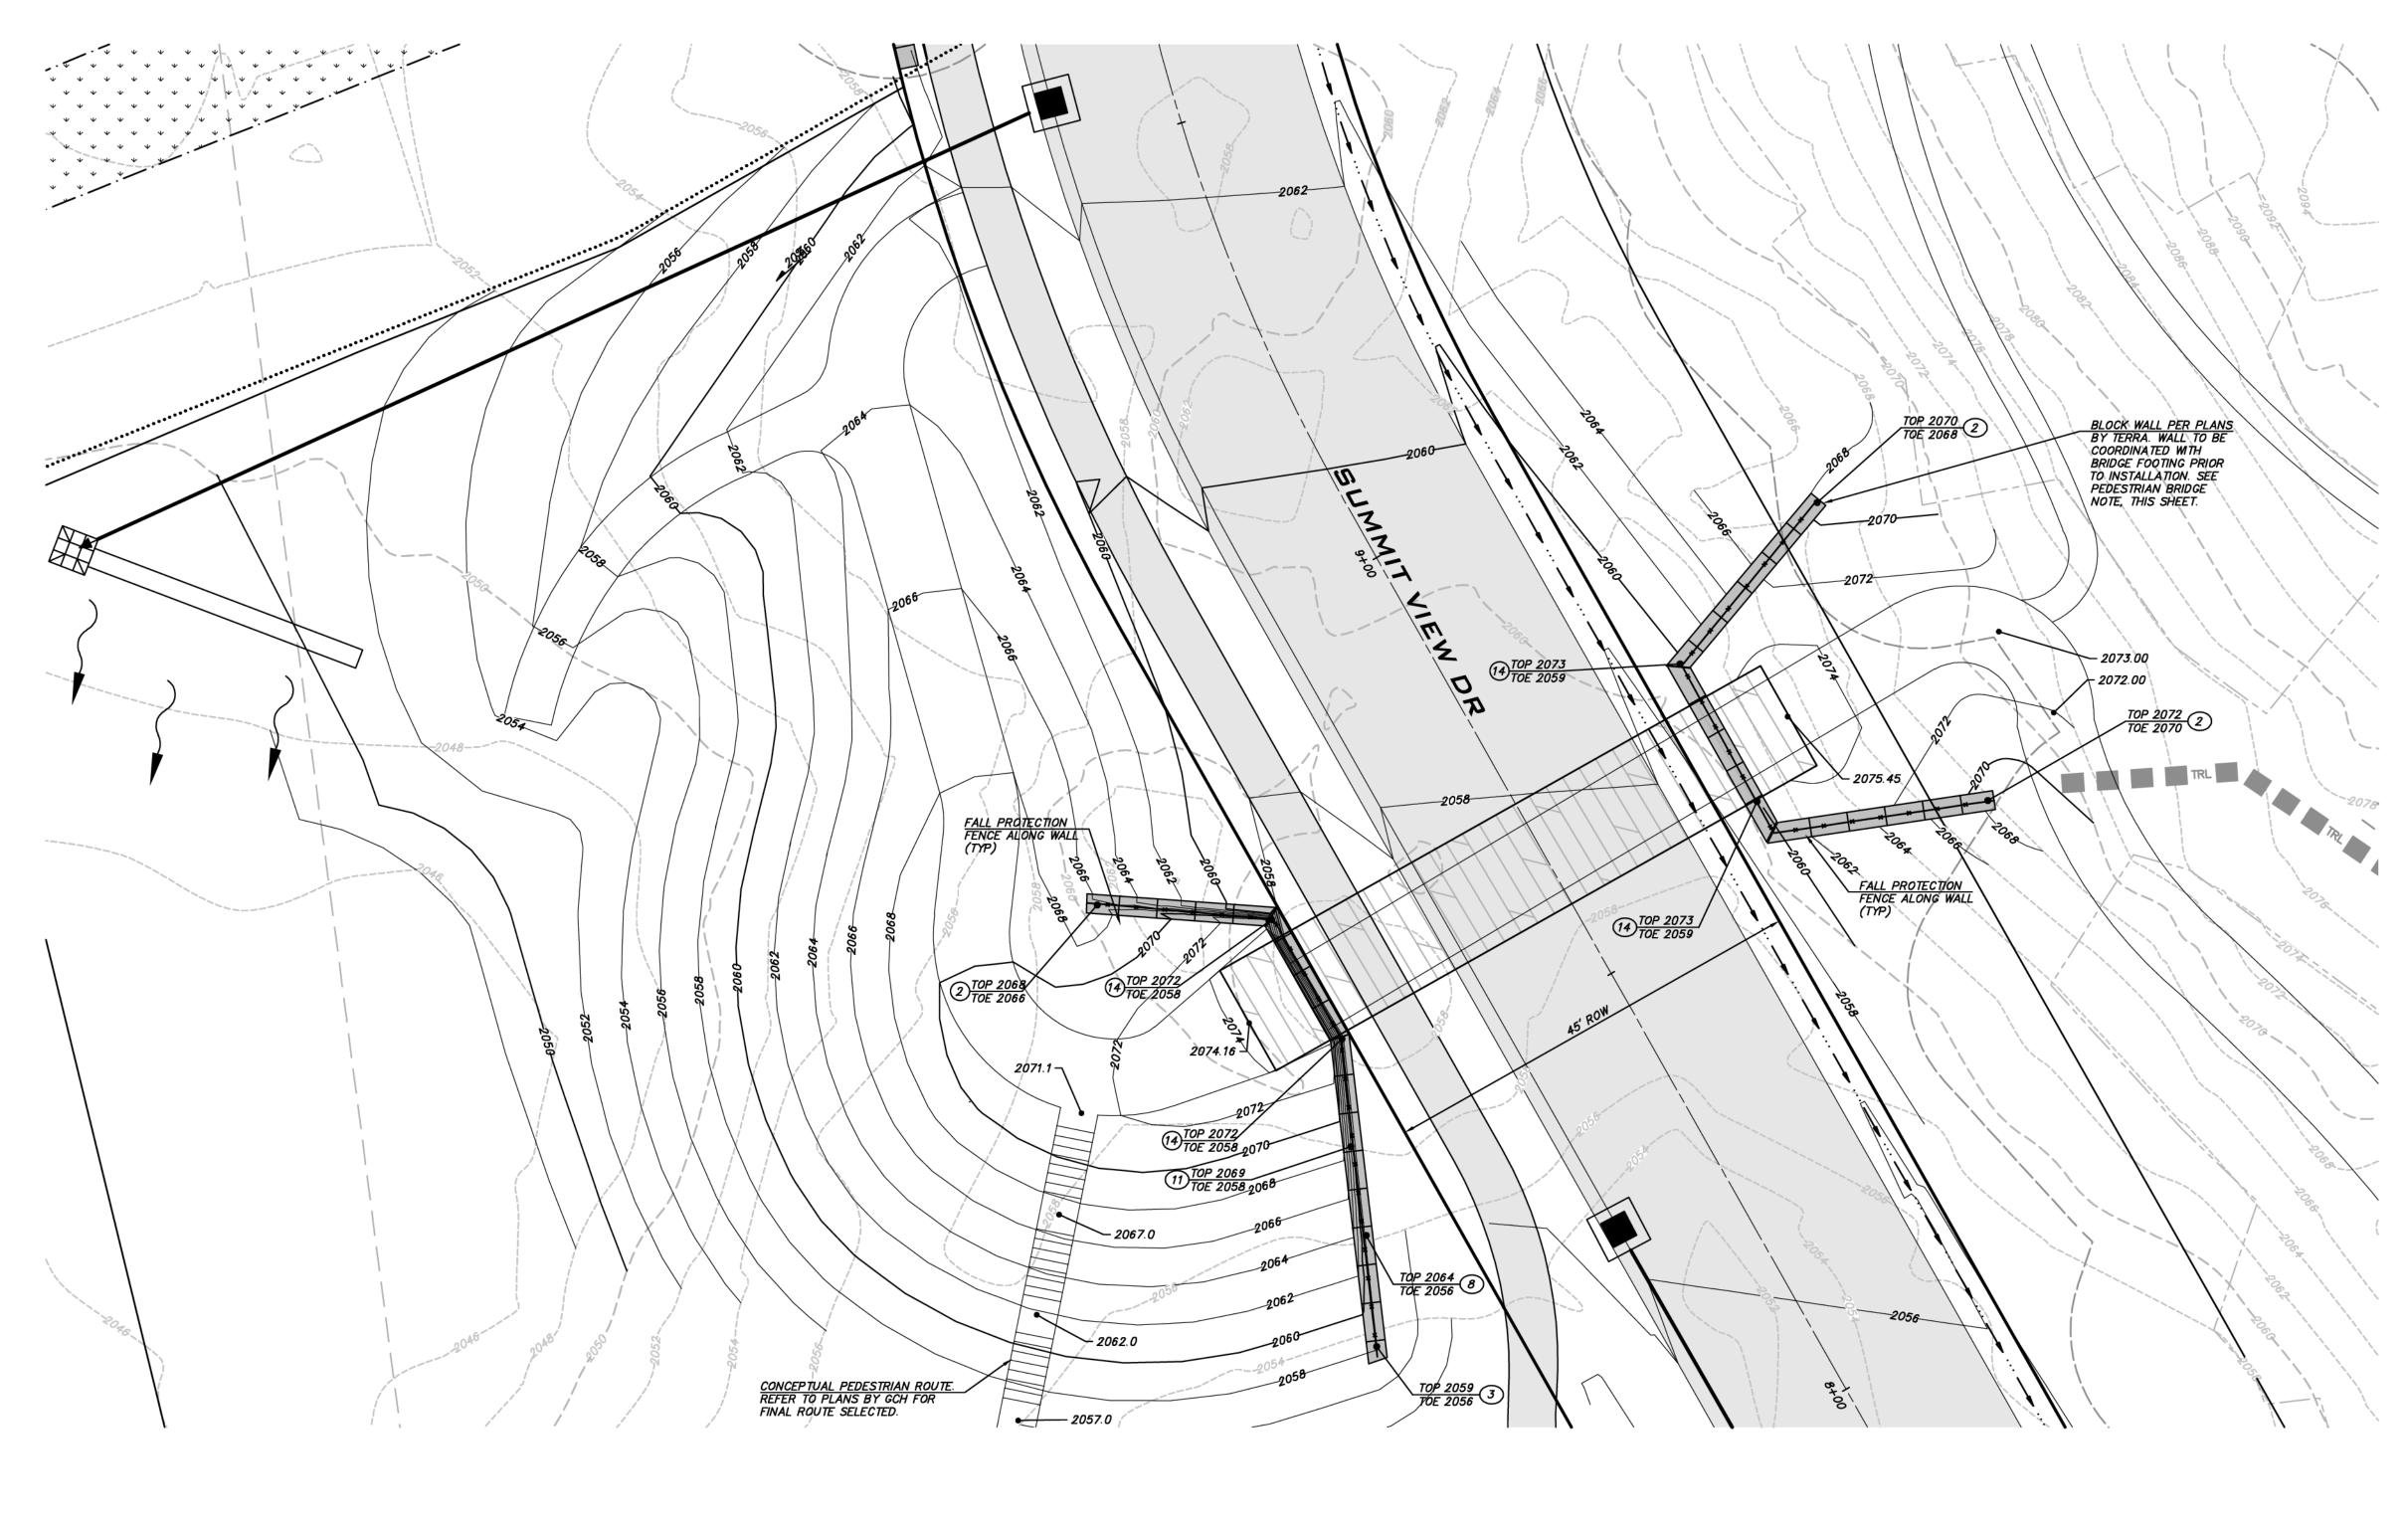

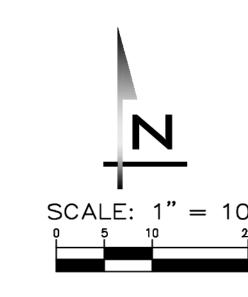



25 CENTRAL WAY, SUITE 400, KIRKLAND, WA 98033 P: 425.216.4051 F: 425.216.4052 WWW.THEBLUELINEGROUP.COM


SCALE: AS NOTED

PROJECT MANAGER: BRETT K. PUDISTS, PE

PROJECT ENGINEER: LYNDSEY FEDAK, PE

CHRIS WISCOMB

11/15/2021

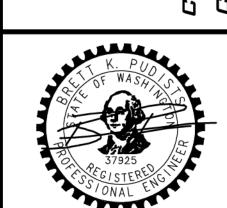

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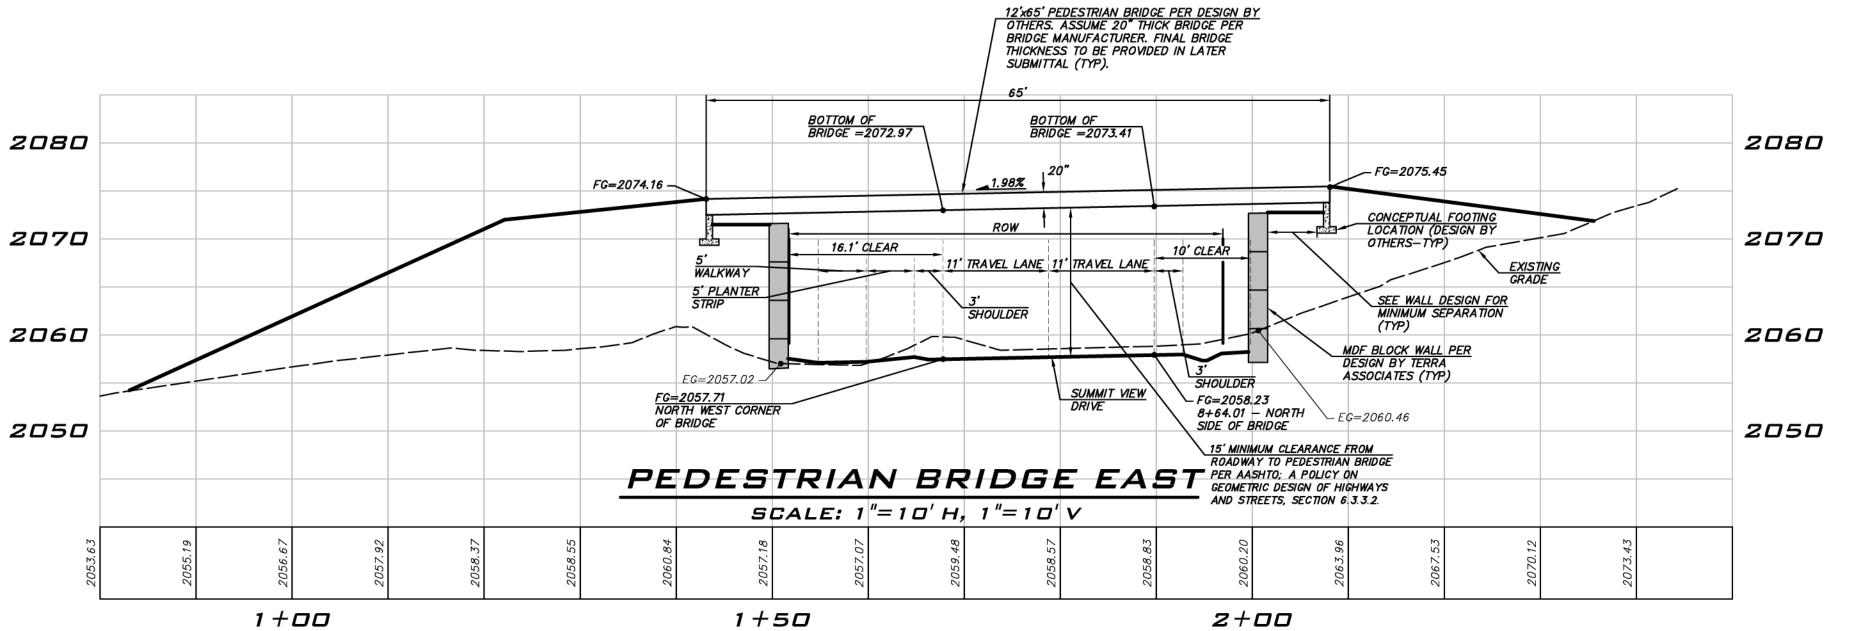
19-349 SHEET NAME:


BR-01 sнт <u>21</u> ог <u>48</u>


PEDESTRIAN BRIDGE NOTE BRIDGE DESIGN PARAMETERS AND GRADING IN AREA OF BRIDGE ARE PROVIDED AS PART OF THE CLEARING, GRADING & INFRASTRUCTURE PLAN. SUBMITTAL PACKAGE FROM BRIDGE MANUFACTURER FOR STRUCTURAL ELEMENTS OF BRIDGE TO BE PROVIDED SEPARATELY TO THE CITY WHEN AVAILABLE.


EXISTING UTILITY NOTE


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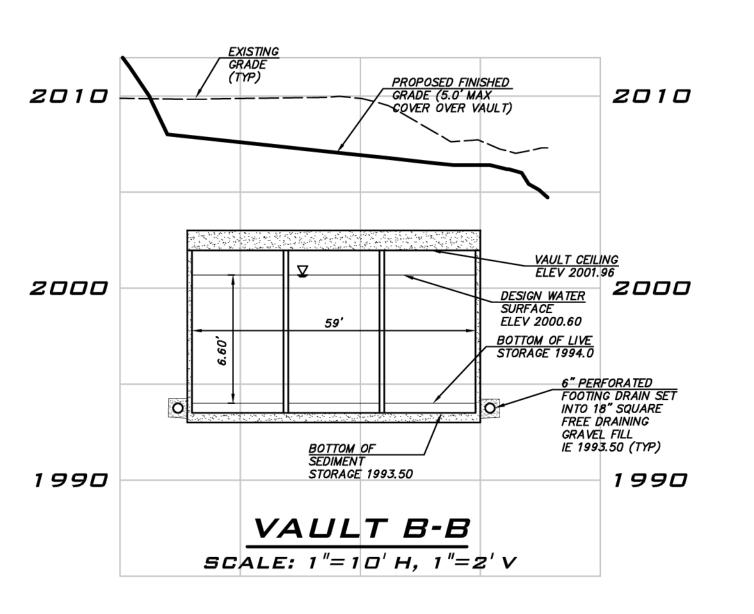




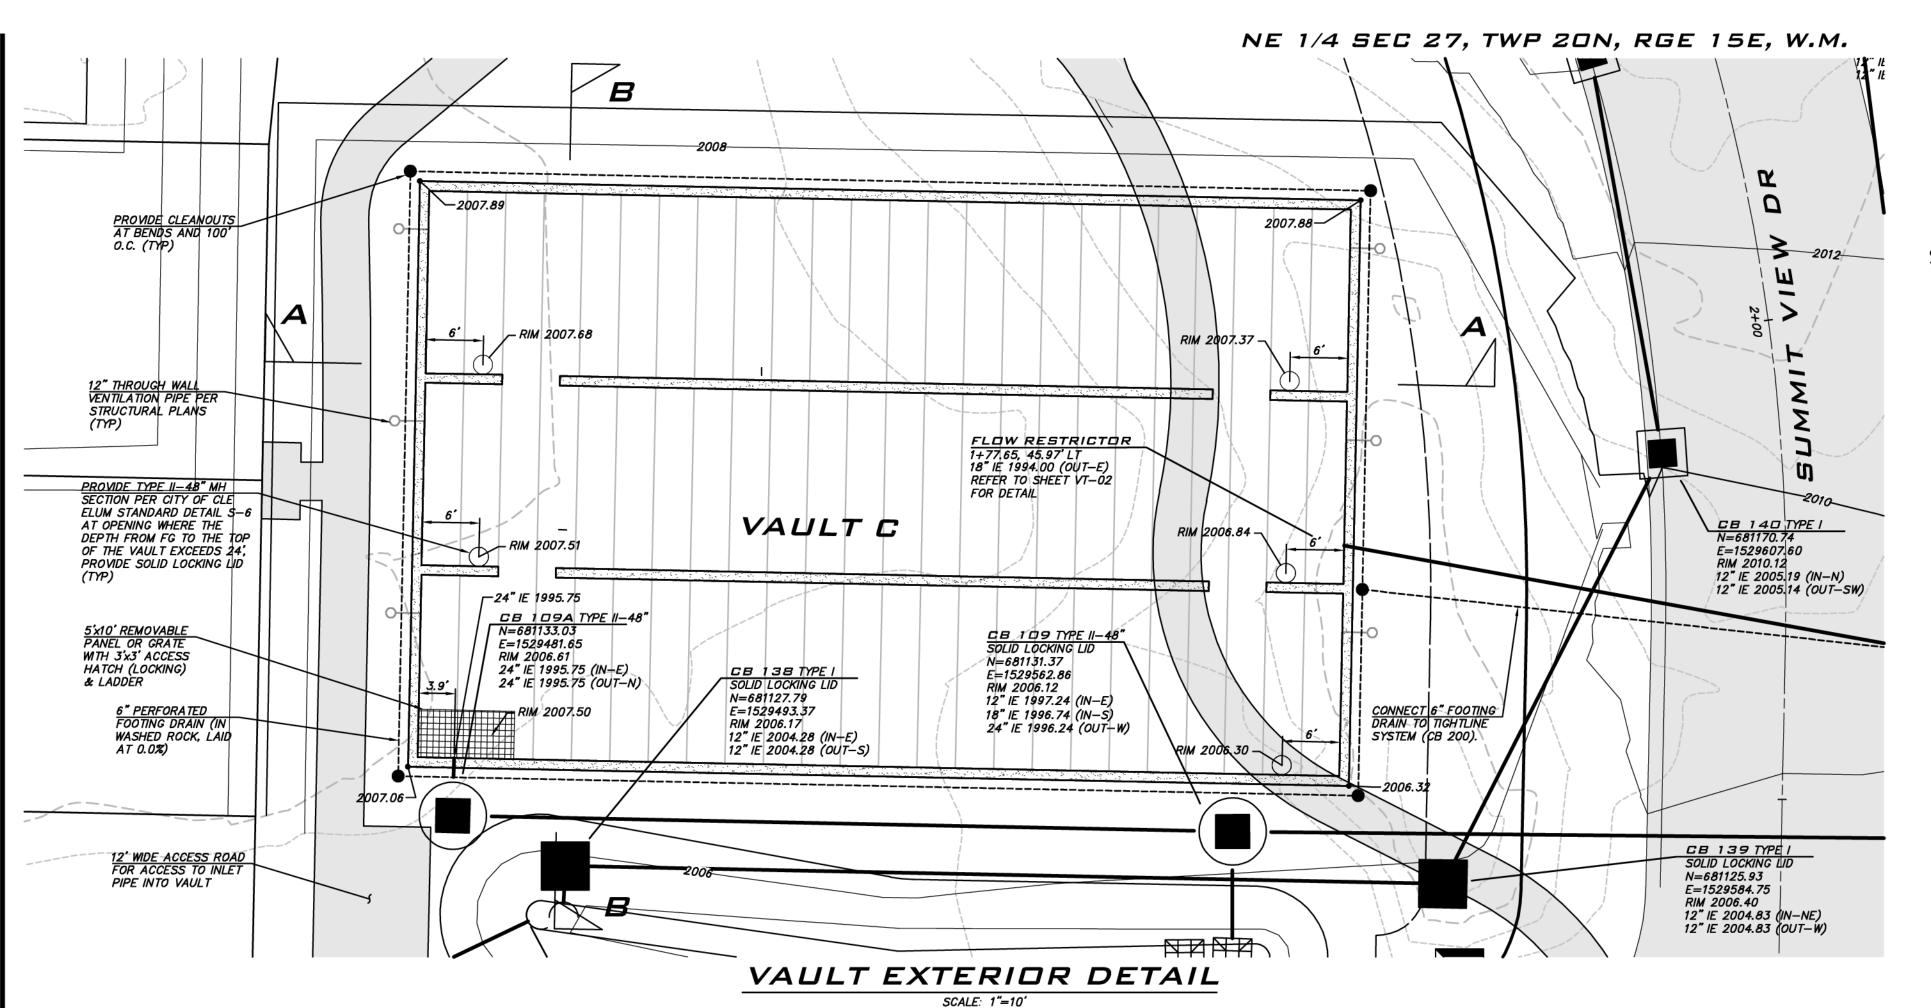

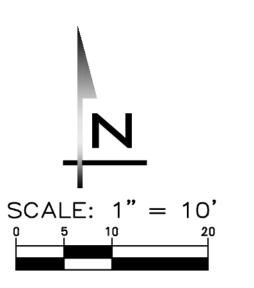

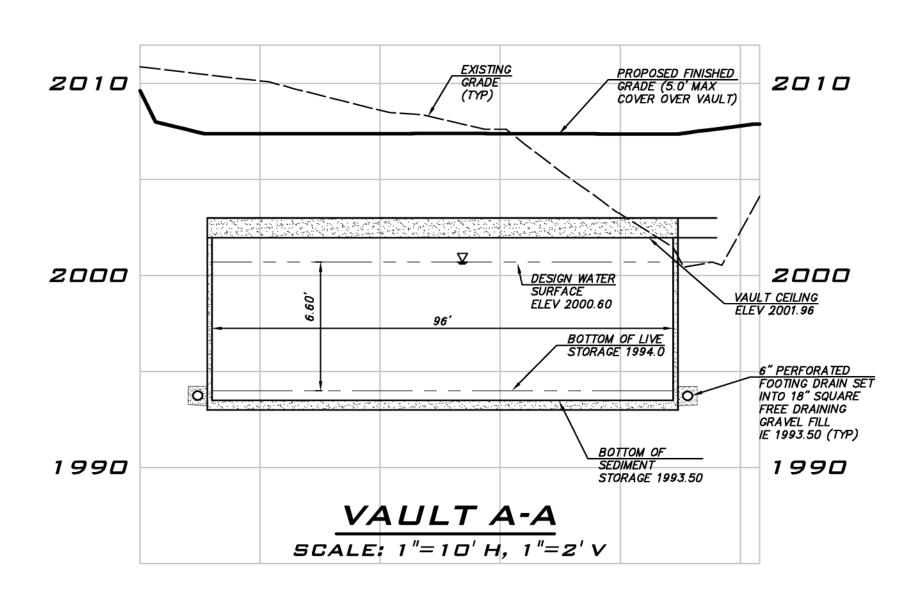

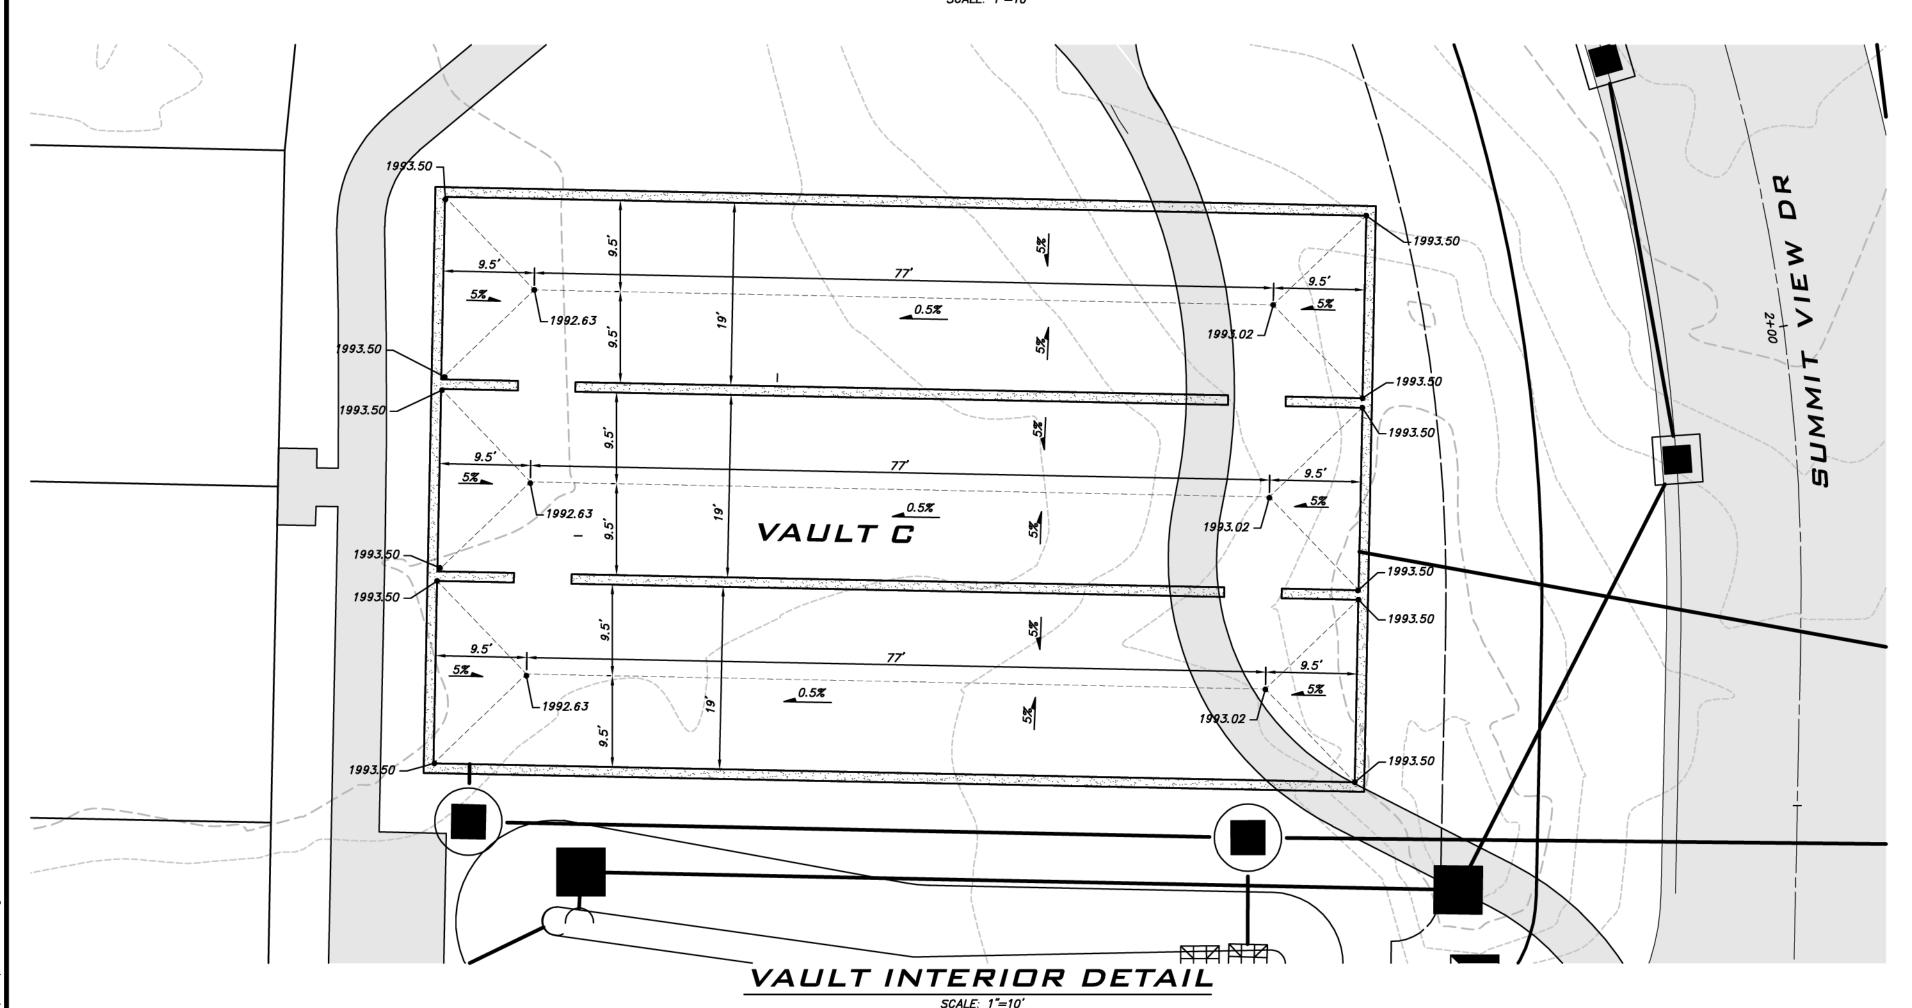

NOTE

REFER TO SHEET VT-02 FOR CONTROL STRUCTURE NOTES, VAULT NOTES, AND STANDARD DETAILS.

FINISHED GRADE OVER VAULT

INTERIM FG OVER VAULT VARIES FROM 2006 (3' COVER MIN) TO 2008 (5' COVER MAX).

FACILITY DESIGN VOLUMES

LIVE STORAGE REQUIRED: LIVE STORAGE PROVIDED: 34,967 CF 36,115 CF

EXISTING UTILITY NOTE

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25 CENTRAL WAY, SUITE 400, KIRKLAND, WA 98033 P: 425.216.4051 F: 425.216.4052

WWW.THEBLUELINEGROUP.COM SCALE:

AS NOTED PROJECT MANAGER: BRETT K. PUDISTS, PE

PROJECT ENGINEER: LYNDSEY FEDAK, PE DESIGNER:

CHRIS WISCOMB ISSUE DATE:

11/15/2021

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11/15/21

19-349 SHEET NAME:

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VT-0 1

STORM DRAIN OWNERSHIP

SEE NOTES ON SHEET GN-01.

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FLOW RESTRICTOR



25 CENTRAL WAY, SUITE 400, KIRKLAND, WA 98033 P: 425.216.4051 F: 425.216.4052 WWW.THEBLUELINEGROUP.COM

AS NOTED

PROJECT MANAGER:

BRETT K. PUDISTS, PE PROJECT ENGINEER:

LYNDSEY FEDAK, PE

DESIGNER:

CHRIS WISCOMB

11/15/2021

VAULT NOTES

ALUMINUM ARE ACCEPTABLE.

DIMENSIONS DEPICTING OVERALL SIZE OF VAULT ARE FOR REFERENCE ONLY. SEE STRUCTURAL PLANS FOR TOTAL LENGTH, WIDTH, HEIGHT AND WALL THICKNESS DESIGN, AS WELL AS LOCATIONS FOR ALL MAINTENANCE ACCESS POINTS AND PROPOSED PENETRATIONS

PIPE SUPPORTS AND RESTRICTOR/SEPARATOR SHALL BE OF SAME MATERIAL, AND BE ANCHORED AT 3' MAX SPACING BY 5/8" DIÀMETER STAINLESS STEEL EXPANSION BOLTS OR EMBEDDED 2" II

THE RESTRICTOR/SEPARATOR SHALL BE FABRICATED FROM .060" ALUMINUM, OR .064" ALUMINIZED STEEL, OR .064" GALVANIZED STEEL PIPE; IN ACCORDANCE WITH AASHTO M 36, M 196, M 197, AND

3. OUTLET SHALL BE CONNECTED TO CULVERT OR SEWER PIPE WITH A STANDARD COUPLING BAND

4. Frame and ladder located such that cleanout gate is visible from top, climb down

5. ALL METAL PARTS CORROSION RESISTANT. NO—GALVANIZED PARTS. STAINLESS STEEL PARTS AND

FOR CORRUGATED METAL PIPE, OR GROUTED INTO THE BELL OF CONCRETE PIPE

- 2. VAULT TO BE DESIGNED TO ACCOMMODATE OVERBURDEN AND H20 VEHICULAR LOADING MINIMUM PER THE STORMWATER MANAGEMENT MANUAL FOR EASTERN WASHINGTON
- 3. SEE WSDOT STANDARD PLANS B-5.20-03, B-5.40-02 & B-10.20-02 FOR CATCH BASIN
- 4. SEE WSDOT STANDARD PLANS B-30.70-04 FOR LOCKING MANHOLE FRAME AND COVER DETAIL 5. SEE WSDOT STANDARD PLANS B-10.40-01 FOR SHEAR GATE DETAIL
- 6. JOINTS AND PENETRATIONS IN VAULT AND LID TO BE WATER TIGHT. PROVIDE WATERSTOPS IN CAST IN PLACE JOINTS
- 7. ALL WATERSTOPS TO BE INSTALLED PER PLAN AND SPECIFICATION AND TO BE INSPECTED BY
- 8. PIPES SEALED WITH GROUT
- 9. VENTILATION PIPES (MIN 12 INCH DIAMETER) PROVIDED AT CORNERS. VENT PIPE SHALL BE SCHEDULE 40 PVC OR BETTER AND SHALL HAVE LOCKING DUCTILE IRON RINGS AND LIDS.
- 10. ACCESS OPENINGS TO HAVE OSHA CONFINED SPACE WARNING

FLOW RESTRICTOR NOTES

M274. GALVANIZED STEEL SHALL HAVE TREATMENT I.

SPACE IS CLEAR OF RISER AND FRAME IS CLEAR OF CURB

- 11. VAULT TO BE PRIVATELY MAINTAINED.
- 12. PIPE SIZES AND SLOPES: PER PLANS. 13. FINISHED GRADE OVER VAULT TO BE PER PLAN
- 14. VAULT EXCAVATION TO BE FENCED AND SECURED BY CONTRACTOR. SAFETY FENCING, SHORING, EXCAVATION SAFETY, AND OTHER SAFETY ITEMS ARE THE RESPONSIBILITY OF THE CONTRACTOR. ALL ACCESS TO HAVE SECURE COVERING DURING CONSTRUCTION.
- 15. ALL STORMWATER FACILITIES, CATCH BASINS, AND CONVEYANCE SHALL BE CLEANED FOR CITY INSPECTION PRIOR TO FINAL PLAT AND ALSO FOR CITY INSPECTION PRIOR TO PERFORMANCE AND MAINTENANCE BOND RELEASE
- 16. THE CONTRACTOR AND HIS SUBCONTRACTOR SHALL BE RESPONSIBLE FOR VERIFYING ALL DIMENSION AND ELEVATIONS SHOWN ON THESE DRAWINGS WITH THE CURRENT PERMITTED SET OF STRUCTURAL DRAWINGS, AND SHALL NOTIFY BOTH THE STRUCTURAL & CIVIL ENGINEERS IN WRITING OF ALL DISCREPANCIES BETWEEN THE CIVIL DRAWINGS AND THESE DRAWINGS TO

STORM DRAIN OWNERSHIP

SEE NOTES ON SHEET GN-01.


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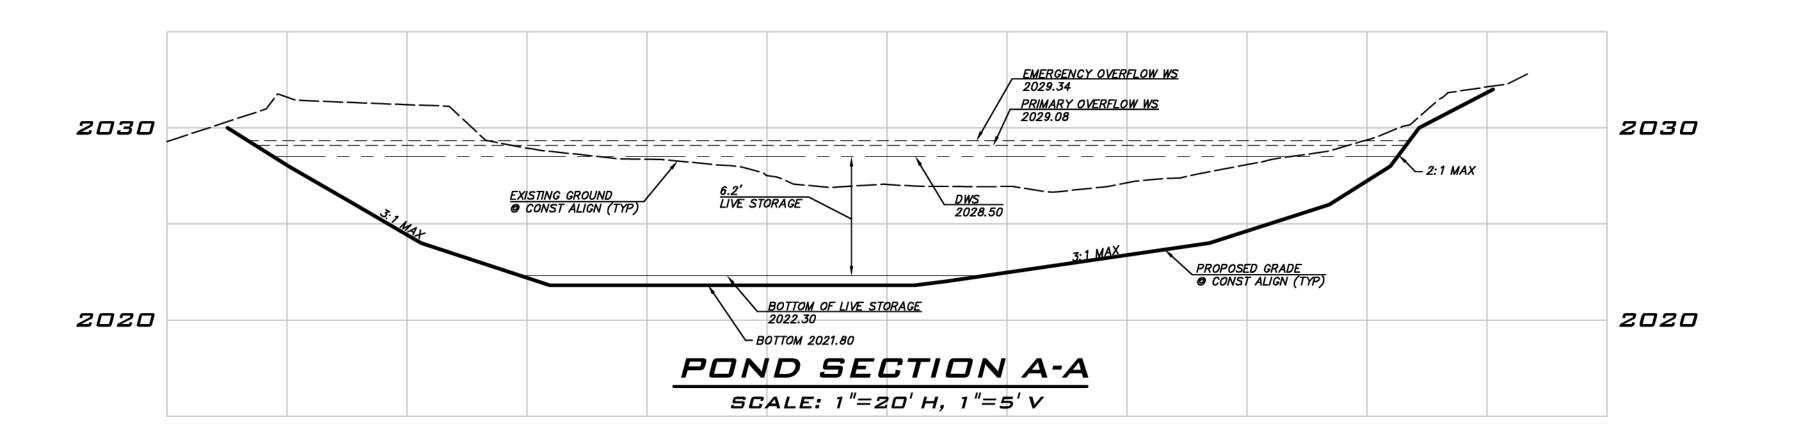
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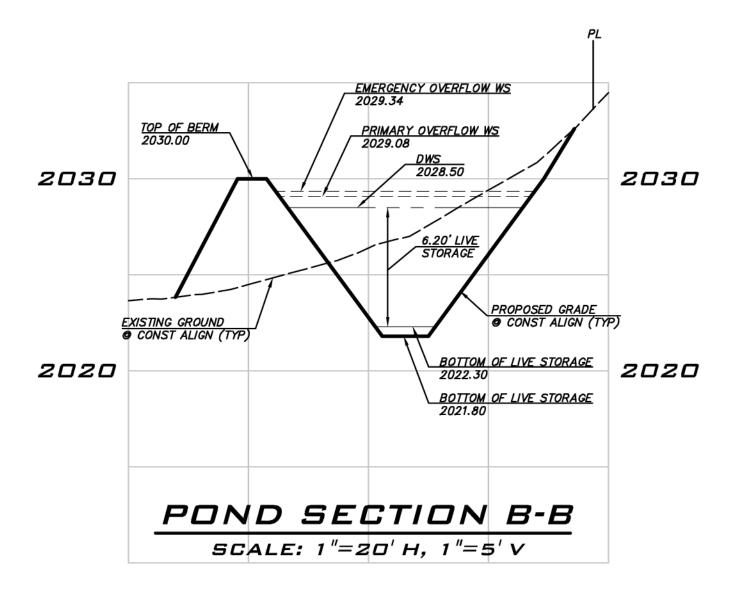
19-349 SHEET NAME: *VT-02*

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POND B7-A DETAIL





ក្² ខ ់ i **© 2021 BLUELINE**

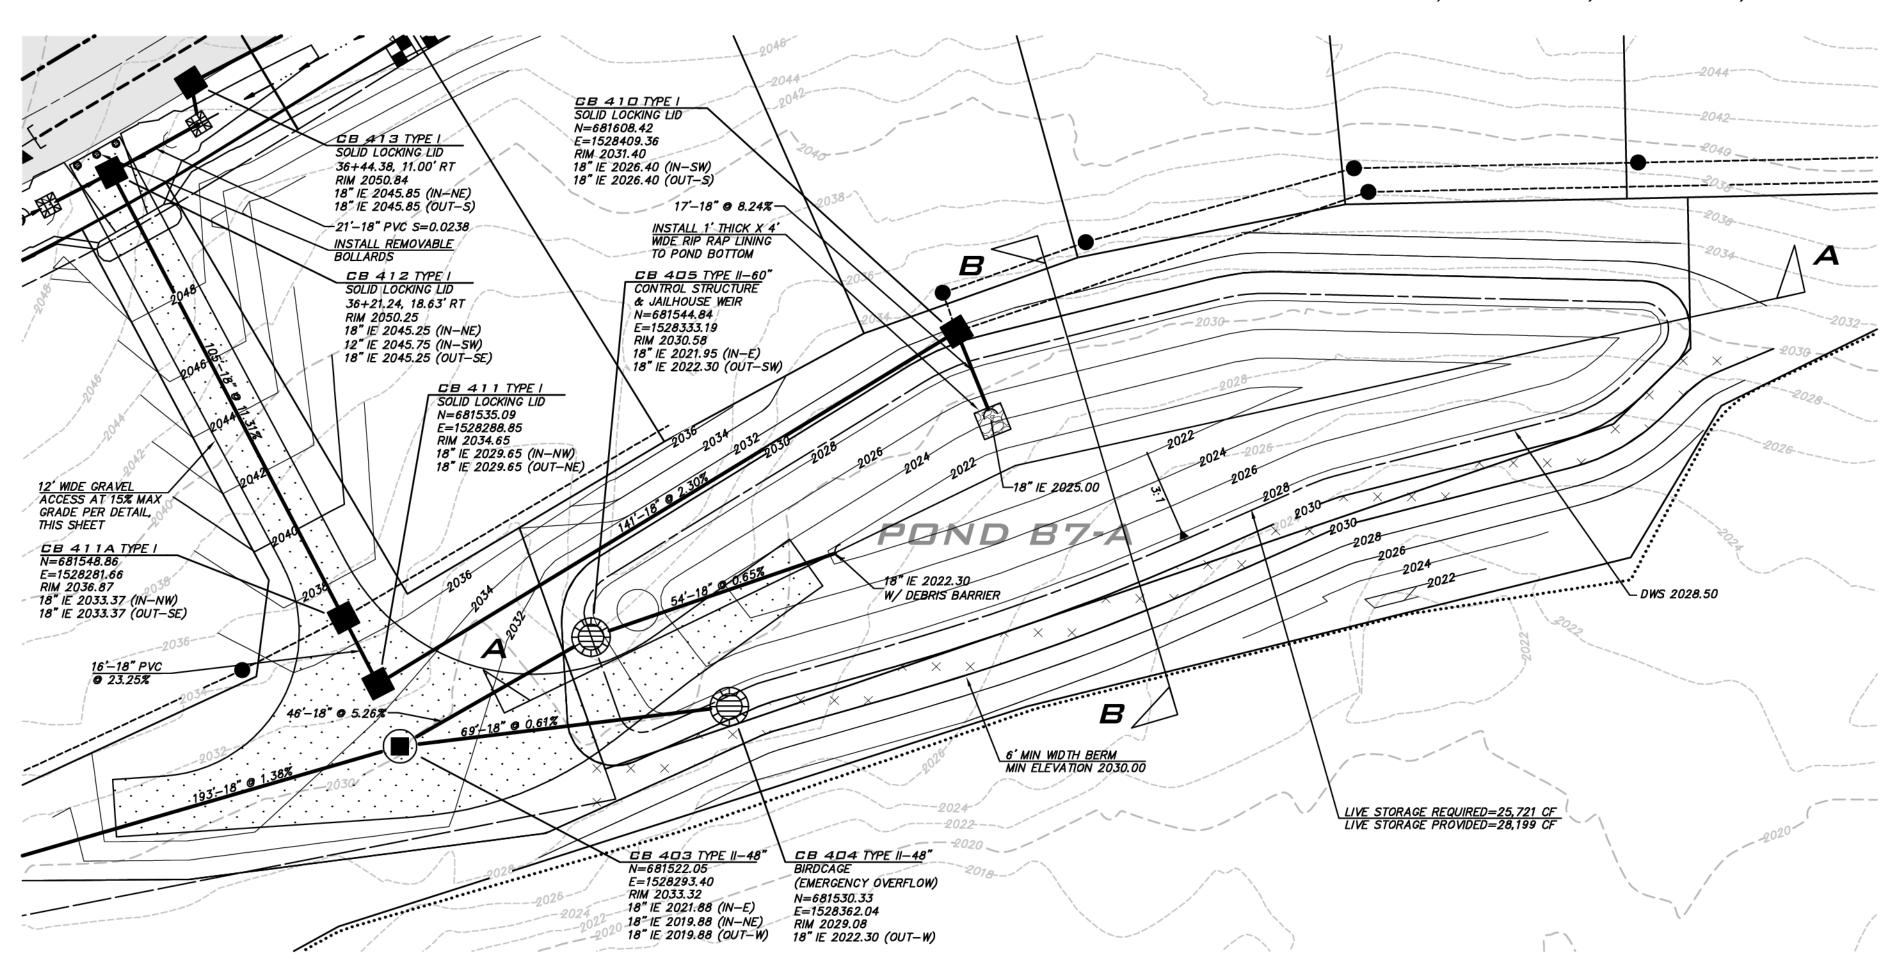1-1/2" CRUSHED SURFACING TOP COURSE *COMPACTED TO └── 2-1/2" CRUSHED SURFACING BASE COURSE 95% MAX DENSITY —— SUITABLE NATIVE OR FILL MATERIAL

GRAVEL ACCESS ROAD

NOT TO SCALE

SEE NOTES ON SHEET GN-01.



25 CENTRAL WAY, SUITE 400, KIRKLAND, WA 98033 P: 425.216.4051 F: 425.216.4052 WWW.THEBLUELINEGROUP.COM

AS NOTED

PROJECT MANAGER: BRETT K. PUDISTS, PE

PROJECT ENGINEER: LYNDSEY FEDAK, PE DESIGNER:

CHRIS WISCOMB

11/15/2021

POND WATER SURFACE INFO

CONNECT TO THE DOWNSTREAM CONVEYANCE SYSTEM.

EXISTING UTILITY NOTE

<u>DESIGN WATER SURFACE:</u> TYPICAL WATER SURFACE WHEN POND IS FUNCTIONING PROPERLY UP TO THE DESIGN EVENT.

PRIMARY OVERFLOW WATER SURFACE: WS ELEVATION CORRESPONDING TO THE HEAD OVER TOP OF RISER PIPE NEEDED TO CONVEY FLOWS IF THE POND IS IN OVERFLOW.

EMERGENCY OVERFLOW WS: ASSUMING THE RISER PIPE BECOMES CLOGGED THIS IS THE WS

<u>TOP OF BERM:</u> SET TOP OF BERM AT LEAST 0.5' ABOVE THE EMERGENCY OVERFLOW WATER SURFACE.

ELEVATION CORRESPONDING TO THE HEAD OVER THE SECONDARY OVERFLOW STRUCTURE (CB WITH BIRDCAGE). FLOWS ENTERING THE BIRDCAGE WILL BYPASS THE CONTROL STRUCTURE AND

NOTE: ELEVATIONS OF BERMS, FLOW CONTROL STRUCTURE, JAIL HOUSE WEIR AND EMERGENCY OVERFLOW BIRDCAGE ARE CRITICAL AND POND MAY NOT FUNCTION AS INTENDED IF ELEVATIONS
ARE NOT PER PLAN.


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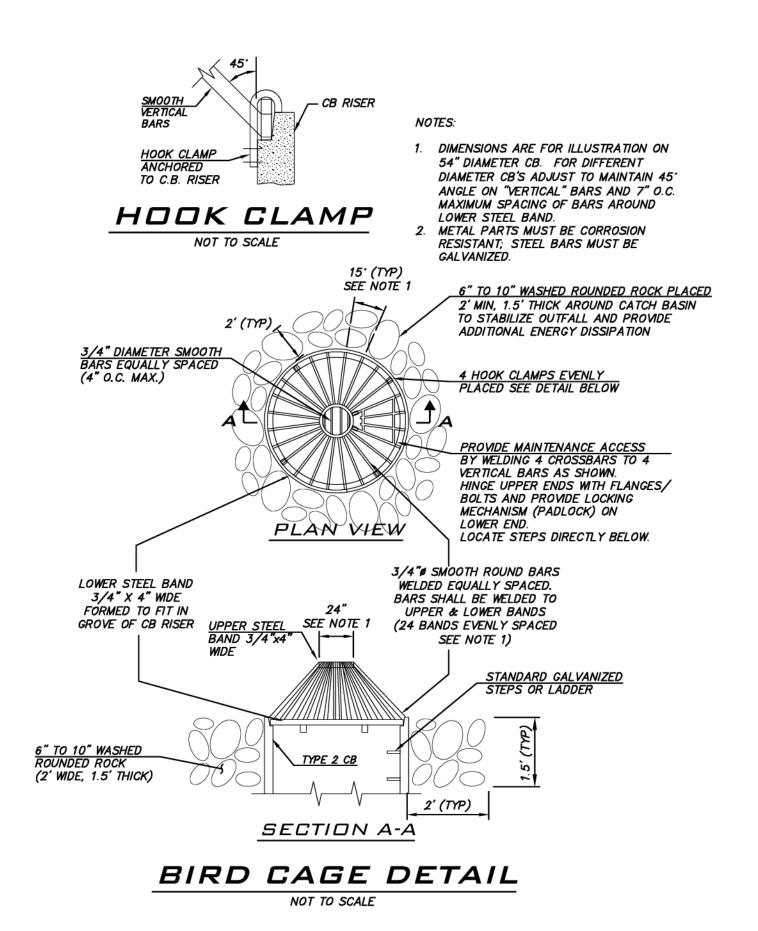



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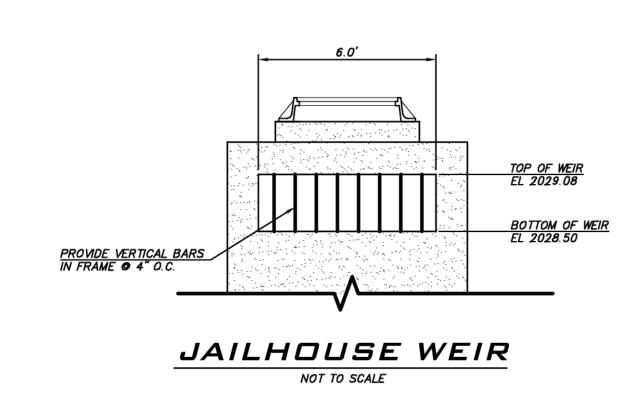
<u> 24</u> of <u>48</u>


SCALE: 1" = 20'



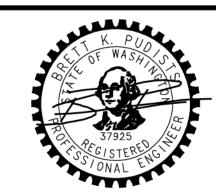

SEE NOTE, THIS SHEET TOP 2030.58

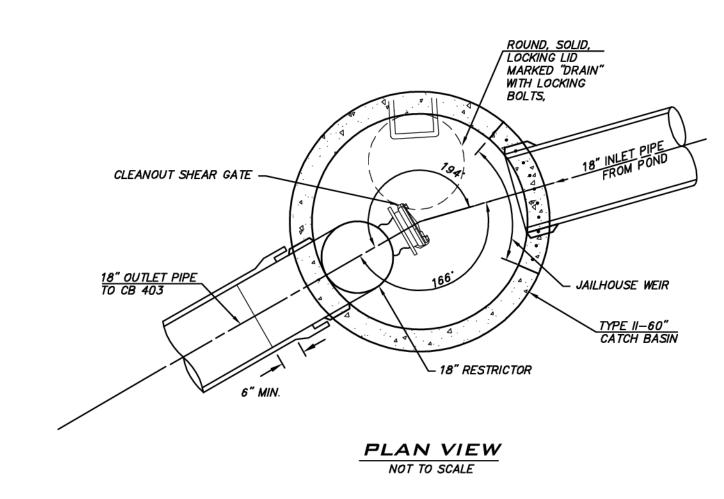

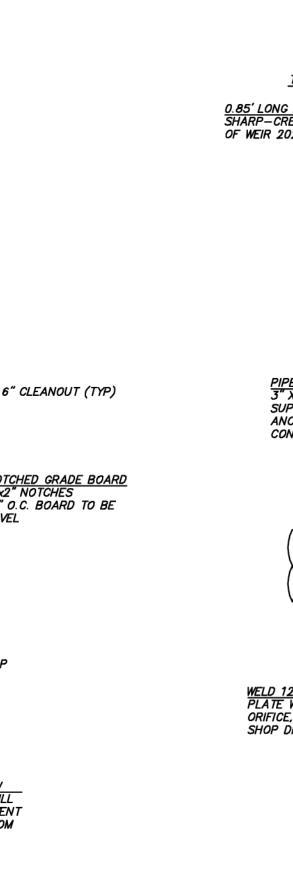

- 6" CLEANOUT (TYP) NOTCHED GRADE BOARD 2"x2" NOTCHES 18" O.C. BOARD TO BE WITH BIRDCAGE OVERFLOW PLAN ~ 1' MIN THICK RIP RAP PERMEABILITY BACKFILL AROUND CB TO PREVENT WATER INTRUSION FROM DISPERSAL TRENCH. SECTION B-B

CB 400 BUBBLE-UP WITH DISPERSION TRENCH (POND B7-A DUTFALL)

2" GRADE

BOARD NOTCHES

CLEAN (<5% FINES) 3/4" - 1 1/2" WASHED ROCK

6" PERFORATED PIPE LAID FLAT

SECTION A-A

- GALVANIZED BOLTS


2" X 12" PRESSURE TREATED

<u>1' THICK, 2' WIDE</u> RIP RAP PAD

AROUND CB

GRADE BOARD

TOP EL 2011.00

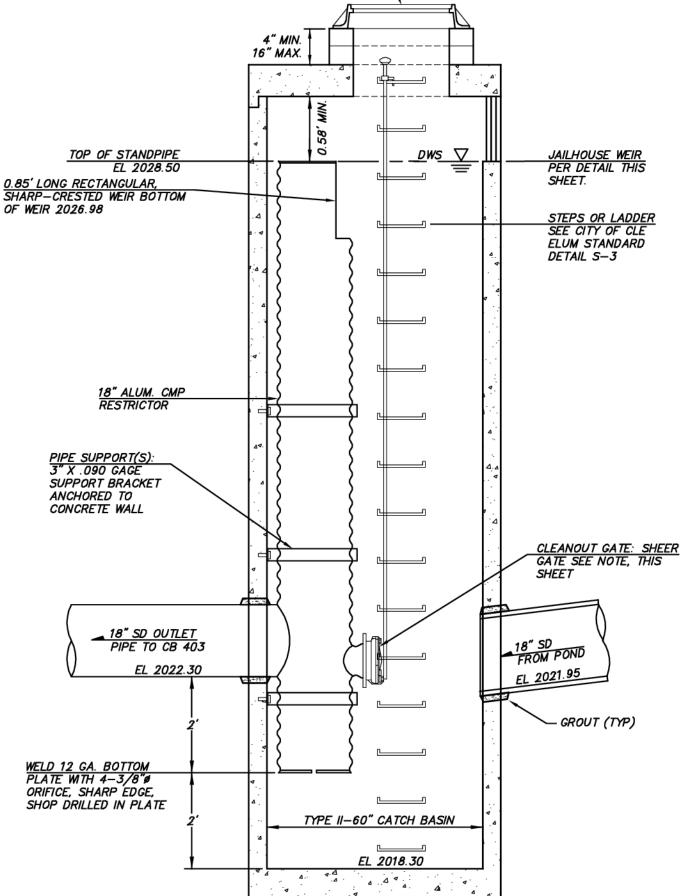

SECTION VIEW

CB 405, TYPE II-60" FLOW CONTROL STRUCTURE

STORM DRAIN OWNERSHIP

SEE NOTES ON SHEET GN-01.

CONTROL STRUCTURE NOTES

- PIPE SIZES AND SLOPES: PER PLANS.
- P. OUTLET CAPACITY: NOT LESS THAN COMBINED INLETS.
- EXCEPT AS SHOWN OR NOTED, UNITS SHALL BE CONSTRUCTED IN ACCORDANCE WITH THE REQUIREMENTS FOR CATCH BASIN TYPE 2, 60" MIN.
- PIPE SUPPORTS AND RESTRICTOR/SEPARATOR SHALL BE OF SAME MATERIAL, AND BE ANCHORED AT 3' MAX. SPACING BY 5/8" DIAM. STAINLESS STEEL EXPANSION BOLTS OR EMBEDDED 2" IN WALL.
- 5. THE RESTRICTOR/SEPARATOR SHALL BE FABRICATED FROM .060" ALUMINUM OR .064 ALUMINIZED STEEL, OR .064" GALVANIZED STEEL PIPE; IN ACCORDANCE WITH AASHTO M 36, M 196, M 197 AND M 274. GALVANIZED STEEL SHALL HAVE TREATMENT 1.
- OUTLET SHALL BE CONNECTED TO CULVERT OR SEWER PIPE WITH A STANDARD COUPLING BAND FOR CORRUGATED METAL PIPE, OR GROUTED INTO BELL FOR
- THE VERTICAL RISER STEM OF THE RESTRICTOR/SEPARATOR SHALL BE THE SAME DIA. AS THE HORIZONTAL OUTLET PIPE, WITH AN 8" MIN. DIA. EXCEPT AS OTHERWISE SHOWN ON PLAN.
- 3. FRAME AND LADDER OR STEPS OFFSET SO THAT;
- A. CLEANOUT GATE IS VISIBLE FROM TOP. B. CLIMB DOWN SPACE IS CLEAR OF RISER AND CLEANOUT GATE.
- C. FRAME IS CLEAR OF CURB.
- D. IF METAL OUTLET PIPE CONNECTS TO CEMENT CONCRETE PIPE: OUTLET PIPE TO HAVE SMOOTH O.D. EQUAL TO CONCRETE PIPE I.D. LESS 1/4".
- 10. ALL METAL PARTS CORROSION RESISTANT. NO GALVANIZED PARTS.
- STAINLESS STEEL PARTS AND ALUMINUM ARE ACCEPTABLE.

EXISTING UTILITY NOTE

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BLUELINE 25 CENTRAL WAY, SUITE 400,

KIRKLAND, WA 98033 P: 425.216.4051 F: 425.216.4052 WWW.THEBLUELINEGROUP.COM

SCALE: AS NOTED

PROJECT MANAGER: BRETT K. PUDISTS, PE

PROJECT ENGINEER: LYNDSEY FEDAK, PE DESIGNER:

CHRIS WISCOMB ISSUE DATE:

11/15/2021

11/15/21

19-349 PD-02

<u>25</u> of <u>48</u>

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NOTES

FLOWLINE).

REMAINS LEVEL.

1. THIS TRENCH SHALL BE CONSTRUCTED TO

PREVENT POINT DISCHARGE AND/OR EROSION.


50 FEET TO ONE ANOTHER (100 FEET ALONG

2. TRENCHES MAY BE PLACED NO CLOSER THAN

3. TRENCH AND GRADE BOARD MUST BE LEVEL. ALIGN TO FOLLOW CONTOURS OF SITE.


CONDITIONS TO ENSURE GRADE BOARD

4. SUPPORT POST SPACING AS REQUIRED BY SOIL

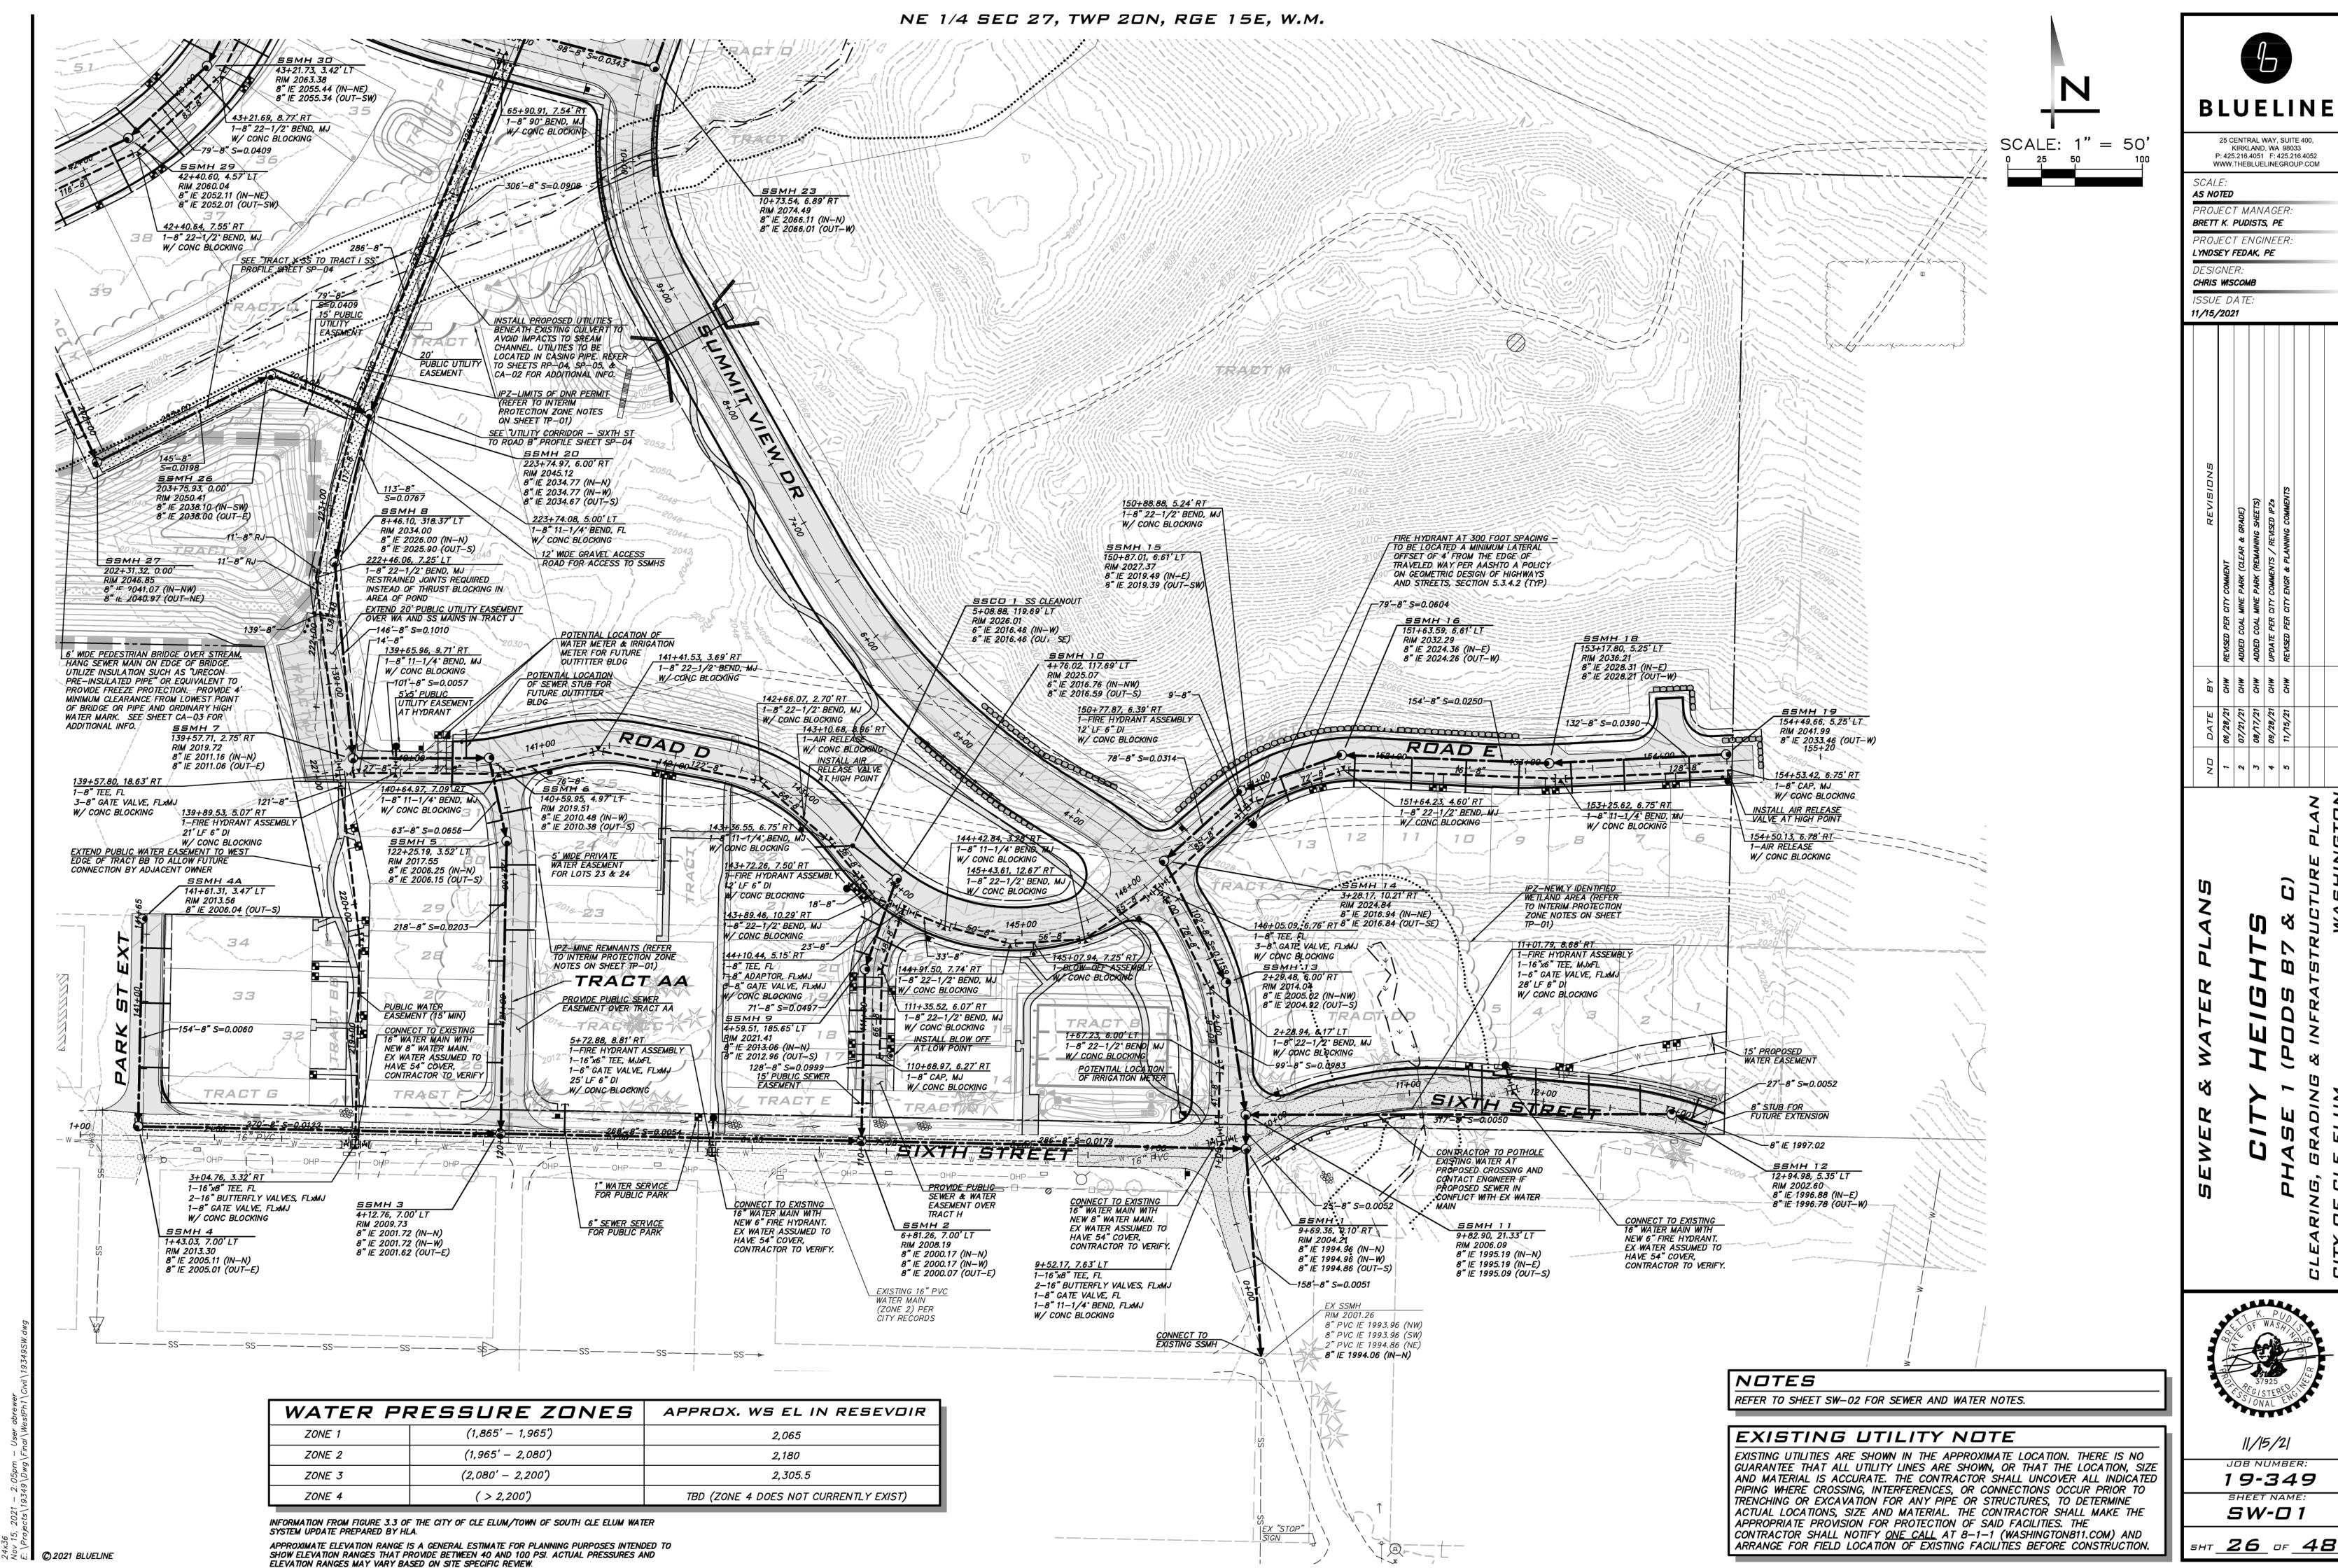

25 CENTRAL WAY, SUITE 400,

WWW.THEBLUELINEGROUP.COM

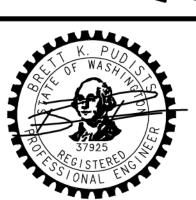

SHEET NAME: SW-01

WATER PRESENTE TONIES | APPROX WS ELIN RESEVOIR

BLUELINE

25 CENTRAL WAY, SUITE 400,

KIRKLAND, WA 98033 P: 425.216.4051 F: 425.216.4052

WWW.THEBLUELINEGROUP.COM

PROJECT MANAGER.

BRETT K. PUDISTS, PE

PROJECT ENGINEER.

LYNDSEY FEDAK, PE

AS NOTED

DESIGNER:

11/15/2021

CHRIS WISCOMB

SCALE: 1

11/15/21

19-349 SW-02

27 of 48

WATER NOTES

- WATER MAINS. PHASE 1 SERVED OFF OF ZONE 2
- PROVIDE AT LEAST 10' (OUTSIDE OF PIPE TO OUTSIDE OF PIPE) HORIZONTAL SEPARATION BETWEEN WATER AND SEWER.
- ALL WATER MAIN SHALL BE C-900 PIPE, SDR 18 MINIMUM UNLESS OTHERWISE APPROVED BY CITY.
- FIRE HYDRANTS SHALL BE SPACED NO GREATER THAN EVER 300'. FIRE
- HYDRANTS PER CITY OF CLE ELUM STANDARD DETAIL W-3. WATER LINES SHALL HAVE A MINIMUM DEPTH OF 54" TO CROWN OF PIPE.
- COVER ON EXISTING WATER MAINS ASSUMED TO BE 54" UNLESS OTHERWISE NOTED. CONTRACTOR TO VERIFY DEPTH AND LOCATION OF EXISTING UTILITIES PRIOR TO CONSTRUCTION AND NOTIFY ENGINEER IF CONFLICTS ARISE.
- TYPICAL RESIDENTIAL WATER SERVICE LINES ARE 1" WATER SERVICES SIZES SHALL BE CONFIRMED BY BUILDER PRIOR TO CONSTRUCTION. SERVICES FOR UNITS REQUIRING FIRE SPRINKLERS IF ANY, SHALL BE CONFIRMED BY BUILDER'S SPRINKLER DESIGNER PRIOR TO CONSTRUCTION.

- SEE SHEET GN-01 FOR CITY OF CLE ELUM GENERAL REQUIREMENTS FOR PER UNIFORM PLUMBING CODE, INDIVIDUAL PRVS TO BE ADDED AT BUILDING PERMIT STAGE TO KEEP HOME PLUMBING AT 80 PSI OR LESS.
 - RJ PIPE CALLED OUT IN PLAN VIEW AND ON PROFILES IS REQUIRED BECAUSE PIPE IN AREA OF FILL. • WATER METER SYMBOLS SHOWN ARE SCHEMATIC. WATER SERVICE PER

RELEASE VALVE PER CITY OF CLE ELUM STANDARD DETAIL W-5.

- CITY OF CLE ELUM STANDARD DETAIL W-6. AIR RELEASE VALVE REQUIRED AT HIGH POINTS IN WATER MAIN. AIR
- BLOW OFF OR FIRE HYDRANTS REQUIRED AT LOW POINTS IN WATER MAIN.
- BLOW OFF PER CITY OF CLE ELUM STANDARD DETAIL W-7.
- PROVIDE ETHAFOAM PADS AT PIPE CROSSINGS WHERE VERTICAL CLEARANCE IS LESS THAN 1'.
- IRRIGATION SERVICES AND METERS TO BE SIZED BY IRRIGATION DESIGNER AND INCLUDED DOH APPROVED BACKFLOW PREVENTER (TYP)

SEWER NOTES

3-8" GÅTE VALVE, FLXMJ

W/ CONC BLOCKING 139+89.53, 5.07' RT

SEE SHEET GN-01 FOR CITY OF CLE ELUM GENERAL REQUIREMENTS FOR SANITARY SEWER MAINS.

- SEWER MAIN TO BE 8" PVC AT 0.5% SLOPE OR GREATER UNLESS OTHERWISE NOTED.
- SEWER SERVICES TO BE 6" PVC AT 2" SLOPE OR GREATER. MAX LENGTH
- OF SIDE SEWER IS 150' FROM MAIN. SEWER CLEAN OUTS IN ROADWAYS TO HAVE TRAFFIC RATED FRAME AND
- GRATE MARKED "SEWER".

PROVIDE 10' (OUTSIDE OF PIPE TO OUTSIDE OF PIPE) SEPARATION

VERTICAL SEPARATION BETWEEN PIPES UNLESS OTHERWISE NOTED.

- BETWEEN SEWER MAIN AND POTABLE WATER MAIN. SEWER TO BE PLACED BELOW WATER CROSSINGS WITH AT LEAST 1.5'
- PROVIDE 1' PREFERRED VERTICAL SEPARATION BETWEEN SEWER MAIN AND STORM MAIN. SEPARATION MAY BE REDUCED TO BETWEEN 0.50' AND 0.99' WITH USE OF AN ETHAFOAM PAD AT CROSSING. USE FULL STICK OF PIPE CENTERED ON CROSSING WHERE SEPARATION IS LESS THAN 1'.

WAIER PR	RESSURE ZUNES	APPRUX. WS EL IN RESEVUIR
ZONE 1 (1,865' – 1,965')		2,065
ZONE 2 (1,965' - 2,080')		2,180
ZONE 3	(2,080' - 2,200')	2,305.5
ZONE 4 (> 2,200')		TBD (ZONE 4 DOES NOT CURRENTLY EXIST)

INFORMATION FROM FIGURE 3.3 OF THE CITY OF CLE ELUM/TOWN OF SOUTH CLE ELUM WATER SYSTEM UPDATE PREPARED BY HLA.

RIM 2019.51


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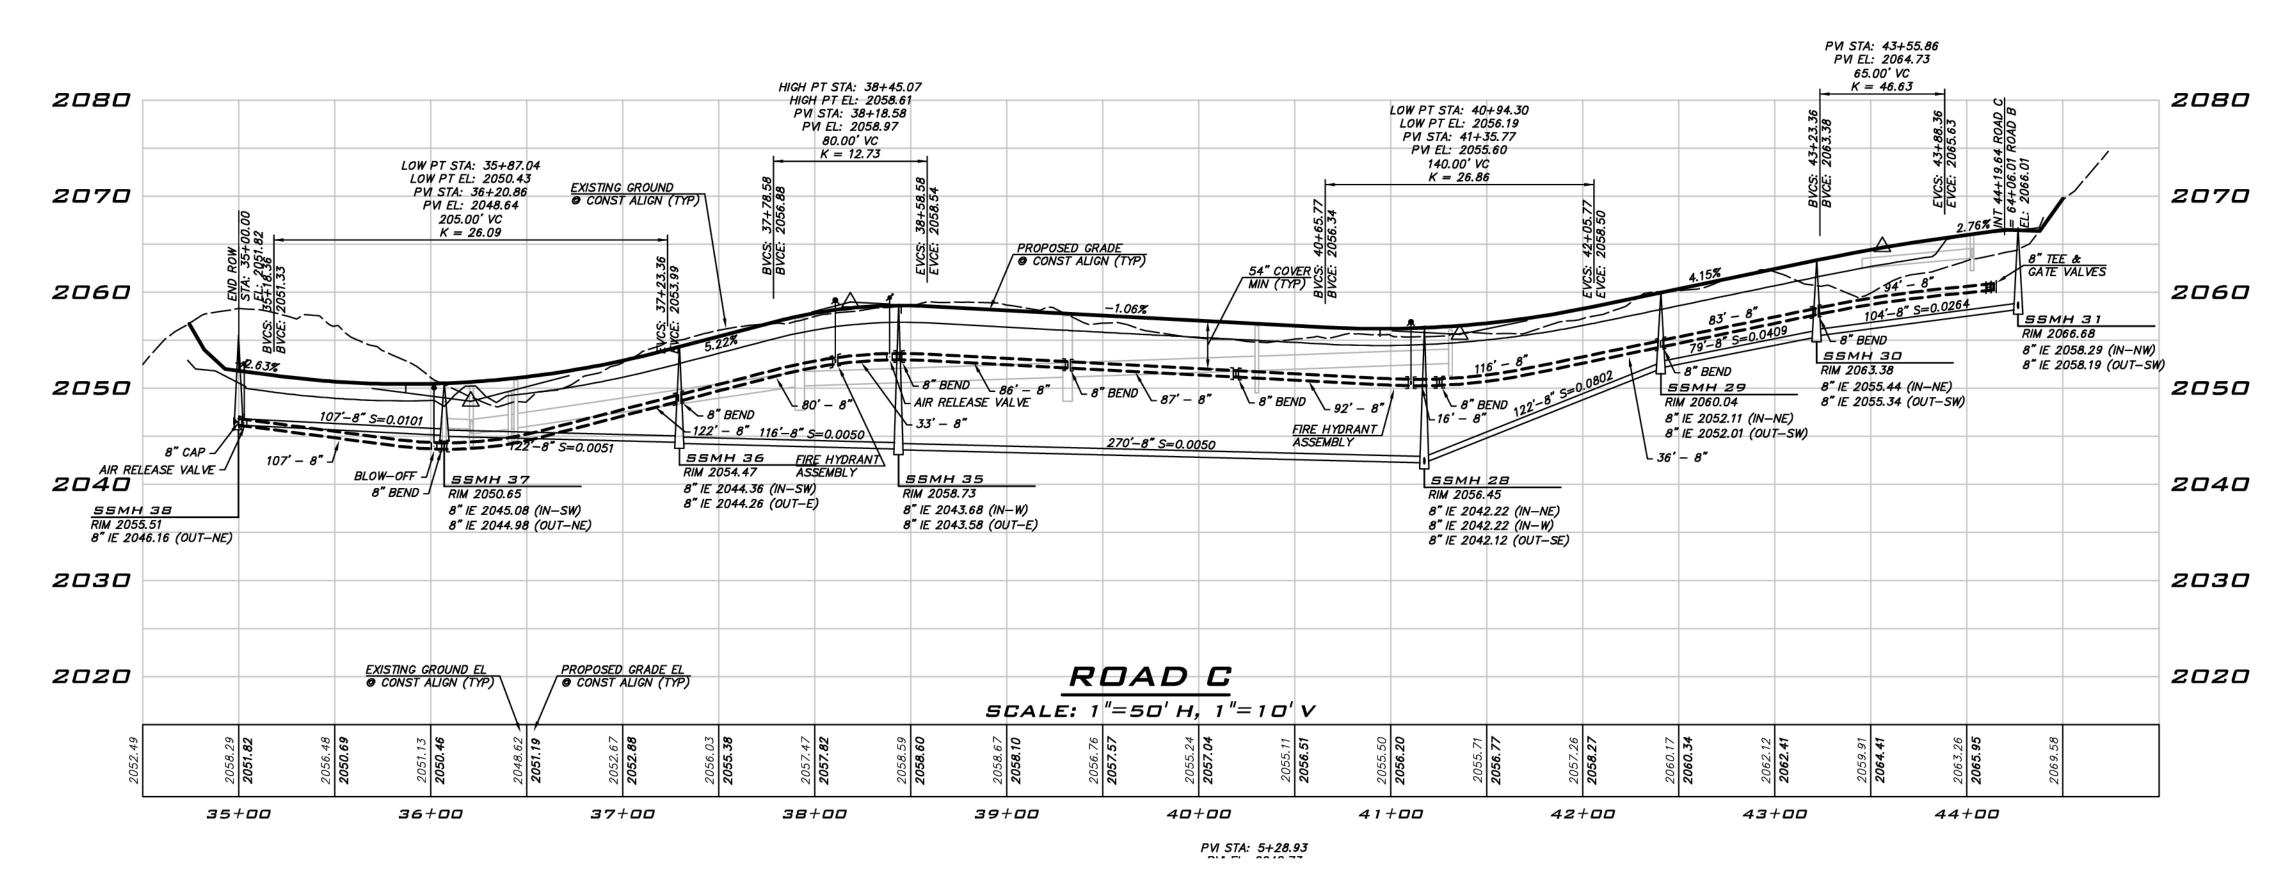
W/ CONC BLOCKING

APPROXIMATE ELEVATION RANGE IS A GENERAL ESTIMATE FOR PLANNING PURPOSES INTENDED TO SHOW ELEVATION RANGES THAT PROVIDE BETWEEN 40 AND 100 PSI. ACTUAL PRESSURES AND ELEVATION RANGES MAY VARY BASED ON SITE SPECIFIC REVIEW.

EXISTING UTILITY NOTE

EXISTING UTILITIES ARE SHOWN IN THE APPROXIMATE LOCATION. THERE IS NO GUARANTEE THAT ALL UTILITY LINES ARE SHOWN, OR THAT THE LOCATION, SIZE AND MATERIAL IS ACCURATE. THE CONTRACTOR SHALL UNCOVER ALL INDICATED PIPING WHERE CROSSING, INTERFERENCES, OR CONNECTIONS OCCUR PRIOR TO TRENCHING OR EXCAVATION FOR ANY PIPE OR STRUCTURES, TO DETERMINE ACTUAL LOCATIONS, SIZE AND MATERIAL. THE CONTRACTOR SHALL MAKE THE APPROPRIATE PROVISION FOR PROTECTION OF SAID FACILITIES. THE CONTRACTOR SHALL NOTIFY ONE CALL AT 8-1-1 (WASHINGTON811.COM) AND ARRANGE FOR FIELD LOCATION OF EXISTING FACILITIES BEFORE CONSTRUCTION.



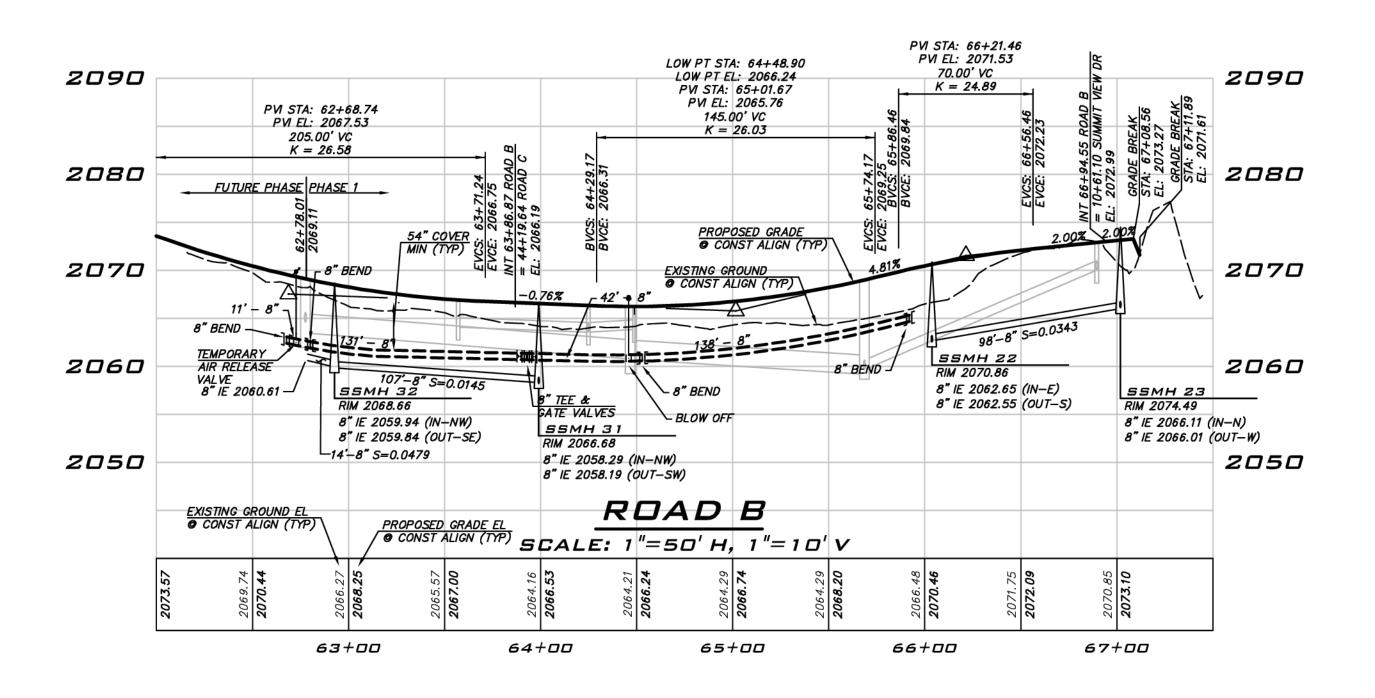

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25 CENTRAL WAY, SUITE 400, KIRKLAND, WA 98033 P: 425.216.4051 F: 425.216.4052

WWW.THEBLUELINEGROUP.COM SCALE:

AS NOTED PROJECT MANAGER: BRETT K. PUDISTS, PE

PROJECT ENGINEER: LYNDSEY FEDAK, PE

DESIGNER:

CHRIS WISCOMB ISSUE DATE: 11/15/2021


11/15/21


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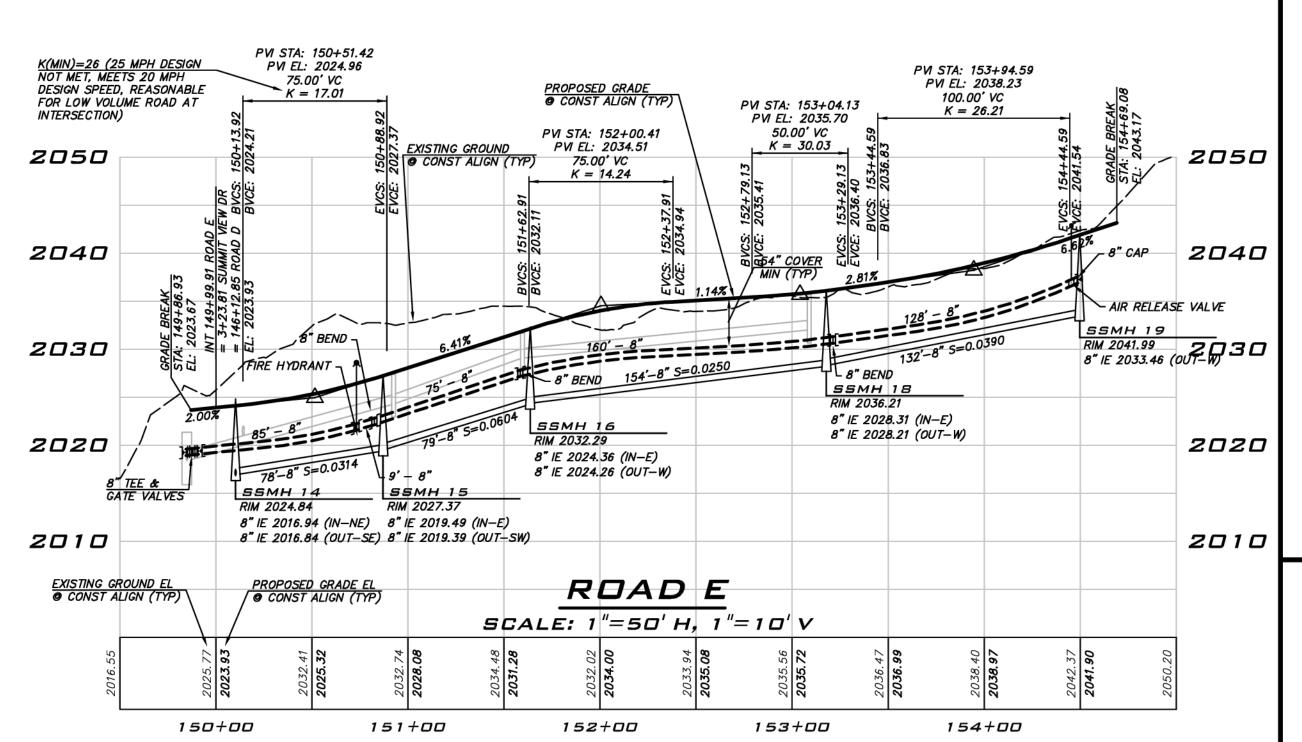
19-349 SHEET NAME: SP-01

sнт <u>28</u> оғ <u>48</u>

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BLUELINE

25 CENTRAL WAY, SUITE 400, KIRKLAND, WA 98033
P: 425-216-4015; F-225-216-4052
WWW.THEBLUELINEGROUP.COM

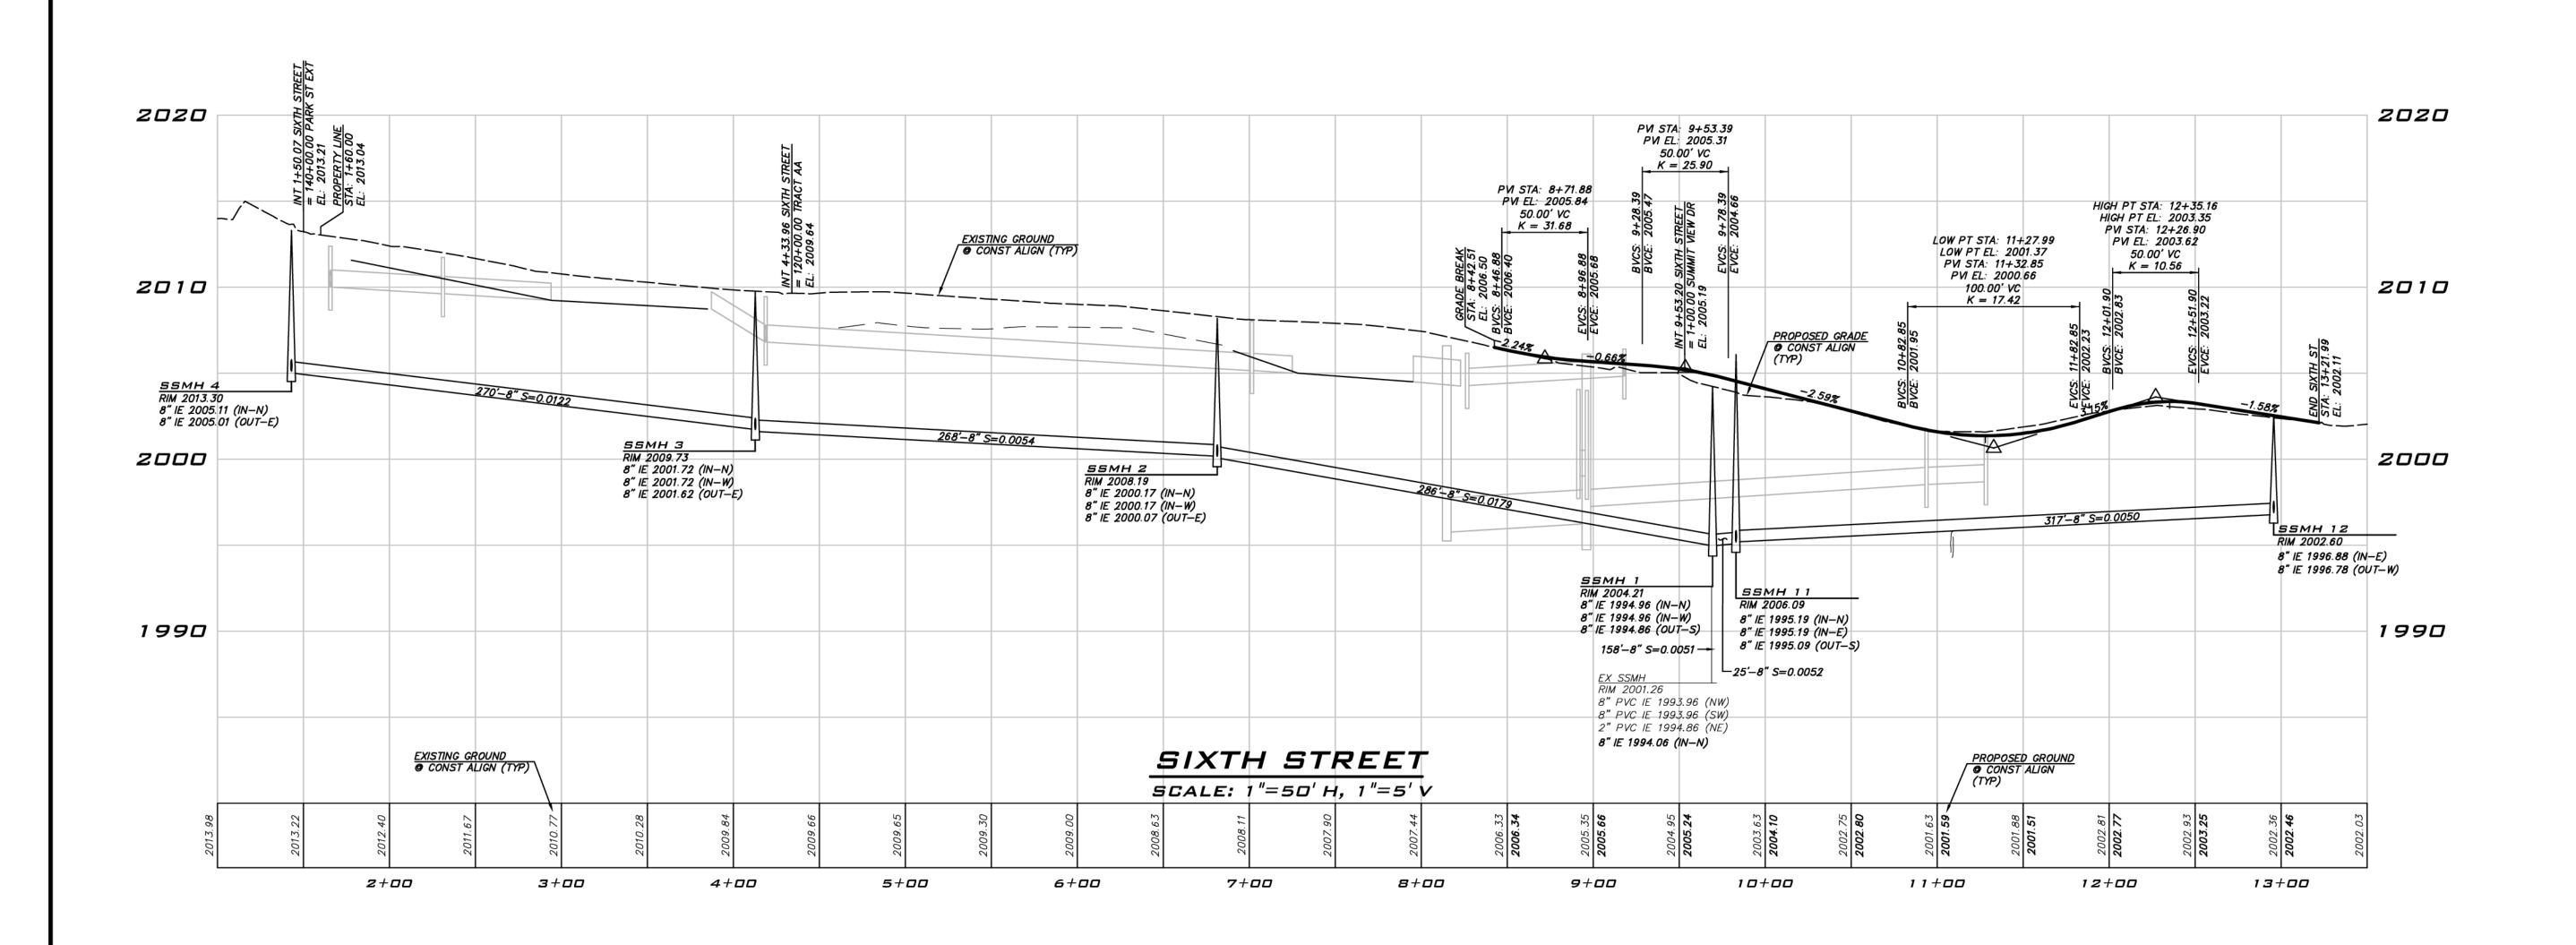SCALE:
AS NOTED

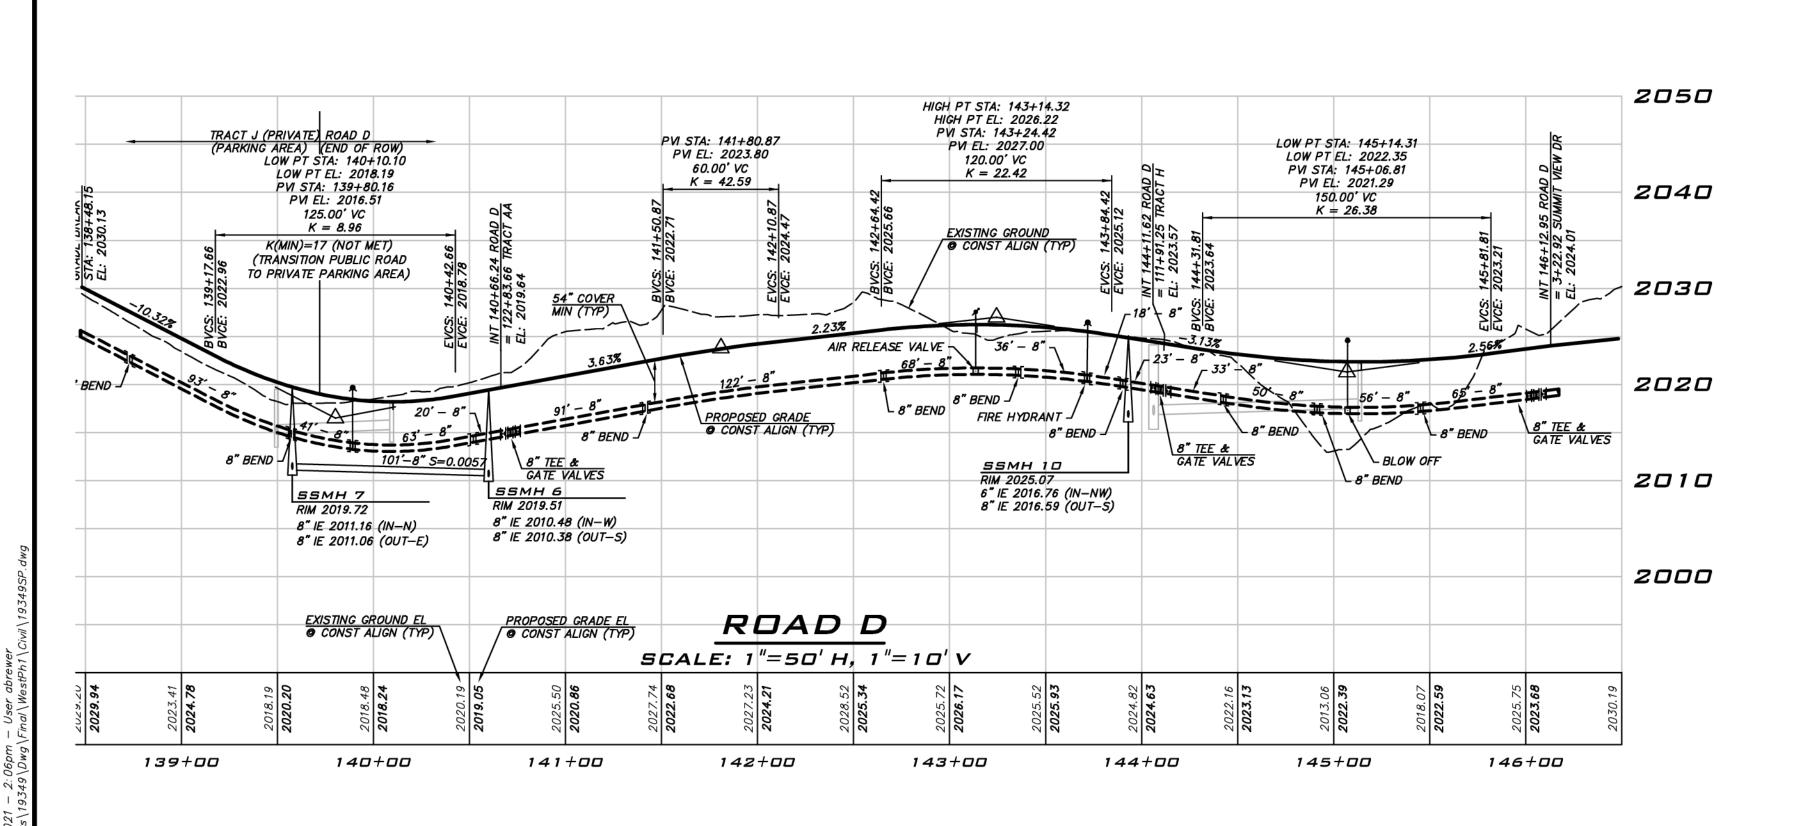PROJECT MANAGER:
BRETT K. PUDISTS, PE

PROJECT ENGINEER:
LYMDSEY FEDAK, PE

DESIGNER:
CHRIS WISCOMB

ISSUE DATE:
11/15/2021

1/15/2021

A RENZED PER CITY COMMENTS

ISSUE OHW REVISED PROJECT

11/15/2021

CITY HEIGHTS
PHASE 1 (PODS B7 & C)
NG, GRADING & INFRATSTRUCTURE PL

X. PUO WASHING 37925 SIONAL ENGLISHED

11/15/21


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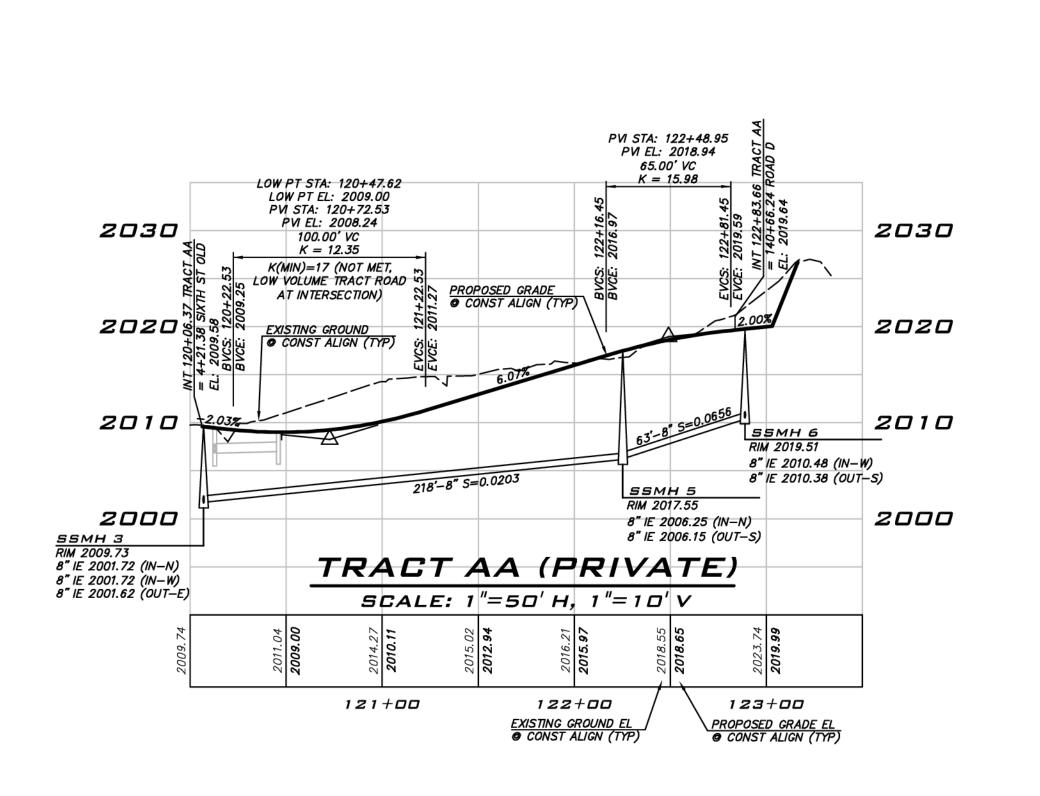
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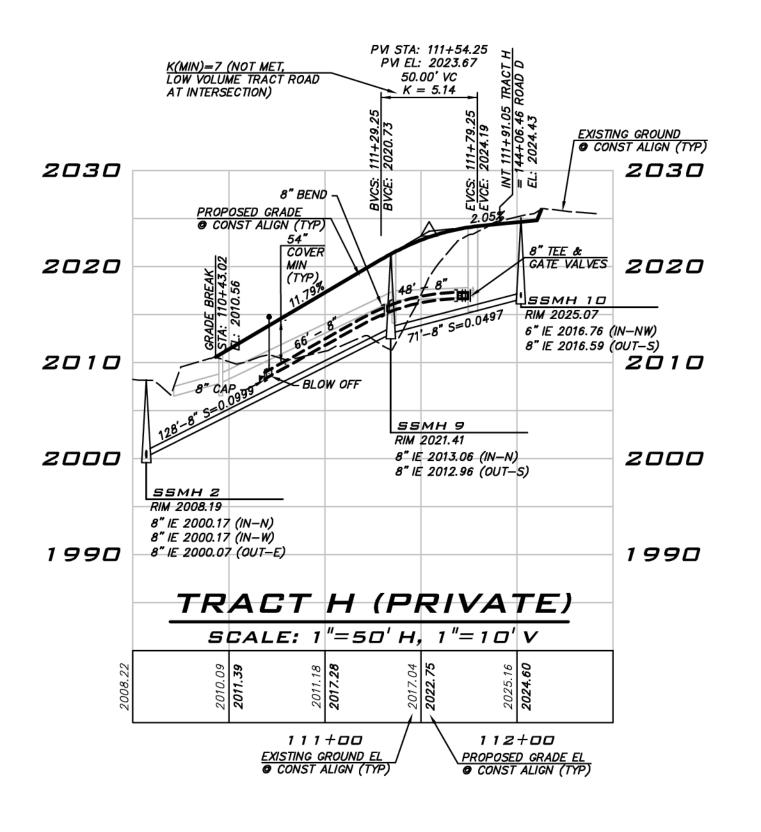
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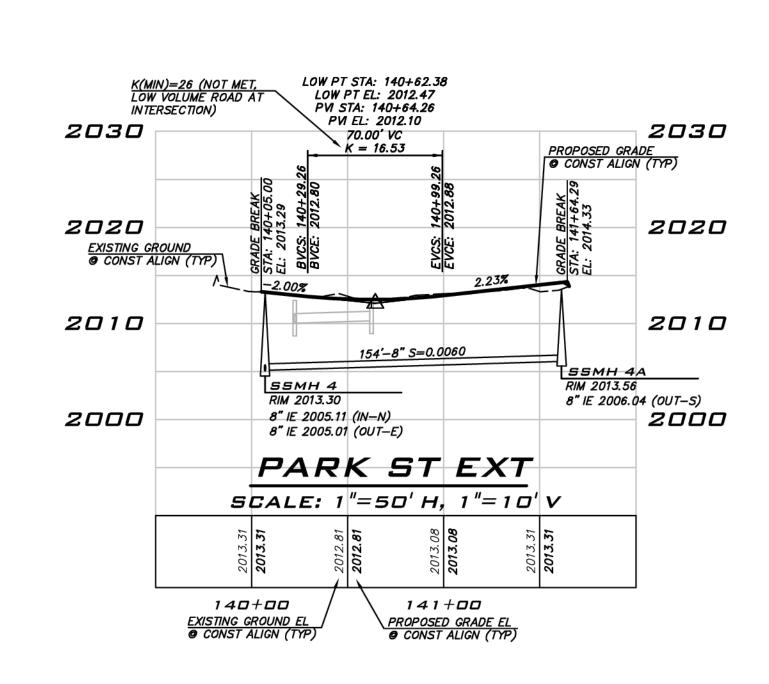
02021 BLUELINE

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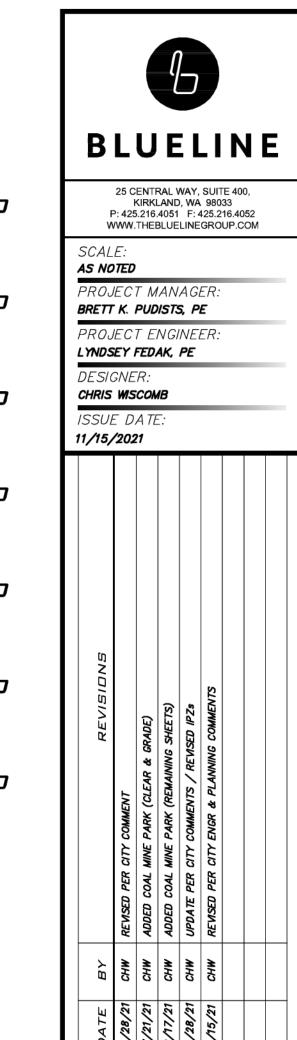






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CITY HEIGHTS HASE 1 (PODS B7 & C)

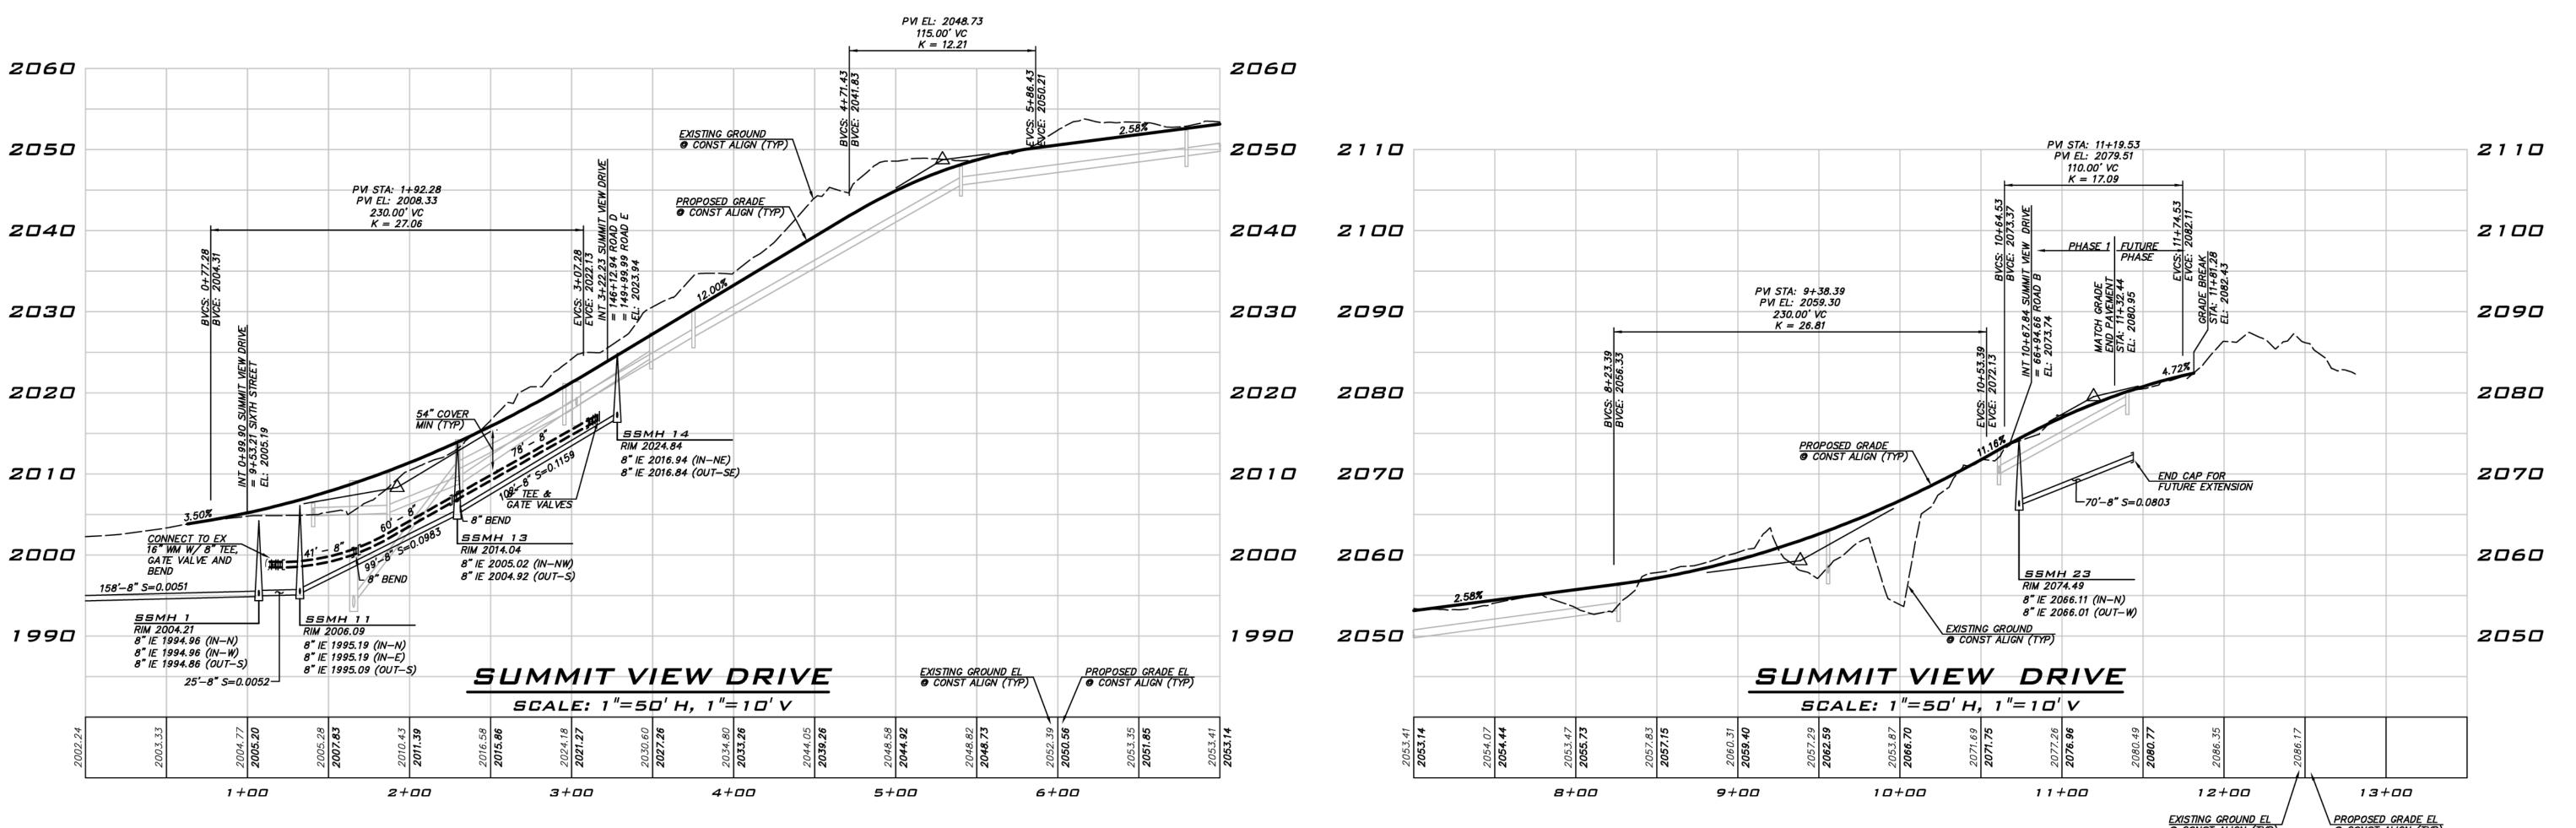
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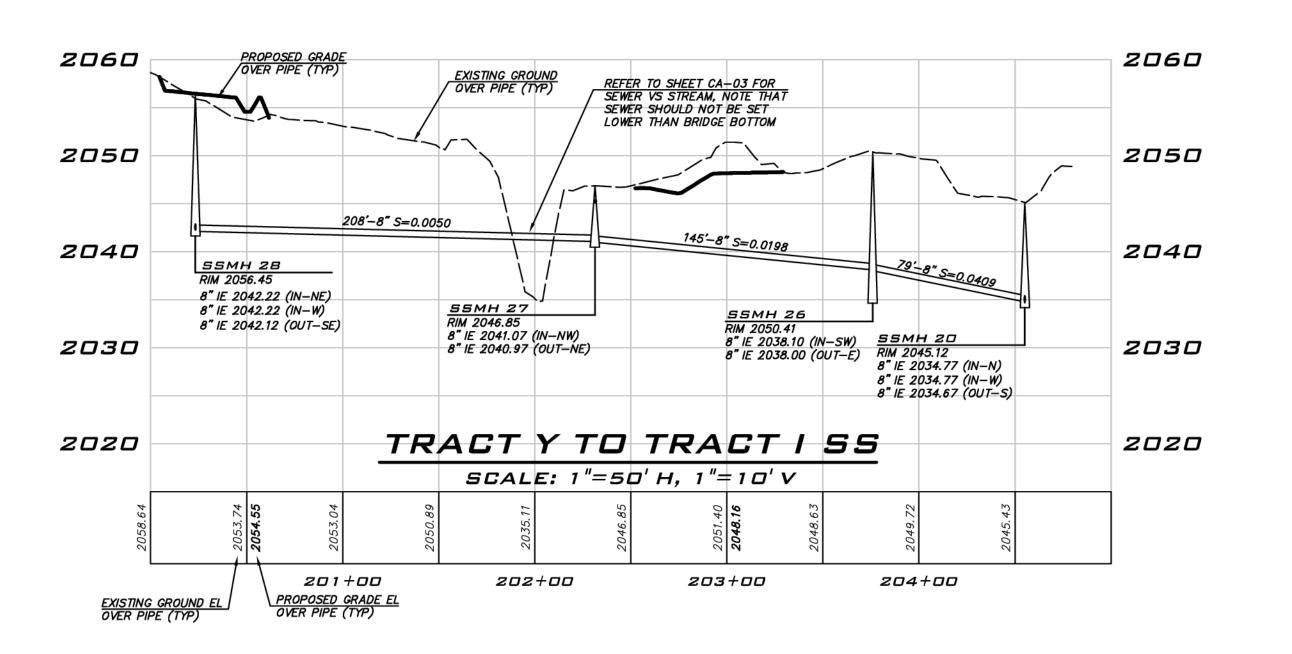
K. PUD WASHING WASH

11/15/21

19-349 SHEET NAME: SP-03

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CASING NOTES

- C-900 CASING DIAMETER TO BE A MINIMUM OF 4" LARGER THAN THE CARRIER (SEWER/WATER/STORM) PIPE DIAMETER. CONTRACTOR TO CONFIRM FILL MATERIAL FOR SPACE BETWEEN CARRIER PIPE AND CASING.
- CASING TO HAVE CASING SPACERS INSTALLED PER MANUFACTURER'S RECOMMENDATIONS.
- PROVIDE END SEAL BETWEEN CARRIER PIPE (SEWER/WATER/STORM) AND CASING (UNLESS CASING IS GROUTED).
- CONTRACTOR TO PROVIDE CUT SHEETS AND/OR SHOP DRAWINGS ON SPACERS, CASINGS, END SEALS AND GROUT PRIOR TO CONSTRUCTION.

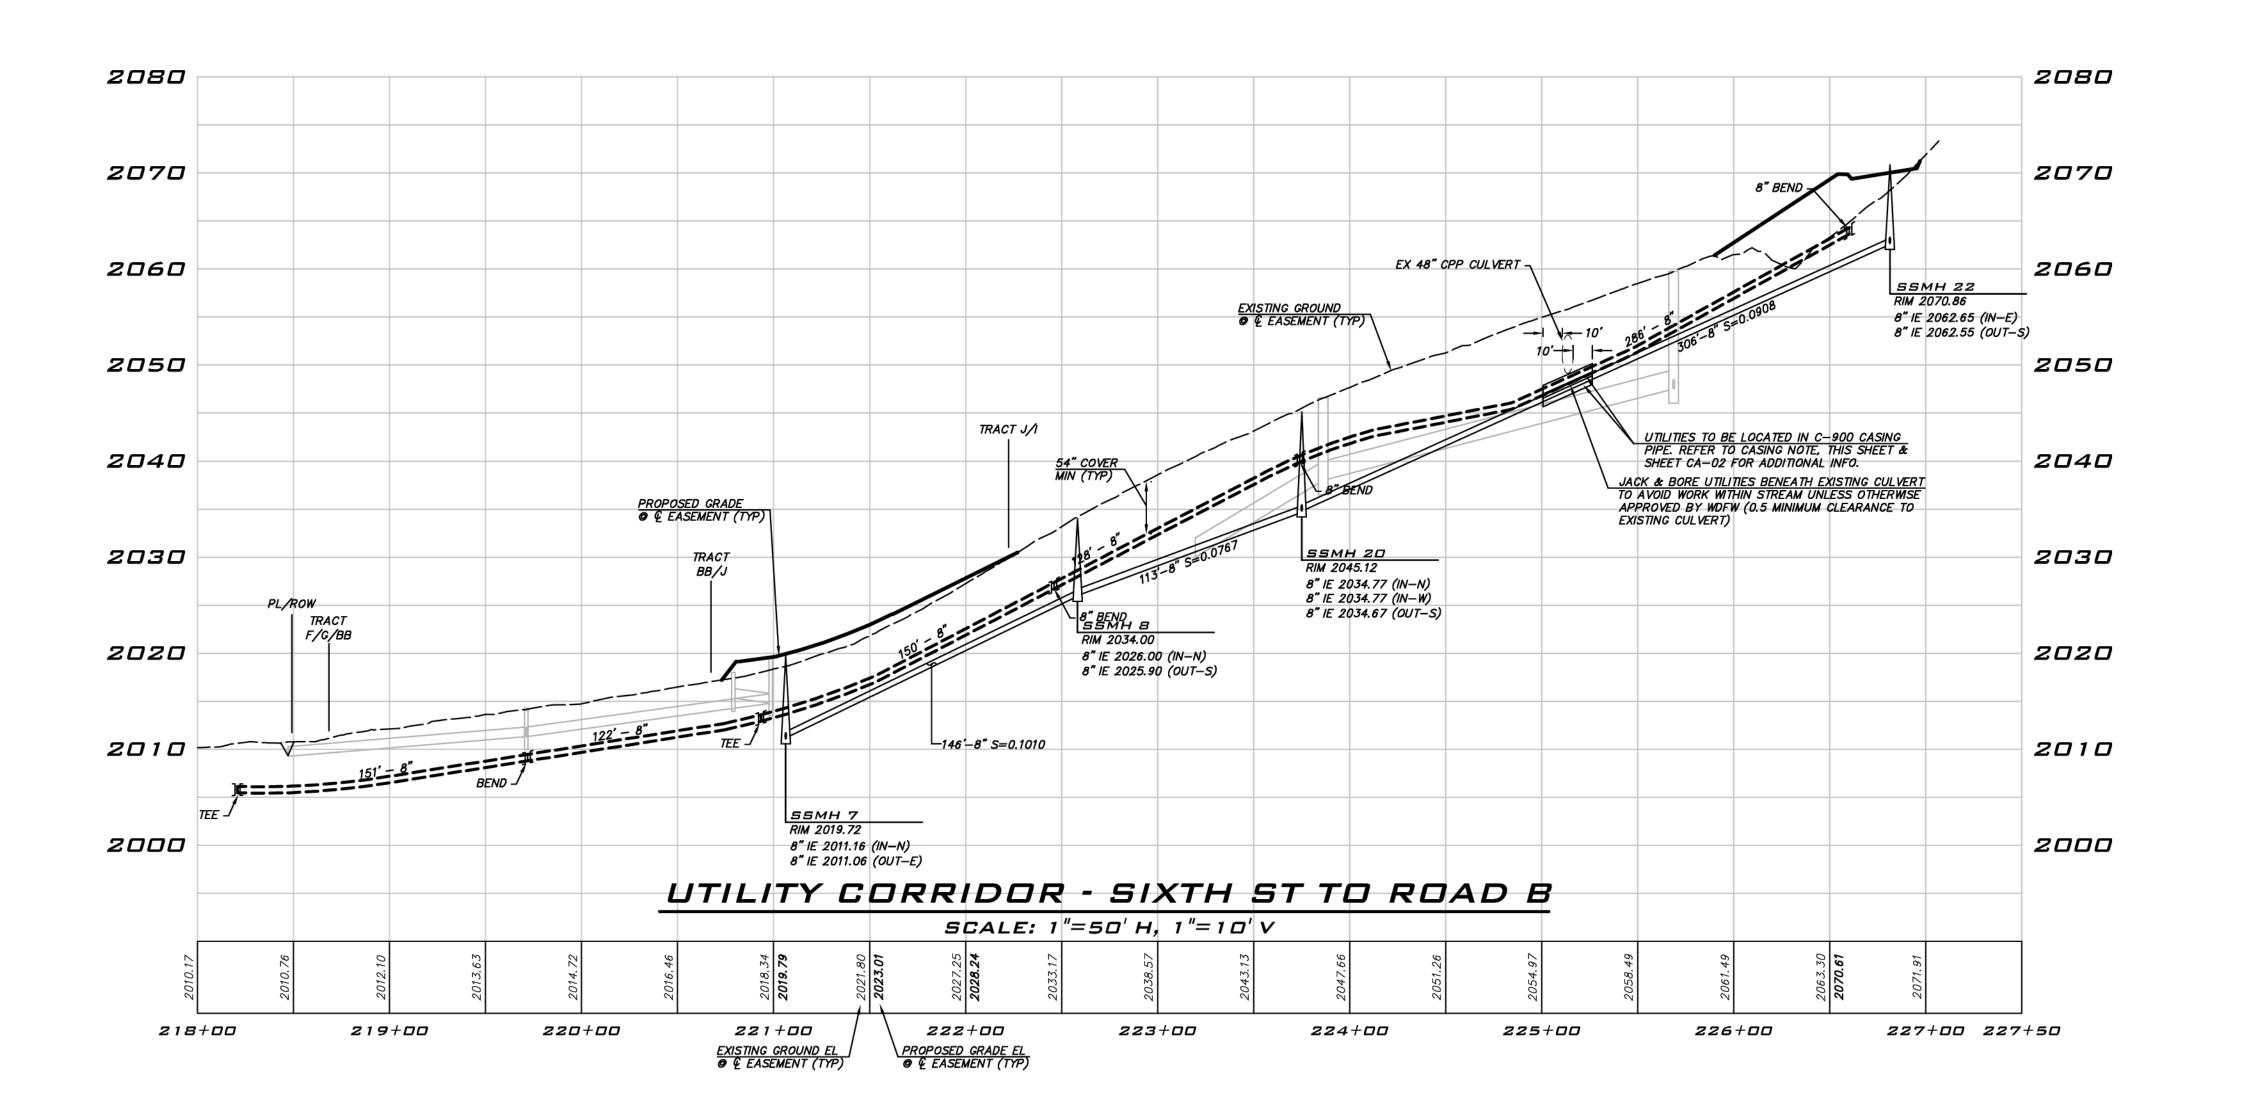EXISTING UTILITY NOTE

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25 CENTRAL WAY, SUITE 400, KIRKLAND, WA 98033 P: 425.216.4051 F: 425.216.4052 WWW.THEBLUELINEGROUP.COM

AS NOTED

PROJECT MANAGER: BRETT K. PUDISTS, PE

PROJECT ENGINEER: LYNDSEY FEDAK, PE

CHRIS WISCOMB


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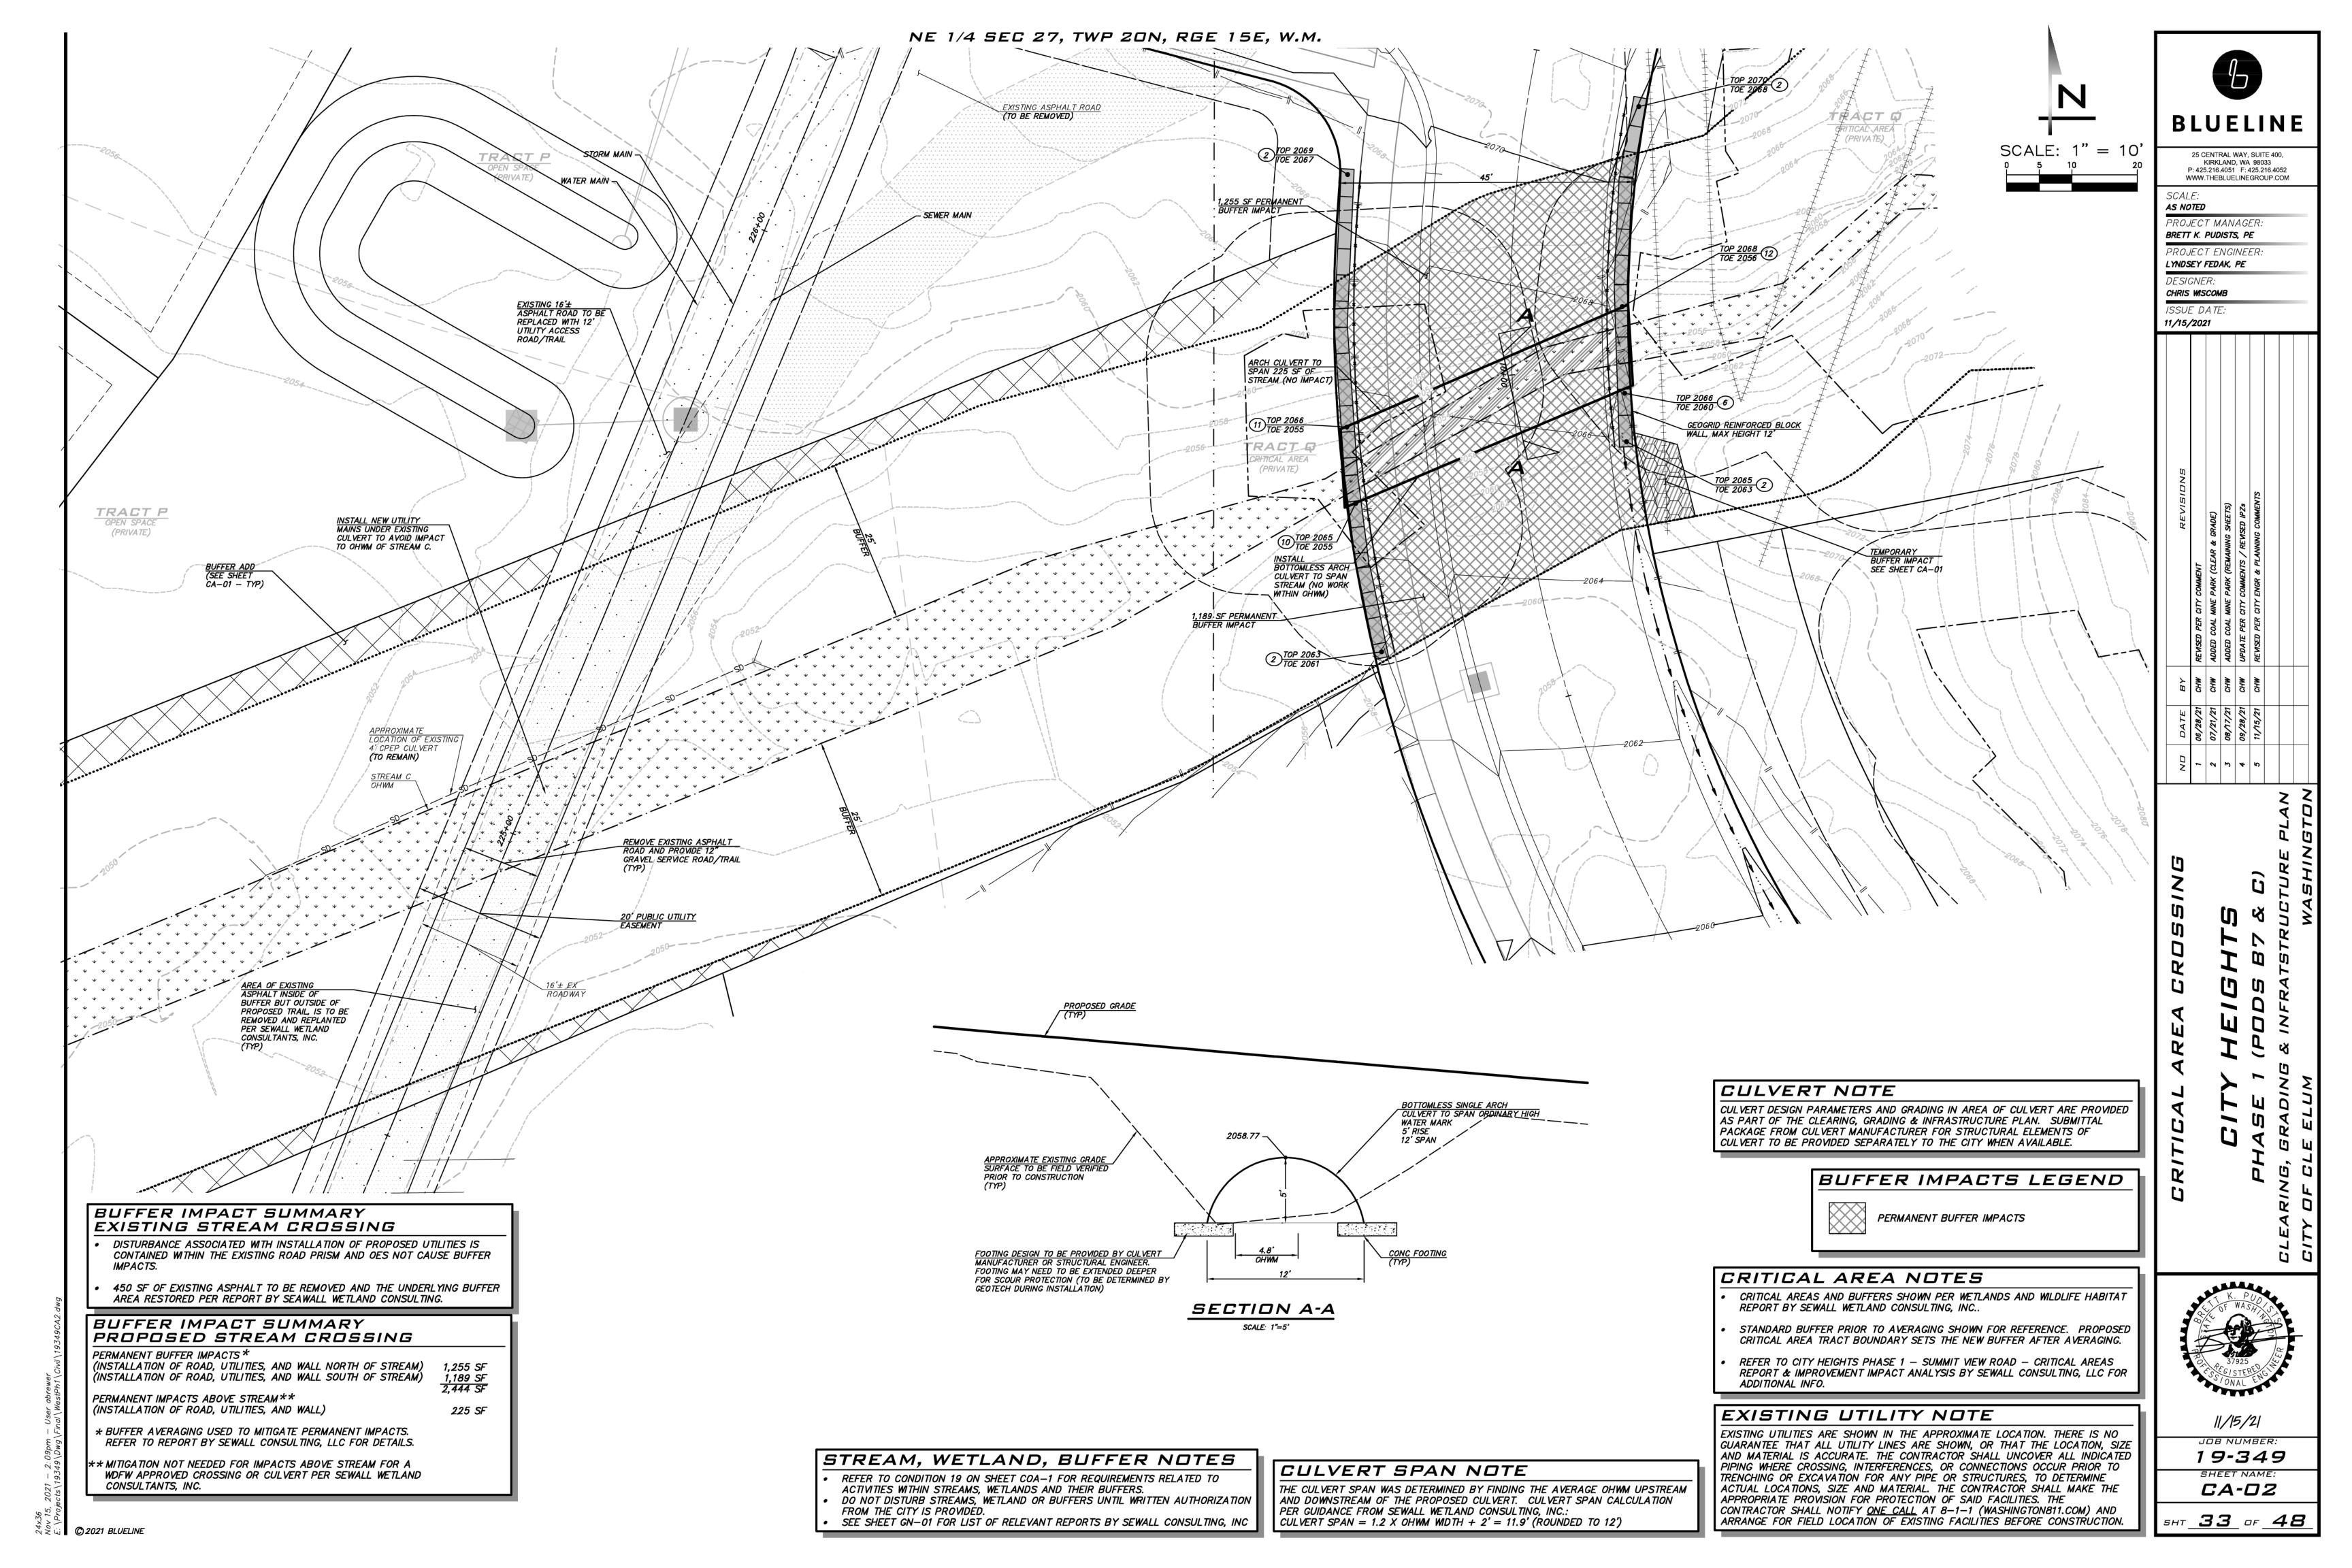
11/15/21


19-349 SHEET NAME: SP-04


sнт <u>**31</u> ог <u>48</u></u>**

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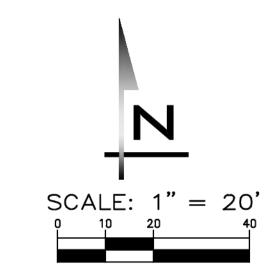


* BUFFER AVERAGING USED TO MITIGATE PERMANENT INAPOCTS. REFER TO

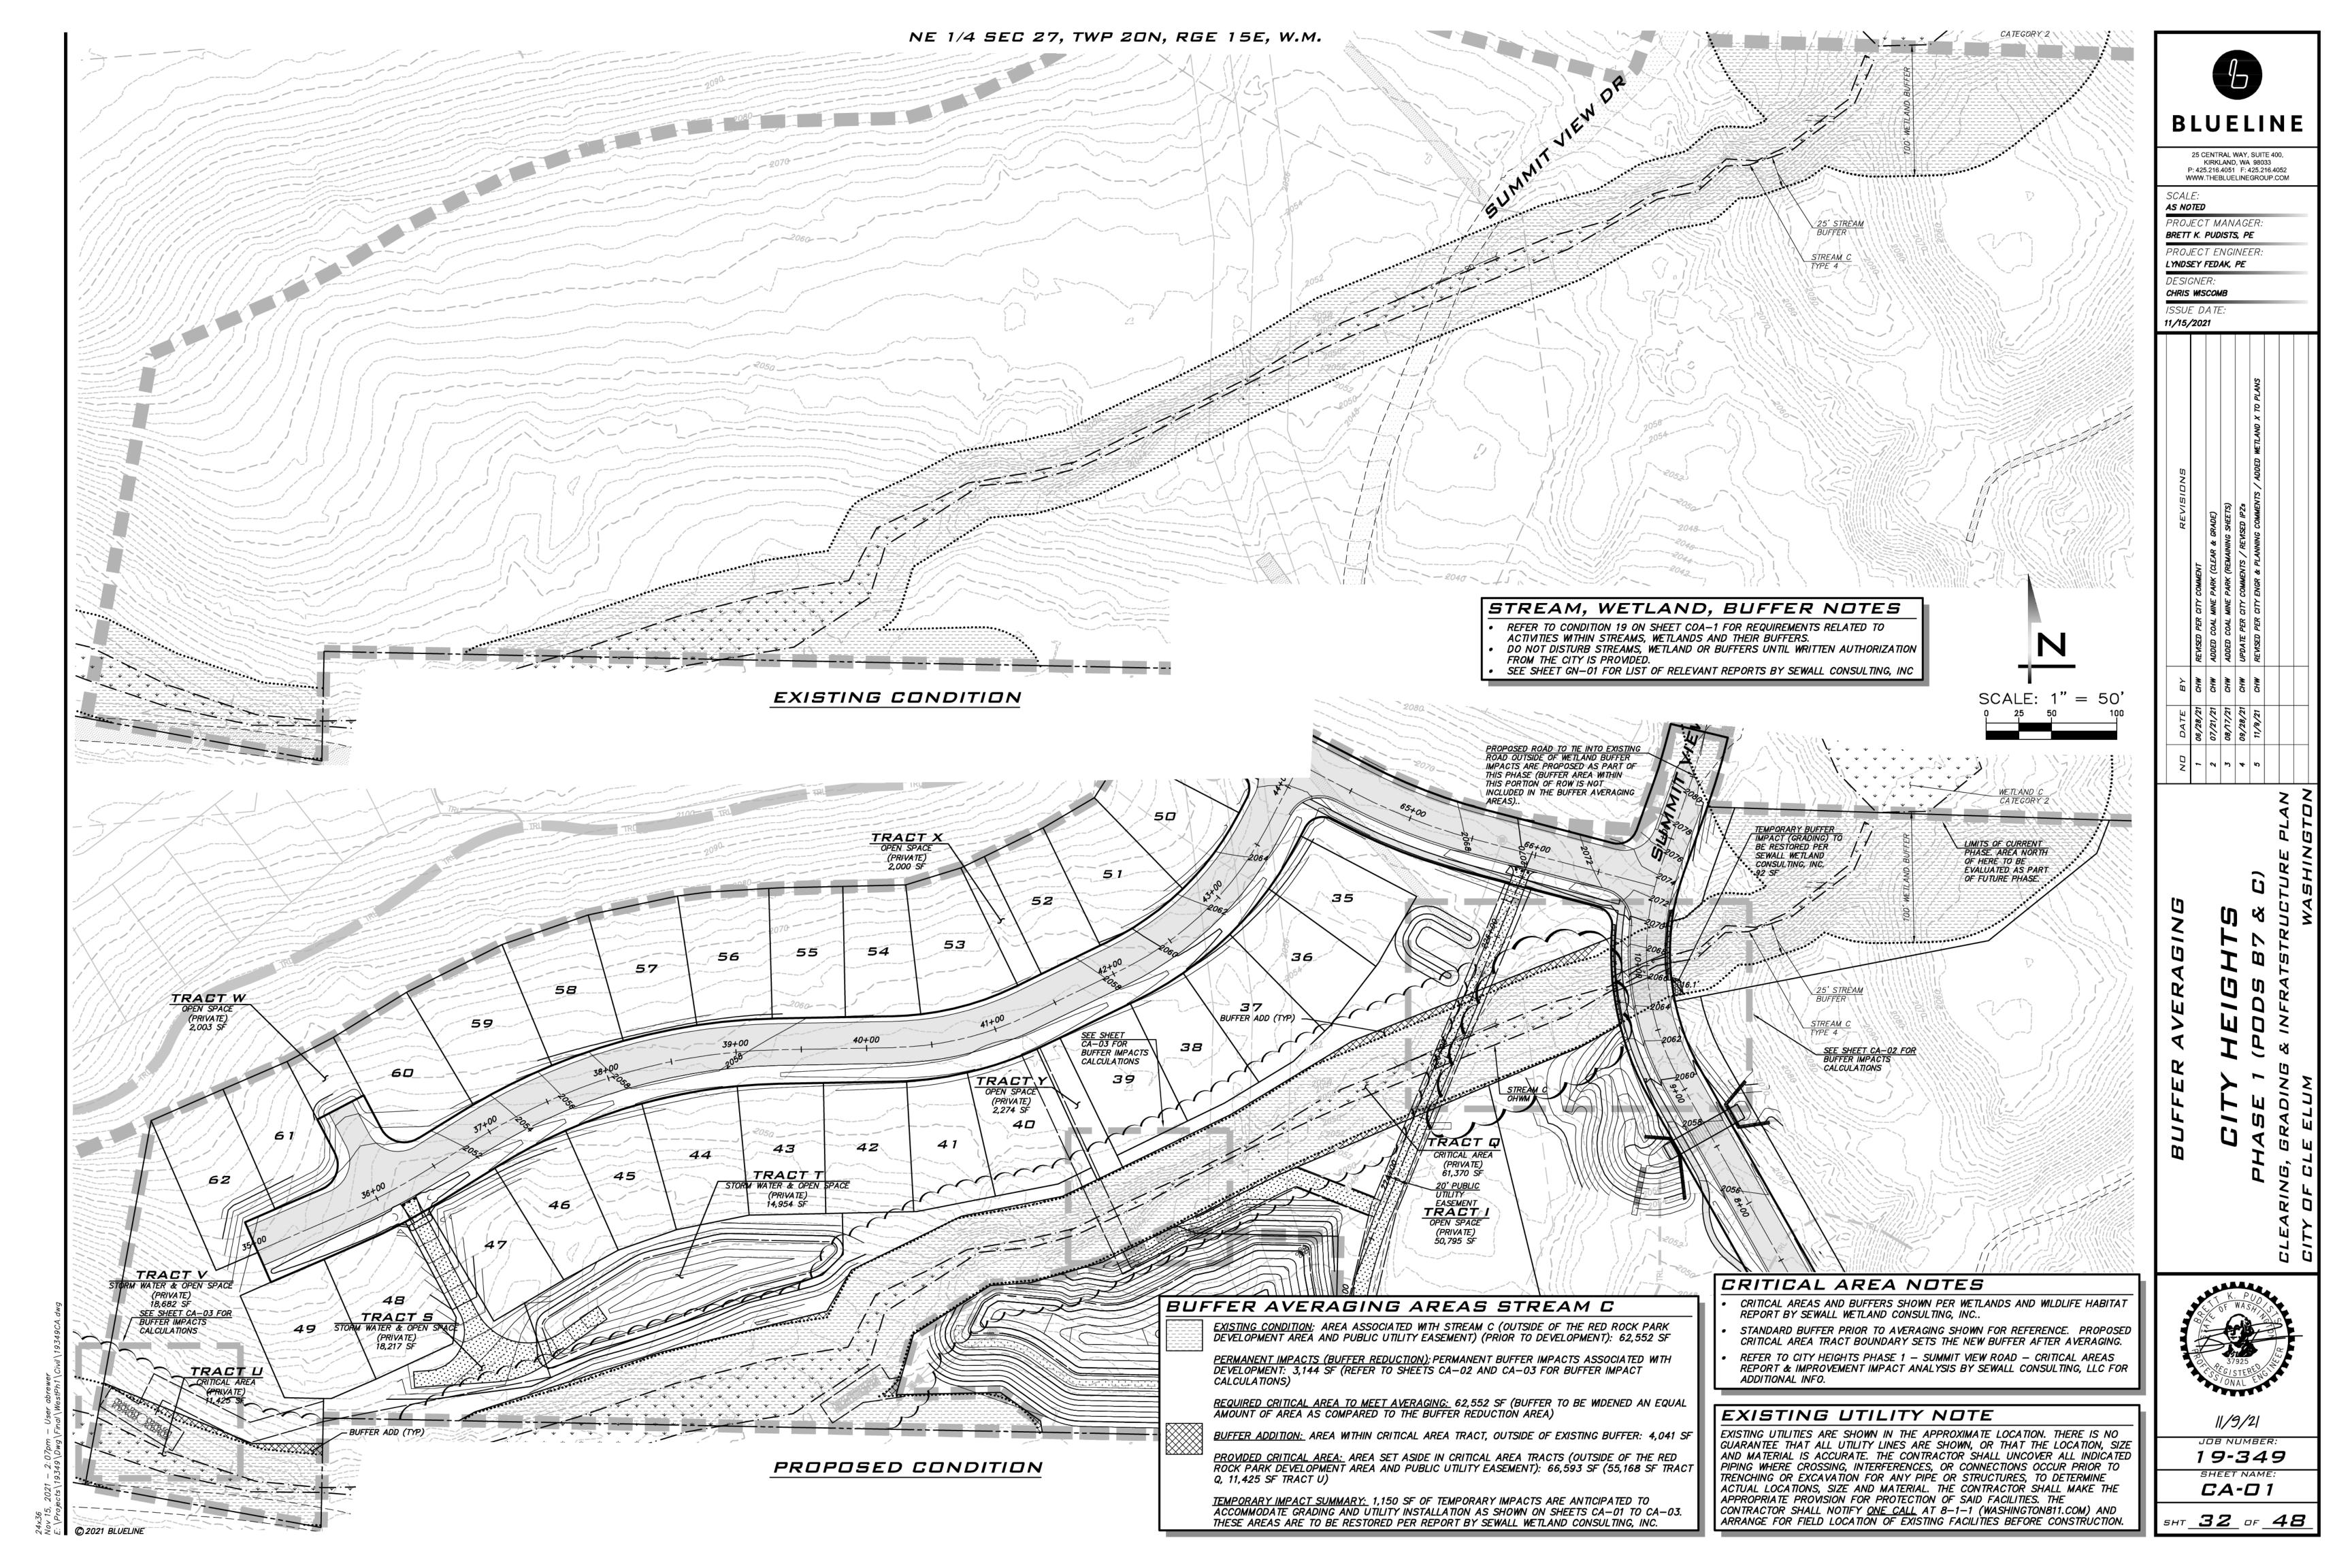RESTORATION OF TEMPORARY BUFFER IMPACTS PER SEWALL WETLAND

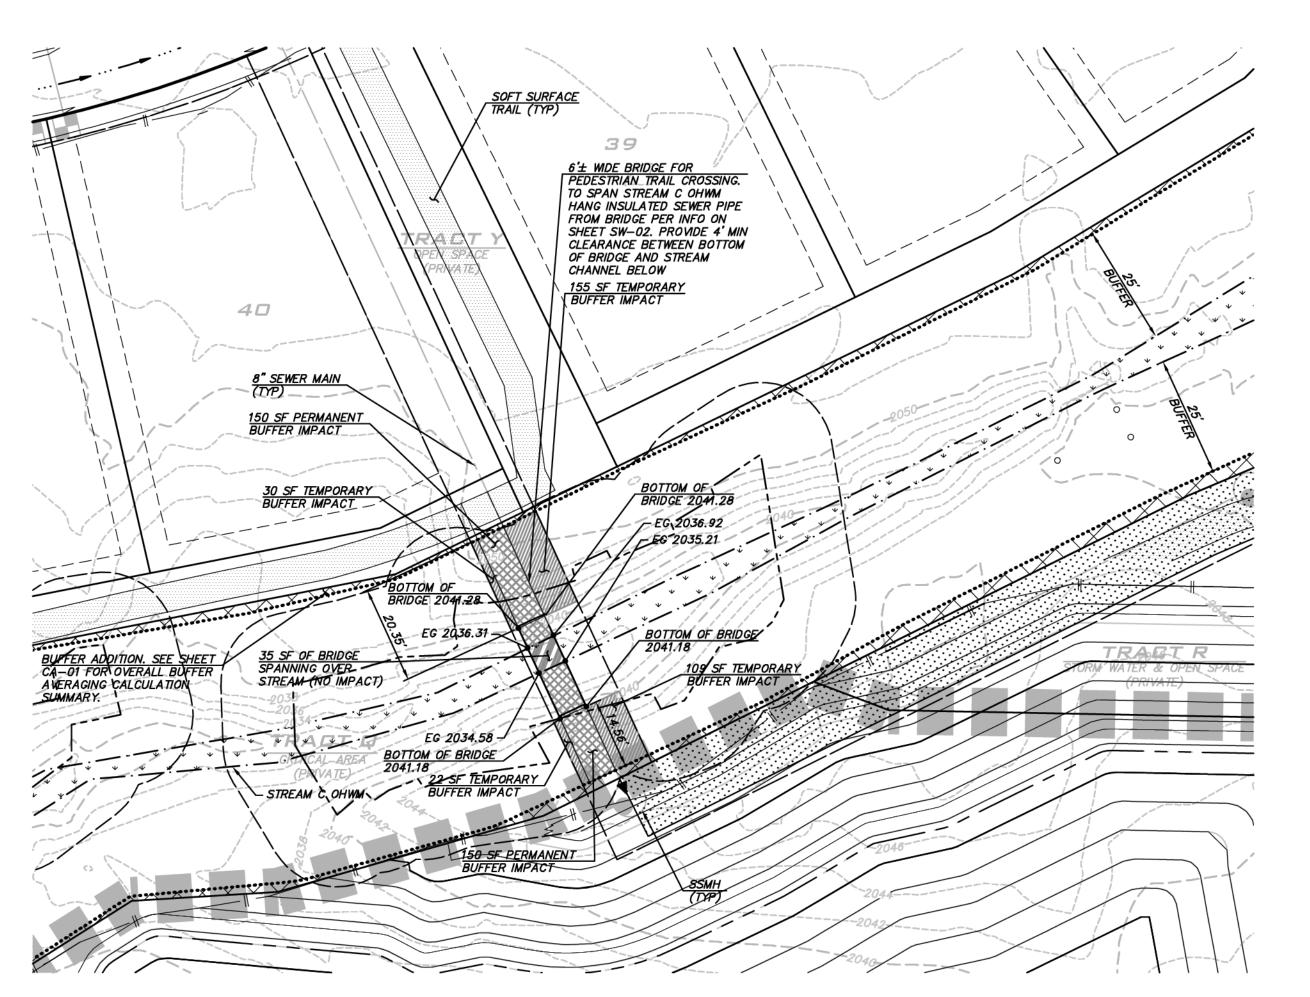REPORT BY SEWALL CONSULTING, LLC FOR DETAILS.

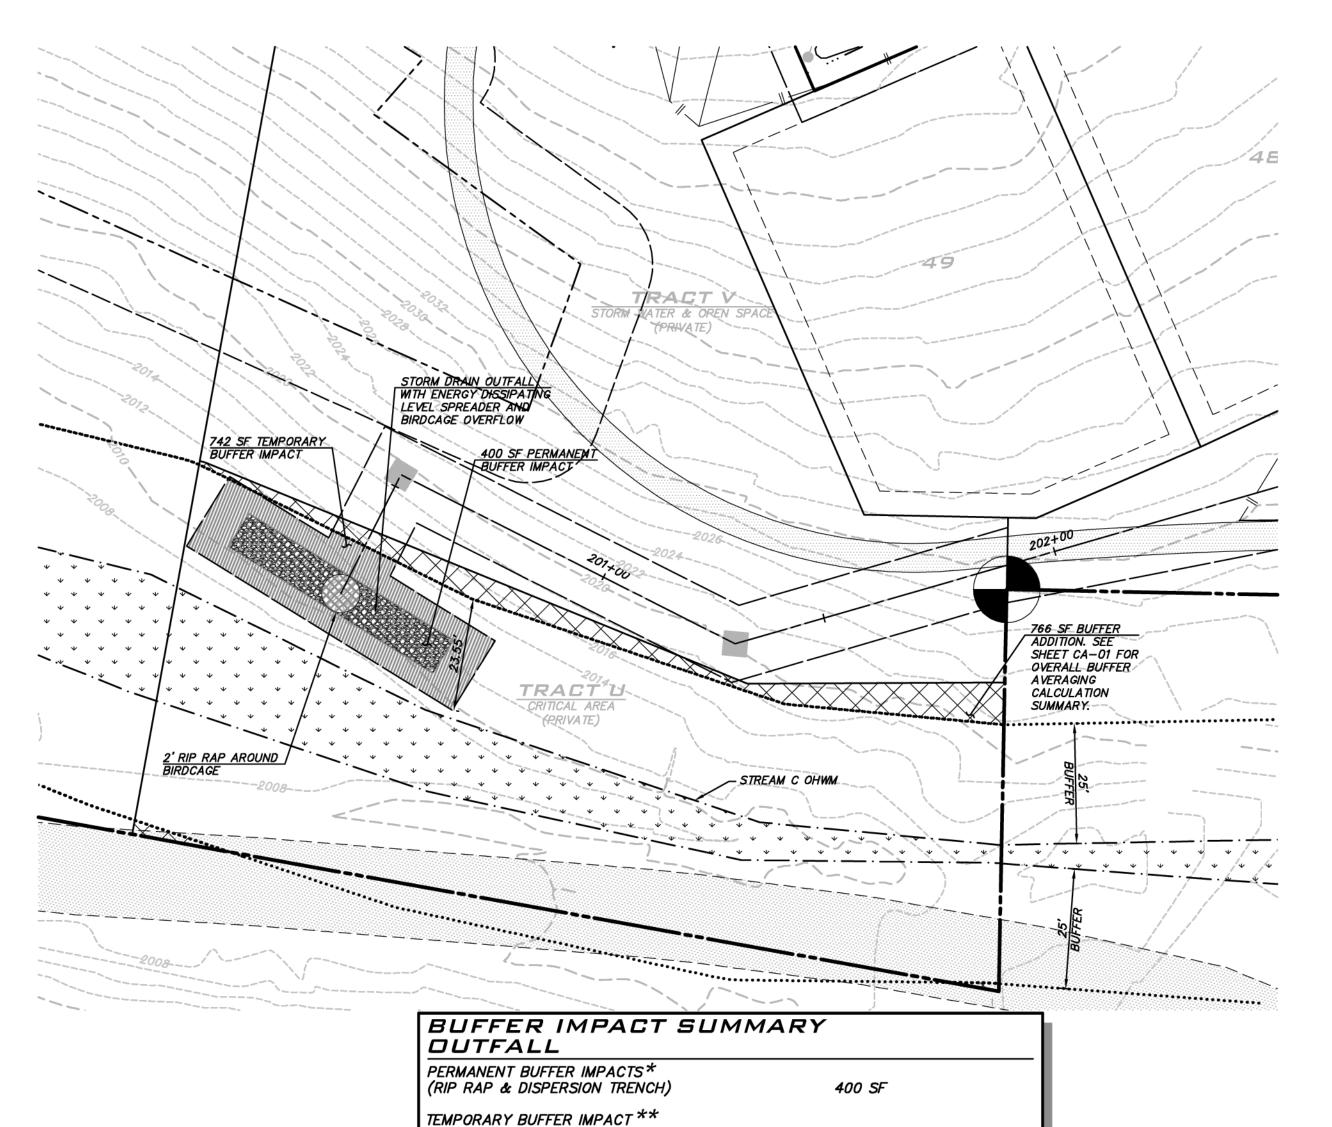** CONSULTANTS, INC.



BLUELINE

25 CENTRAL WAY, SUITE 400, KIRKLAND, WA 98033 P: 425.216.4051 F: 425.216.4052 WWW.THEBLUELINEGROUP.COM

AS NOTED PROJECT MANAGER.

BRETT K. PUDISTS, PE PROJECT ENGINEER.

LYNDSEY FEDAK, PE CHRIS WISCOMB

11/15/2021

11/15/21


19-349 SHEET NAME:

CA-03 <u>34</u> of <u>48</u>

BUFFER IMPACT SUMMARY PROPOSED STREAM CROSSING PERMANENT BUFFER IMPACTS * 6' TRAIL WEST OF STREAM) '6' TRAIL EAST OF STREAM) TEMPORARY BUFFER IMPACT *** (INSTALLATION OF BRIDGE, SEWER, & TRAIL NORTH OF STREAM) 185 SF 131 SF 316 SF (INSTALLATION OF BRIDGE, SEWER, & TRAIL SOUTH OF STREAM) BRIDGE ABOVE STREAM ** (NO IMPACT) 35 SF * BUFFER AVERAGING USED TO MITIGATE PERMANENT IMPACTS. REFER TO REPORT BY SEWALL CONSULTING, LLC FOR DETAILS. MITIGATION NOT NEEDED FOR IMPACTS ABOVE STREAM FOR A WDFW APPROVED CROSSING OR CULVERT PER SEWALL WETLAND CONSULTANTS, INC. ** RESTORATION OF TEMPORARY BUFFER IMPACTS REPORT BY SEWALL WETLAND CONSULTANTS, INC.



BRIDGE DESIGN PARAMETERS AND GRADING IN AREA OF BRIDGE ARE PROVIDED AS PART OF THE CLEARING, GRADING & INFRASTRUCTURE PLAN. SUBMITTAL PACKAGE FROM BRIDGE MANUFACTURER FOR STRUCTURAL ELEMENTS OF BRIDGE TO BE PROVIDED SEPARATELY TO THE CITY WHEN AVAILABLE.

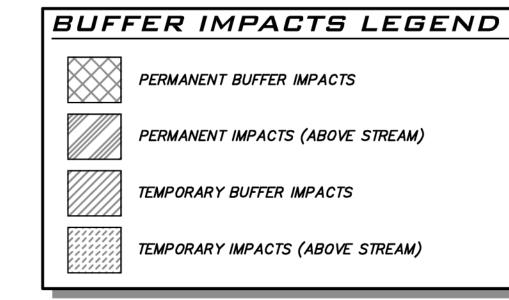


CRITICAL AREA NOTES

- CRITICAL AREAS AND BUFFERS SHOWN PER WETLANDS AND WILDLIFE HABITAT REPORT BY SEWALL WETLAND CONSULTING, INC..
- STANDARD BUFFER PRIOR TO AVERAGING SHOWN FOR REFERENCE. PROPOSED CRITICAL AREA TRACT BOUNDARY SETS THE NEW BUFFER AFTER AVERAGING.
- REFER TO CITY HEIGHTS PHASE 1 SUMMIT VIEW ROAD CRITICAL AREAS REPORT & IMPROVEMENT IMPACT ANALYSIS BY SEWALL CONSULTING, LLC FOR ADDITIONAL INFO.

EXISTING UTILITY NOTE

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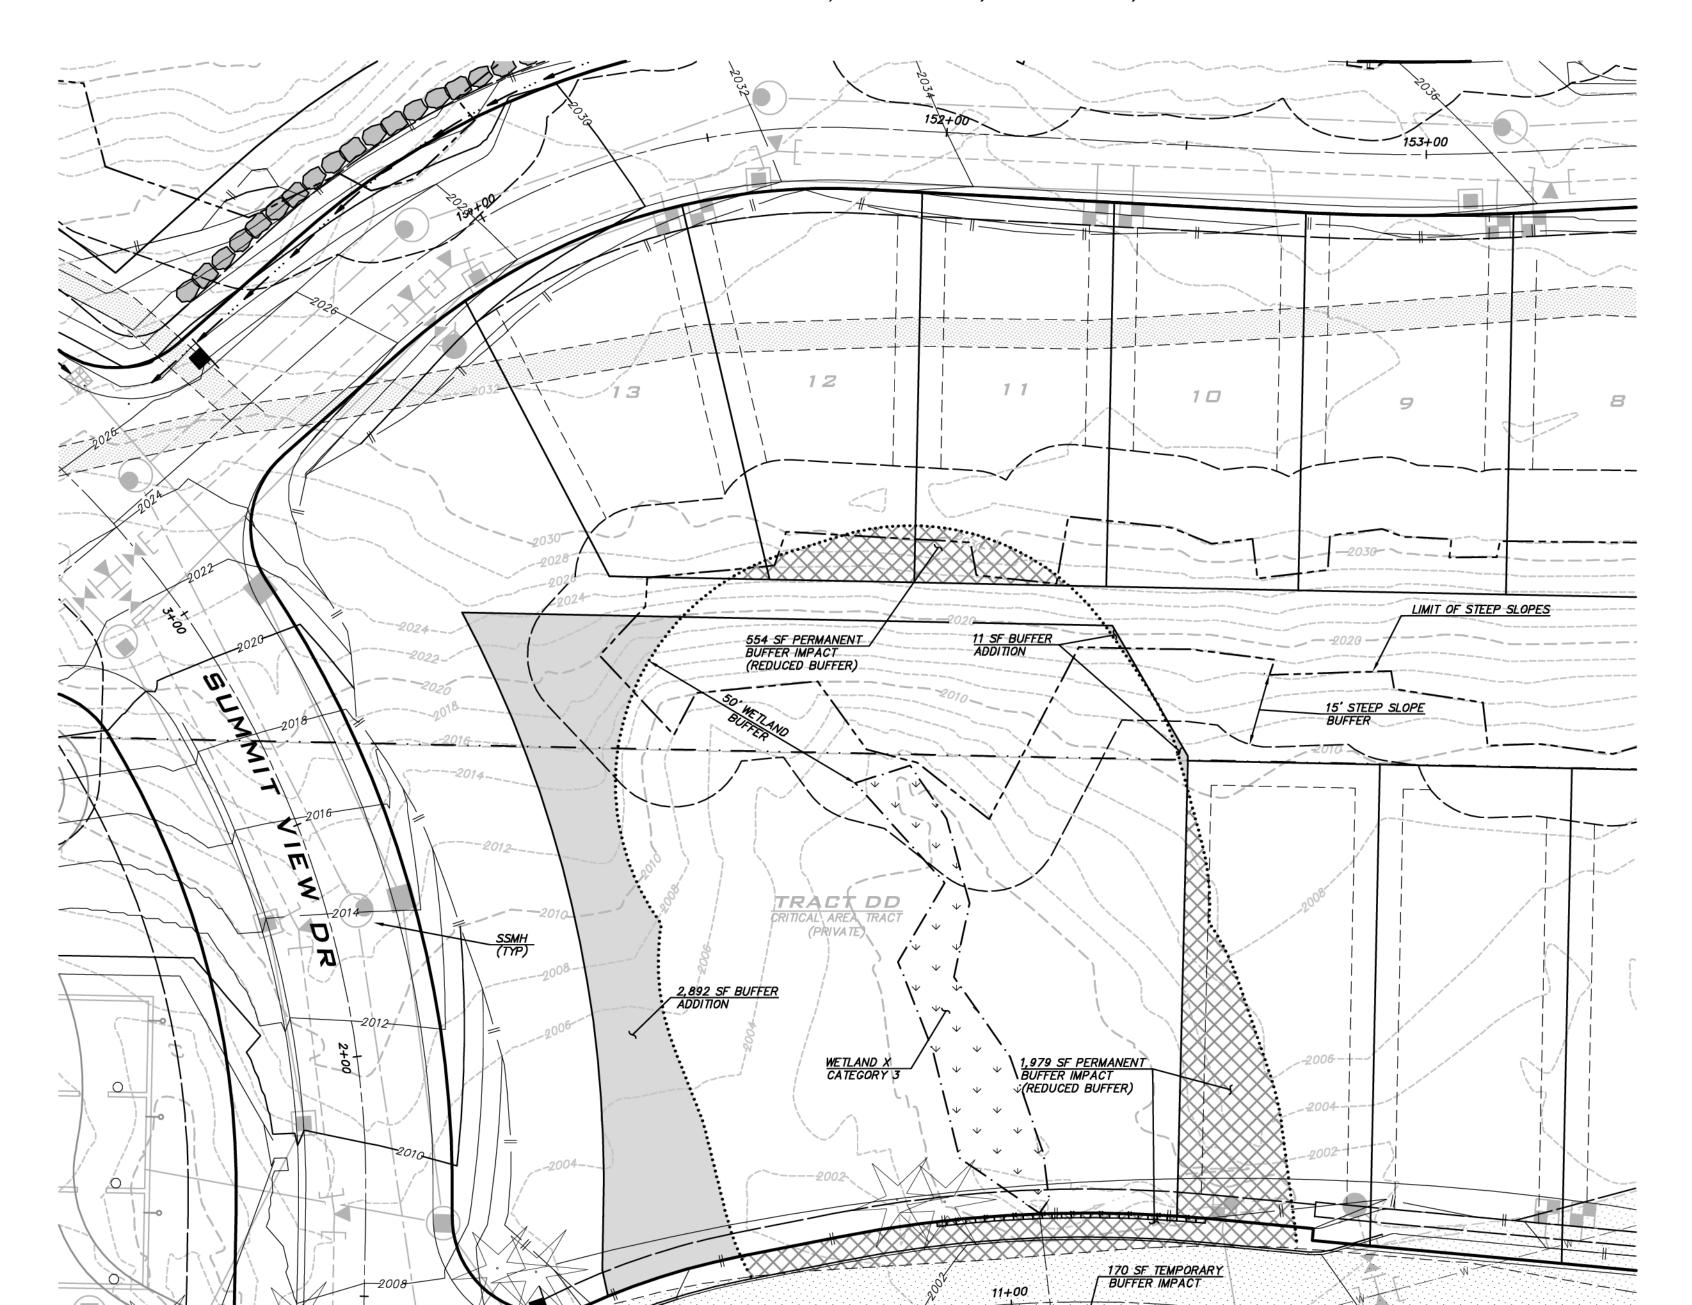


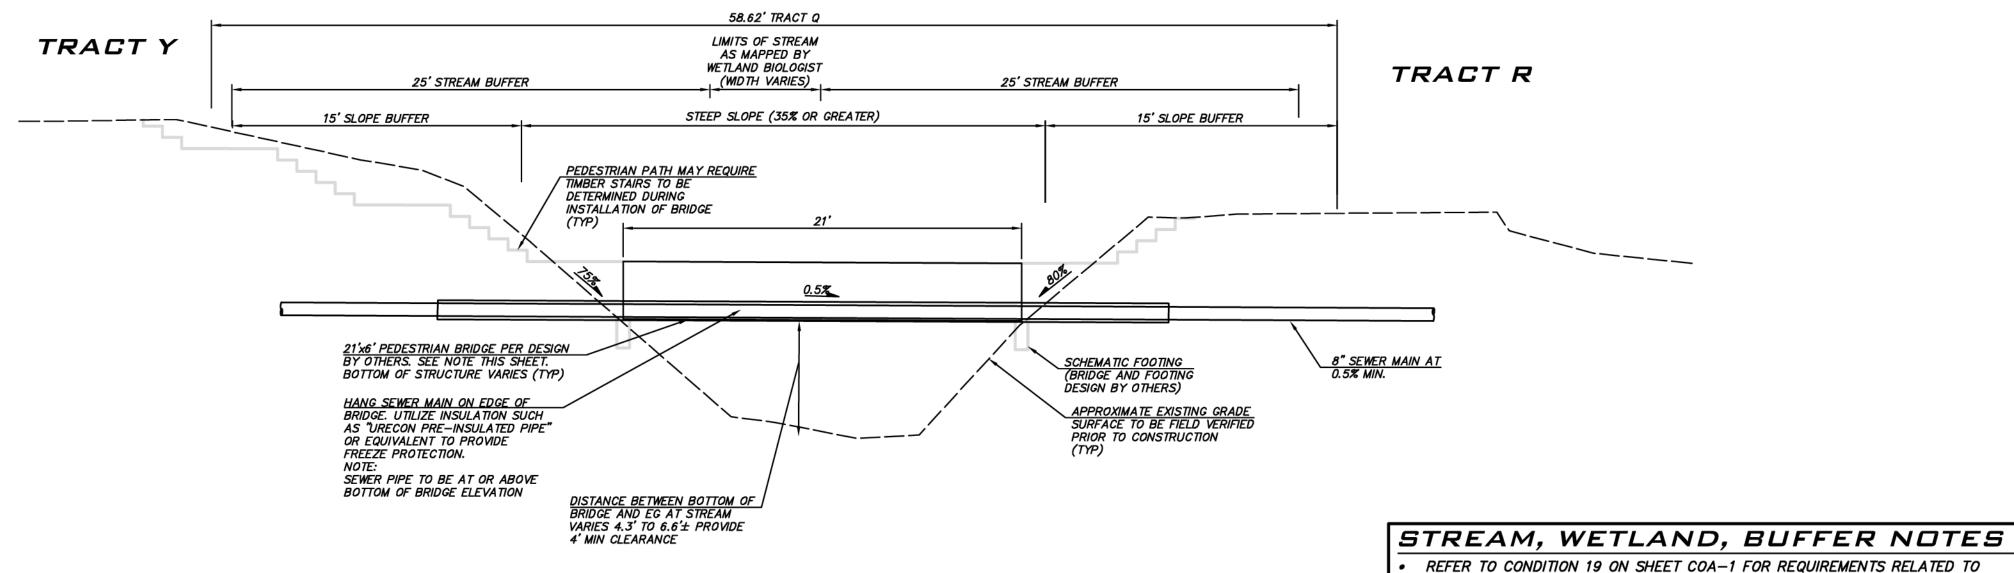
PEDESTRIAN BRIDGE WEST SCALE: 1"=5"


ACTIVITIES WITHIN STREAMS, WETLANDS AND THEIR BUFFERS. DO NOT DISTURB STREAMS, WETLAND OR BUFFERS UNTIL WRITTEN AUTHORIZATION FROM THE CITY IS PROVIDED.

SEE SHEET GN-01 FOR LIST OF RELEVANT REPORTS BY SEWALL CONSULTING, INC

^{*} ^{*} ^{*} ^{*} ^{*} ^{*} ^{*} **© 2021 BLUELINE**



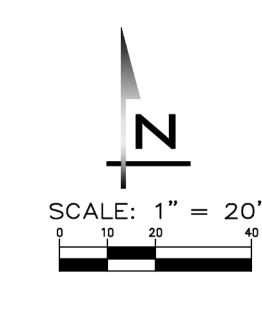

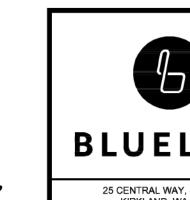



25 CENTRAL WAY, SUITE 400, KIRKLAND, WA 98033 P: 425.216.4051 F: 425.216.4052 WWW.THEBLUELINEGROUP.COM

AS NOTED PROJECT MANAGER:

BRETT K. PUDISTS, PE PROJECT ENGINEER: LYNDSEY FEDAK, PE

CHRIS WISCOMB

11/15/2021

BUFFER IMPACTS LEGEND

PERMANENT BUFFER IMPACTS

BUFFER ADDITION (AREA WITHIN CRITICAL AREA TRACT, OUTSIDE OF EXISTING BUFFER)

TEMPORARY BUFFER IMPACTS

CRITICAL AREA NOTES

- CRITICAL AREAS AND BUFFERS SHOWN PER WETLANDS AND WILDLIFE HABITAT REPORT BY SEWALL WETLAND CONSULTING, INC..
- STANDARD BUFFER PRIOR TO AVERAGING SHOWN FOR REFERENCE. PROPOSED CRITICAL AREA TRACT BOUNDARY SETS THE NEW BUFFER AFTER AVERAGING. REFER TO CITY HEIGHTS PHASE 1 - SUMMIT VIEW ROAD - CRITICAL AREAS REPORT & IMPROVEMENT IMPACT ANALYSIS BY SEWALL CONSULTING, LLC FOR

ADDITIONAL INFO.

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BUFFER IMPACT SUMMARY & BUFFERING AVERAGING AREAS PROPOSED ROAD WIDENING & DEVELOPMENT

SIXTH STREET

NORTH OF WETLAND 1,979 SF 2,533 SF SOUTH & EAST OF WETLAND BUFFER ADDITION (AREA WITHIN CRITICAL AREA TRACT, OUTSIDE OF EXISTING BUFFER)* WEST OF WETLAND 2,892 SF 11 SF 2,903 SF NORTH OF WETLAND

TEMPORARY BUFFER IMPACT ** NORTH OF STREAM

PERMANENT BUFFER IMPACTS *

* BUFFER AVERAGING USED TO MITIGATE PERMANENT IMPACTS. REFER TO REPORT BY SEWALL CONSULTING, LLC FOR DETAILS.

** RESTORATION OF TEMPORARY BUFFER IMPACTS PER SEWALL WETLAND CONSULTANTS, INC.

REFER TO CONDITION 19 ON SHEET COA-1 FOR REQUIREMENTS RELATED TO ACTIVITIES WITHIN STREAMS, WETLANDS AND THEIR BUFFERS.

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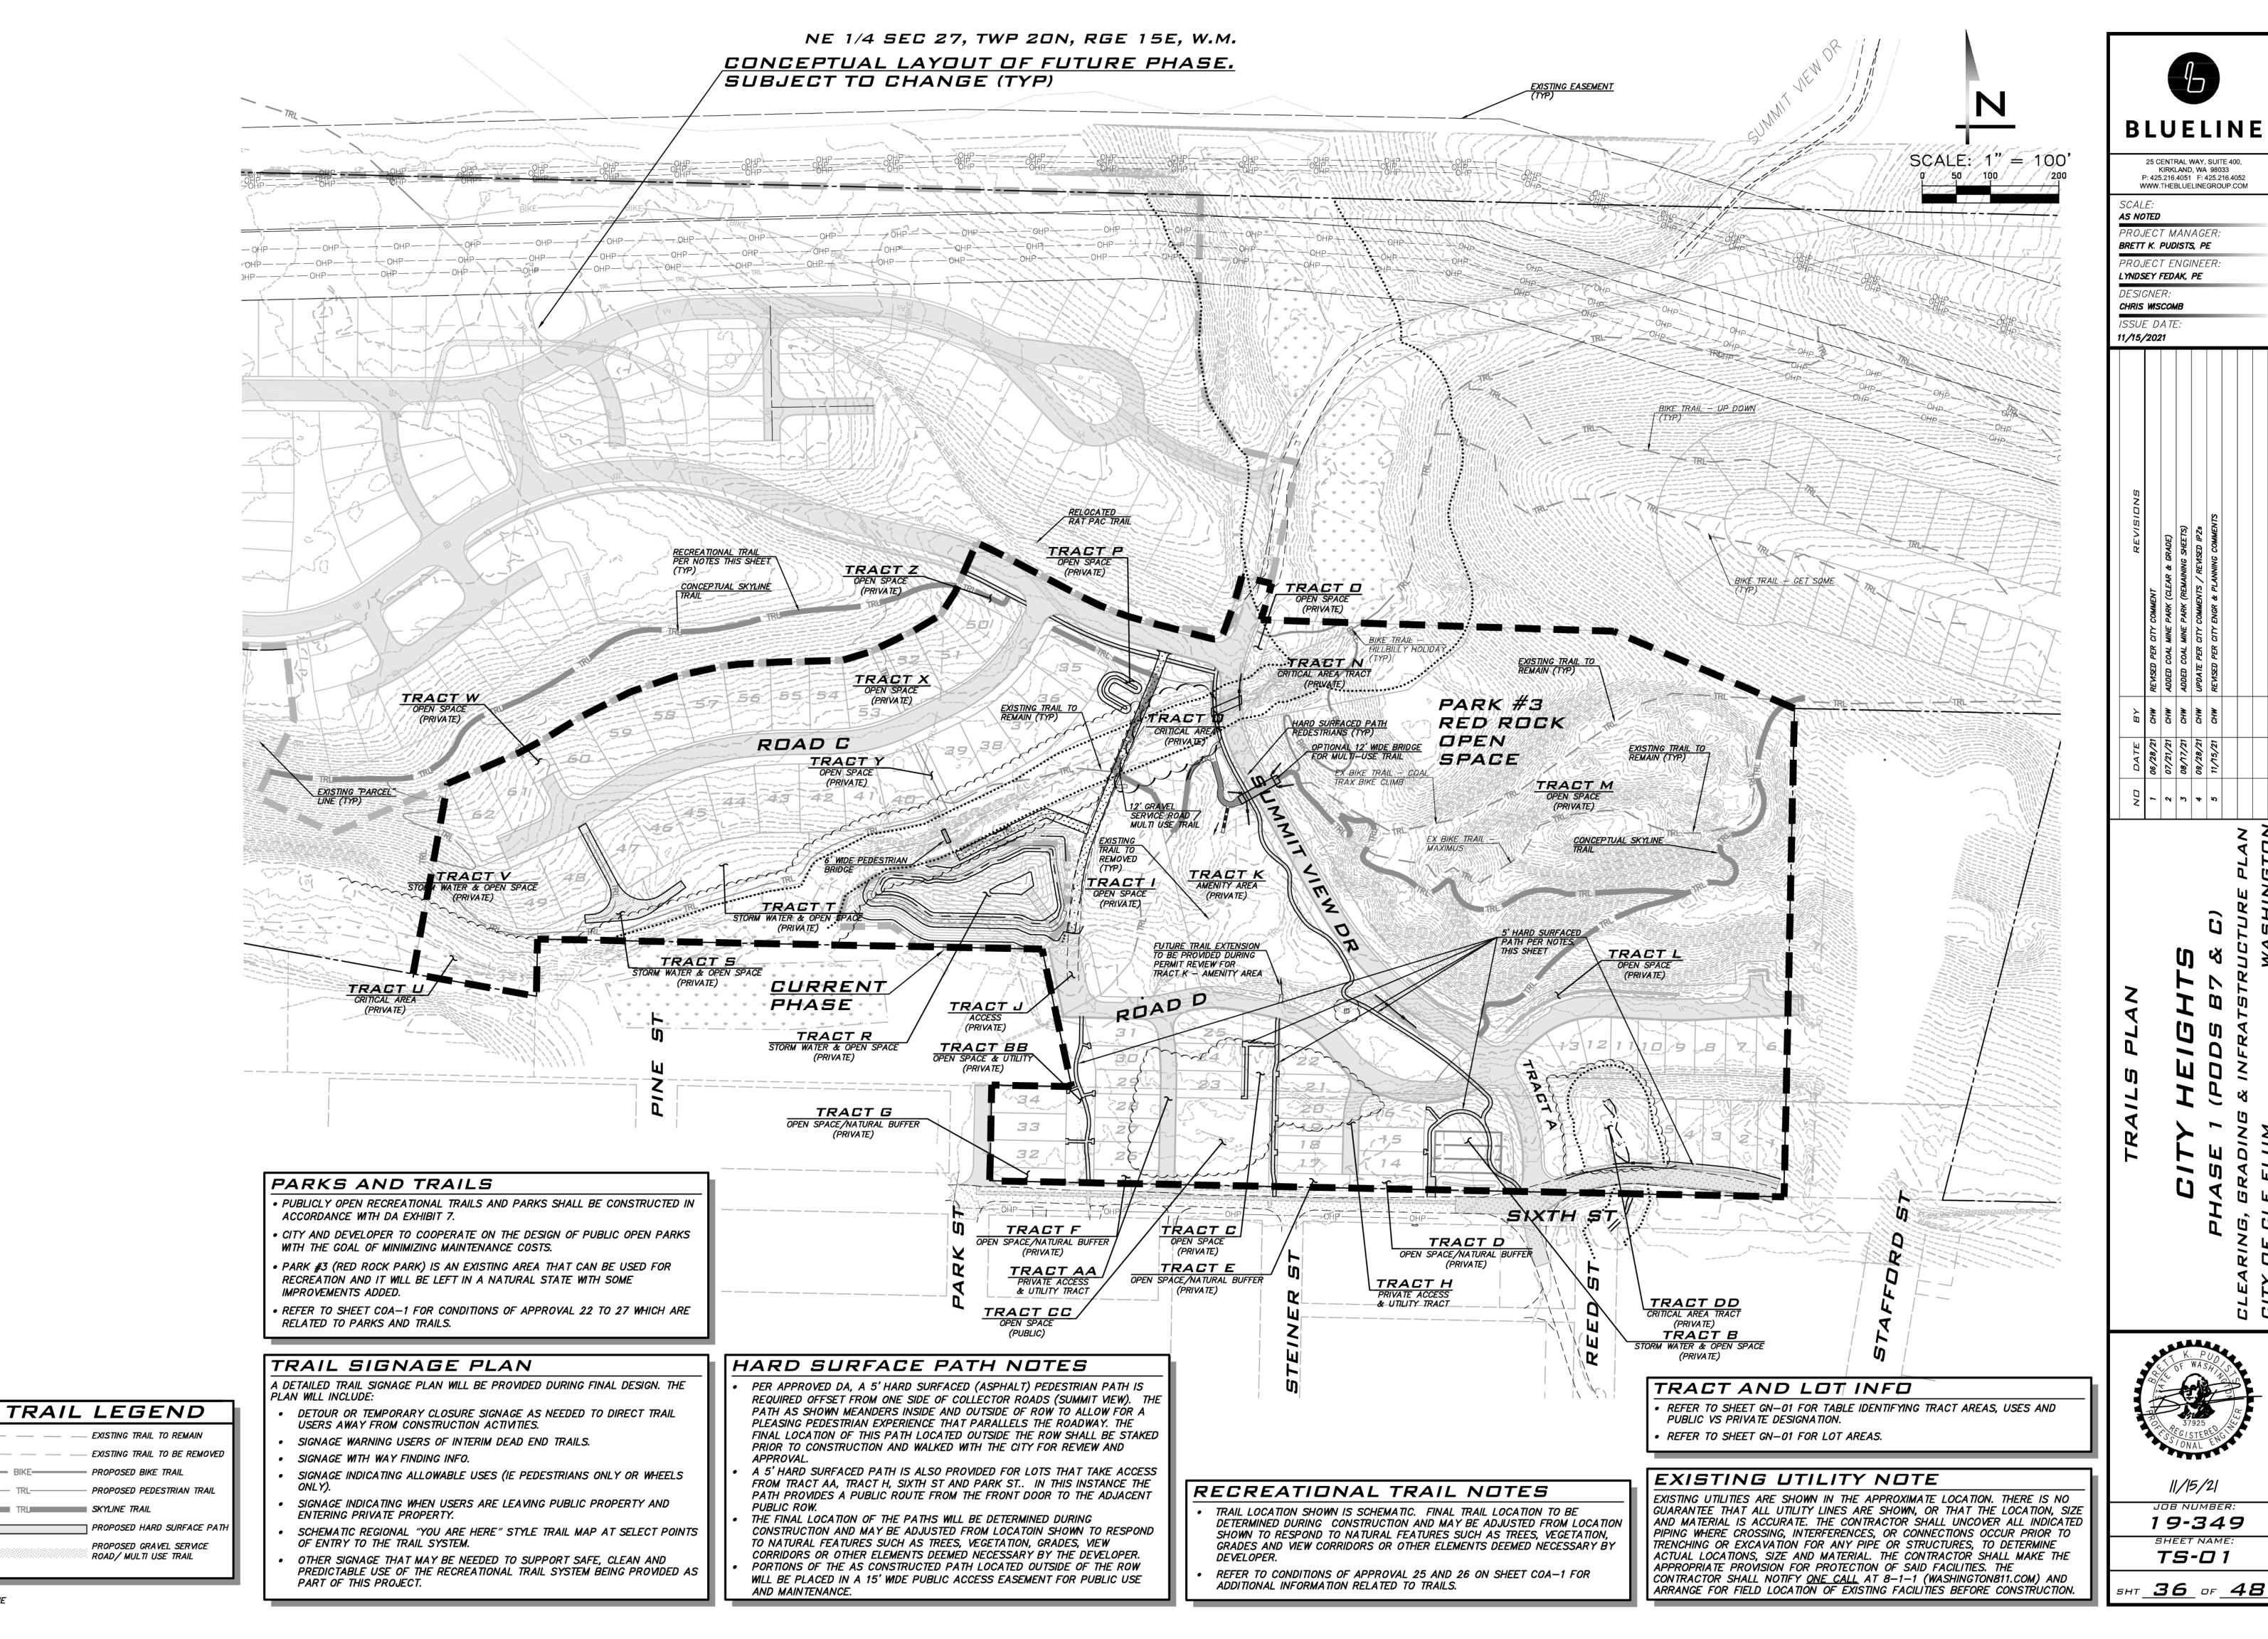
STREAM, WETLAND, BUFFER NOTES

11/15/21

19-349


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BLUELINE

25 CENTRAL WAY, SUITE 400, KIRKLAND, WA 98033 P: 425.216.4051 F: 425.216.4052 WWW.THEBLUELINEGROUP.COM

PROJECT MANAGER. BRETT K. PUDISTS, PE


PROJECT ENGINEER: LYNDSEY FEDAK, PE

CHRIS WISCOMB

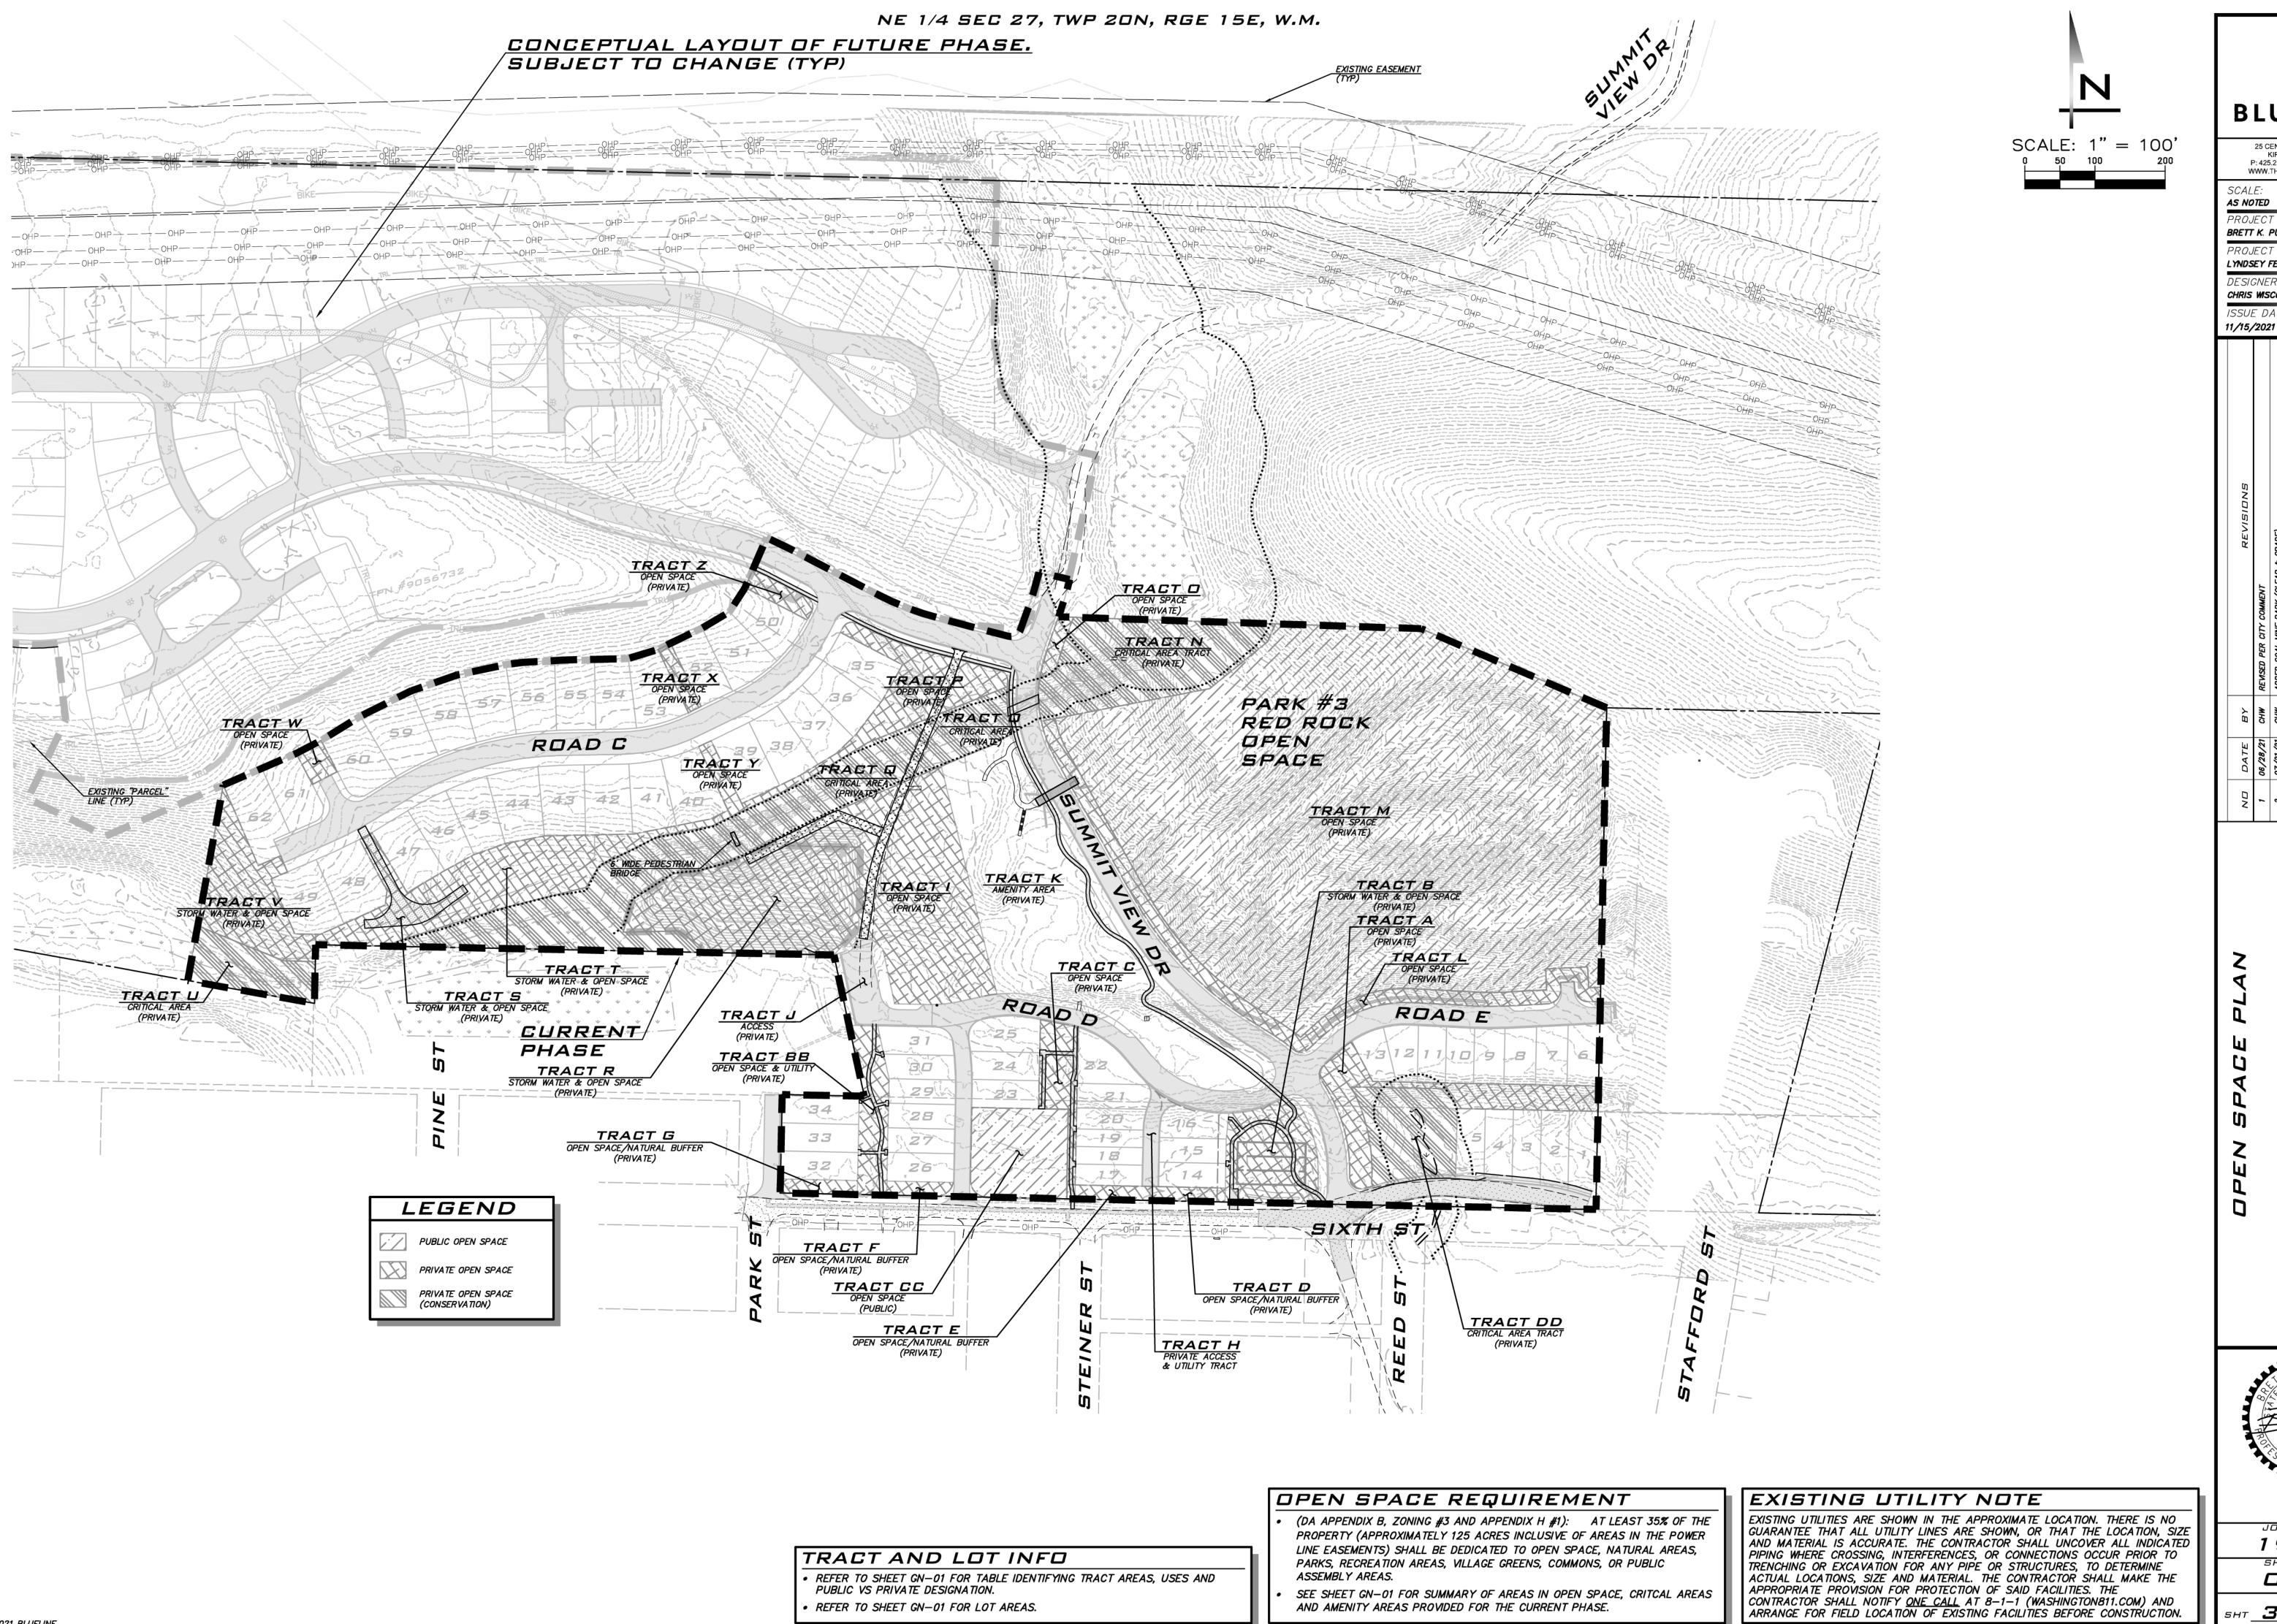11/15/21

19-349 SHEET NAME: 05-01

sнт <u>37</u> оғ <u>48</u>

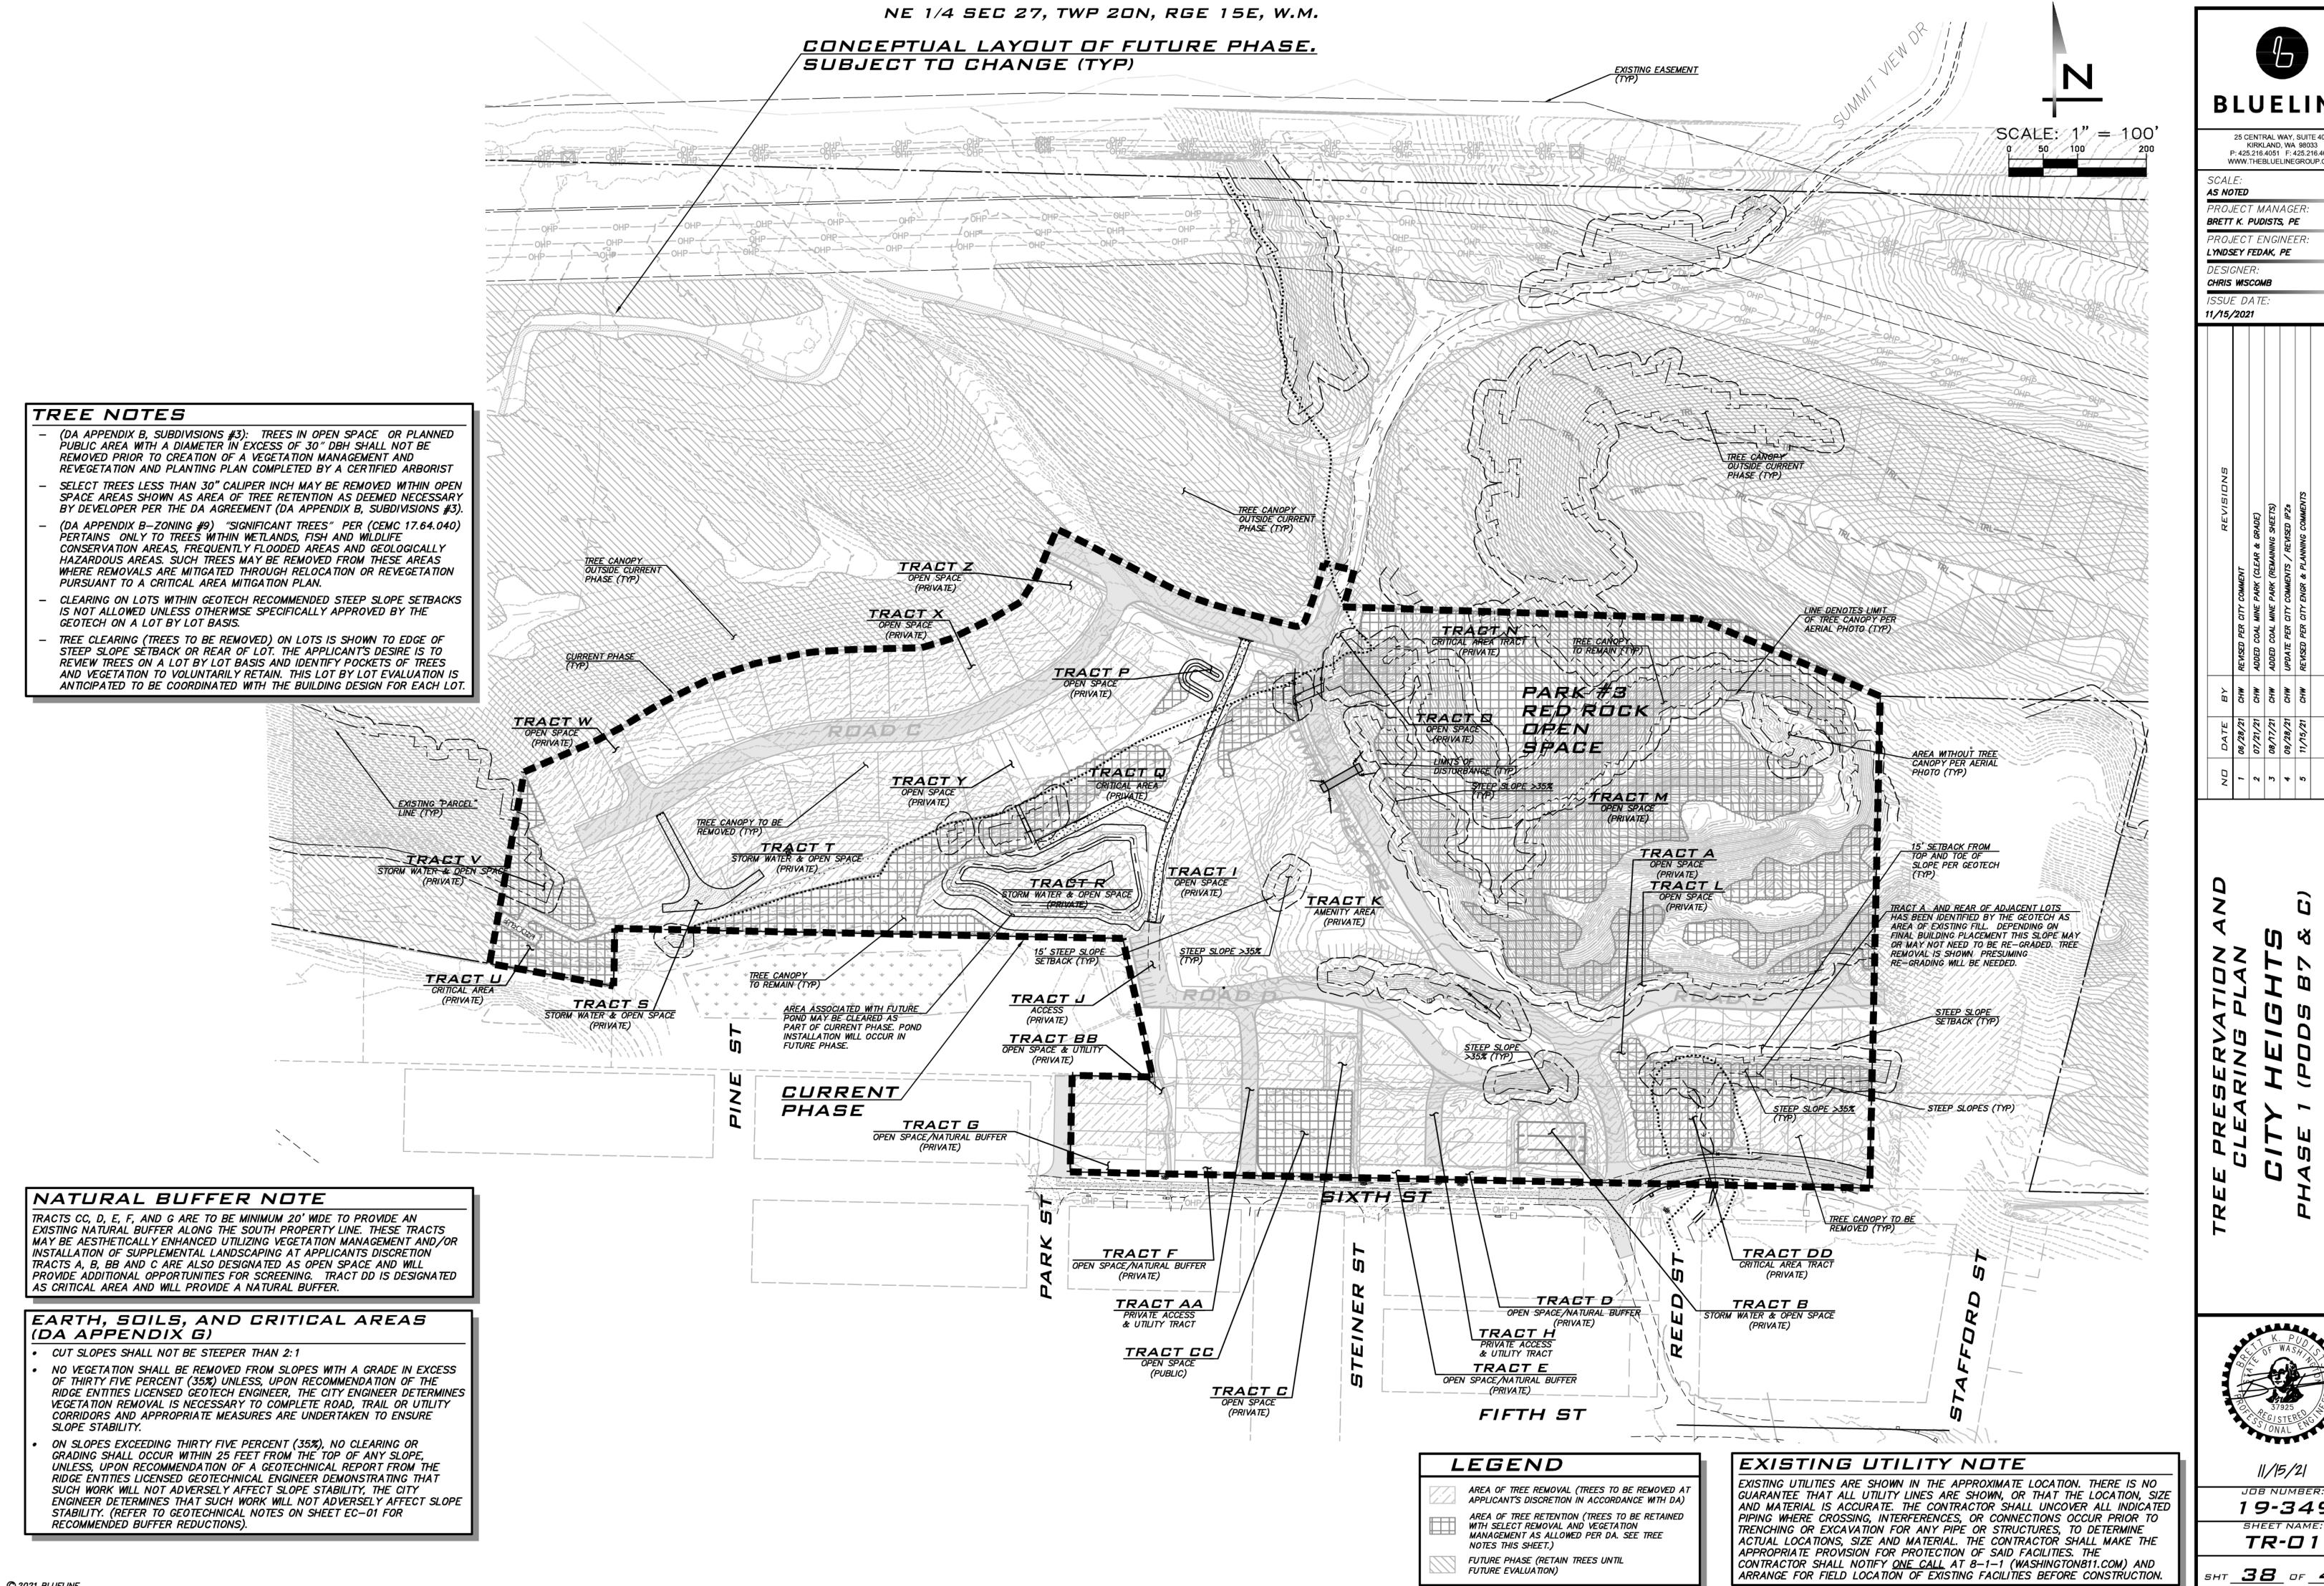

BLUELINE

25 CENTRAL WAY, SUITE 400, KIRKLAND, WA 98033 P: 425.216.4051 F: 425.216.4052 WWW.THEBLUELINEGROUP.COM

AS NOTED

PROJECT MANAGER: BRETT K. PUDISTS, PE

PROJECT ENGINEER: LYNDSEY FEDAK, PE DESIGNER:

CHRIS WISCOMB ISSUE DATE:


11/15/2021



11/15/21

19-349 SHEET NAME:

<u>38</u> of <u>48</u>

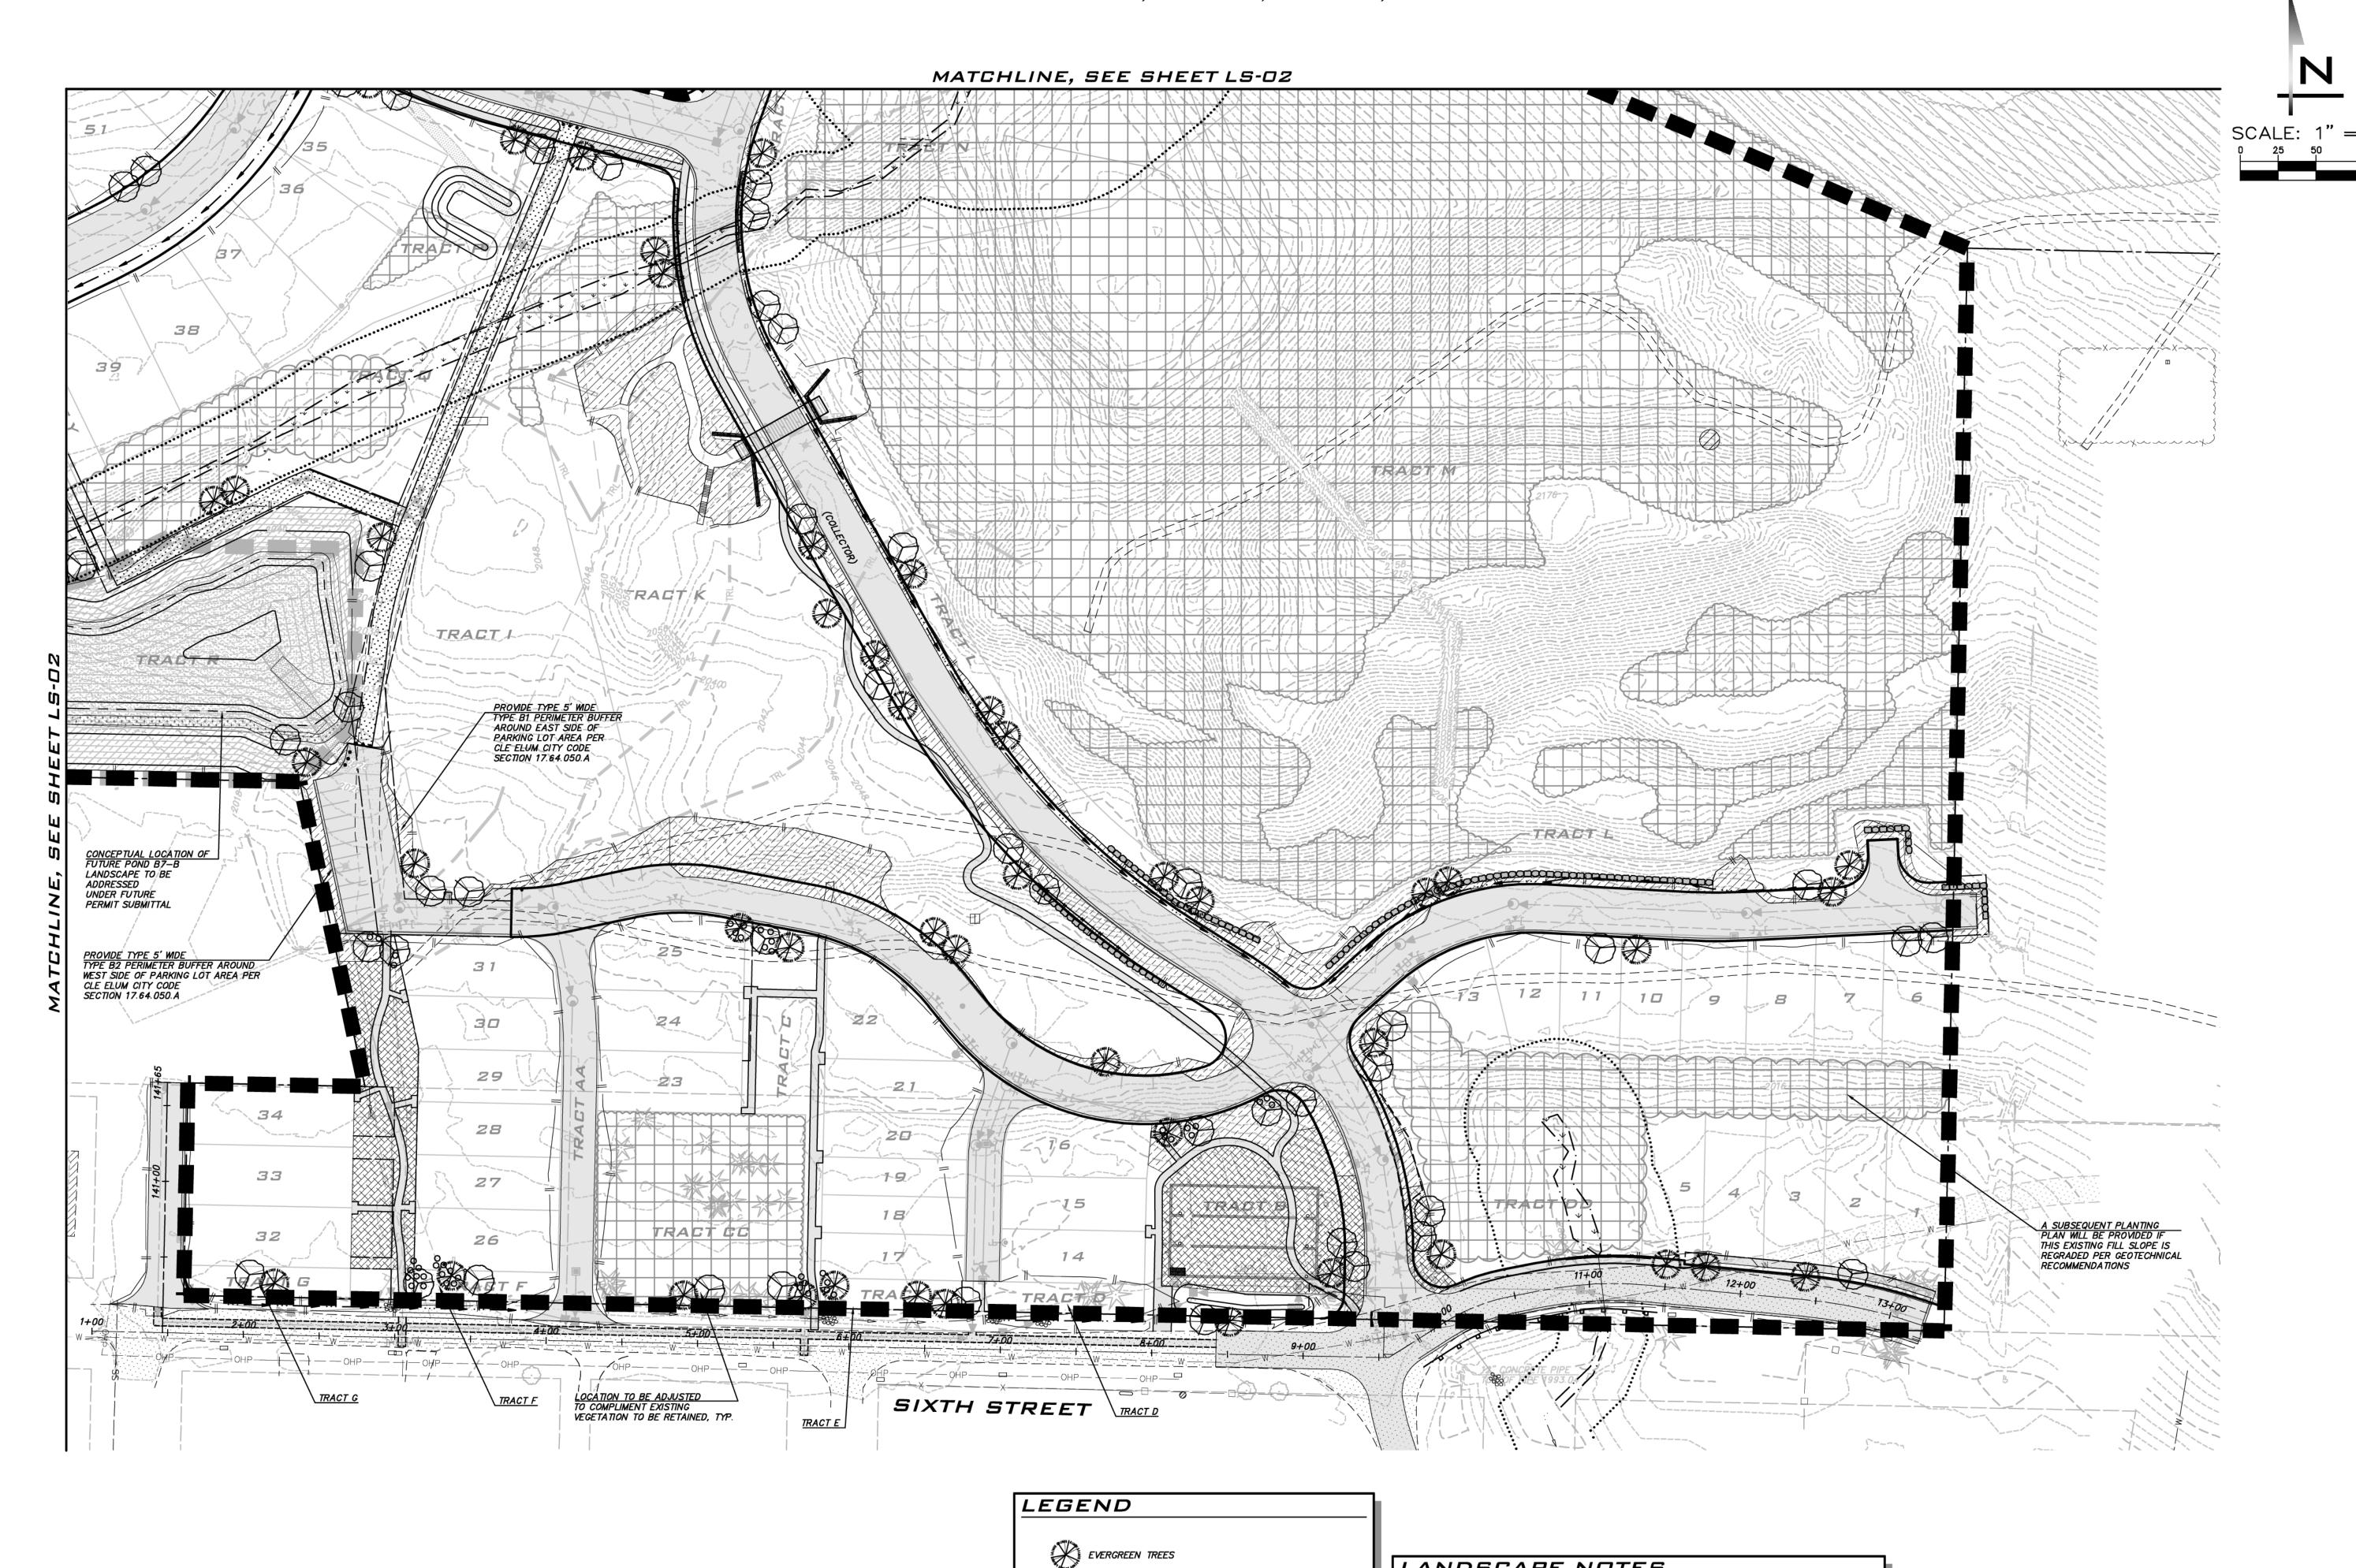

NATURAL BUFFER NOTE

TRACTS CC, D, E, F, AND G ARE TO BE MINIMUM 20' WIDE TO PROVIDE AN EXISTING NATURAL BUFFER ALONG THE SOUTH PROPERTY LINE. THESE TRACTS MAY BE AESTHETICALLY ENHANCED UTILIZING VEGETATION MANAGEMENT AND/OR INSTALLATION OF SUPPLEMENTAL LANDSCAPING AT APPLICANTS DISCRETION TRACTS A, B, BB, AND C ARE ALSO DESIGNATED AS OPEN SPACE AND WILL PROVIDE ADDITIONAL OPPORTUNITIES FOR SCREENING. TRACT DD IS DESIGNATED AS CRITICAL AREA AND WILL PROVIDE A NATURAL BUFFER.

EXISTING VEGETATION

AREA OF TREE RETENTION (TREES TO BE RETAINED WITH SELECT REMOVAL AND VEGETATION MANAGEMENT AS ALLOWED PER DA. SEE TREE NOTES ON SHEET TR-01.)

FUTURE PHASE (RETAIN TREES UNTIL FUTURE EVALUATION)

ENHANCED NATIVE GROUNDCOVER TO BE DESIGNED AS PART OF FUTURE PHASE * SEE LS-03 FOR CONCEPTUAL PLANT SCHEDULE*

DECIDUOUS TREES

ACCENT PLANTING

STABILIZATION

GRASS SEED MIX

LANDSCAPE NOTES

UTILITIES AND/OR ACCESS.

- REFER TO DA APPENDIX B SECTION 9 FOR LANDSCAPING REQUIREMENTS. CCR'S SHALL BE ESTABLISHED THAT PROVIDE FOR REVEGETATION OF
- DISTURBED AREAS, PREVENTION OF NOXIOUS WEEDS, PROHIBIT HUNTING AND DISCHARGE OF FIREARMS AND REQUIRE WILDLIFE PROOF GARBAGE CANS. REFER TO DA APPENDIX H #3 FOR REQUIREMENTS.
- SEE SHEETS TS-01 AND OS-01 FOR ADDITIONAL TRAILS AND OPEN SPACE

STREET TREE LOCATIONS ARE CONCEPTUAL AND MAY BE IMPACTED BY

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AS NOTED PROJECT MANAGER:

BRETT K. PUDISTS, PE LANDSCAPE ARCHITECT:

ALAN MCWAIN RAYLEE MCKINLEY

ISSUE DATE:


04/30/2021

19-349

SHEET NAME: LS-01

11/15/21

sнт <u>39</u> ог <u>48</u>

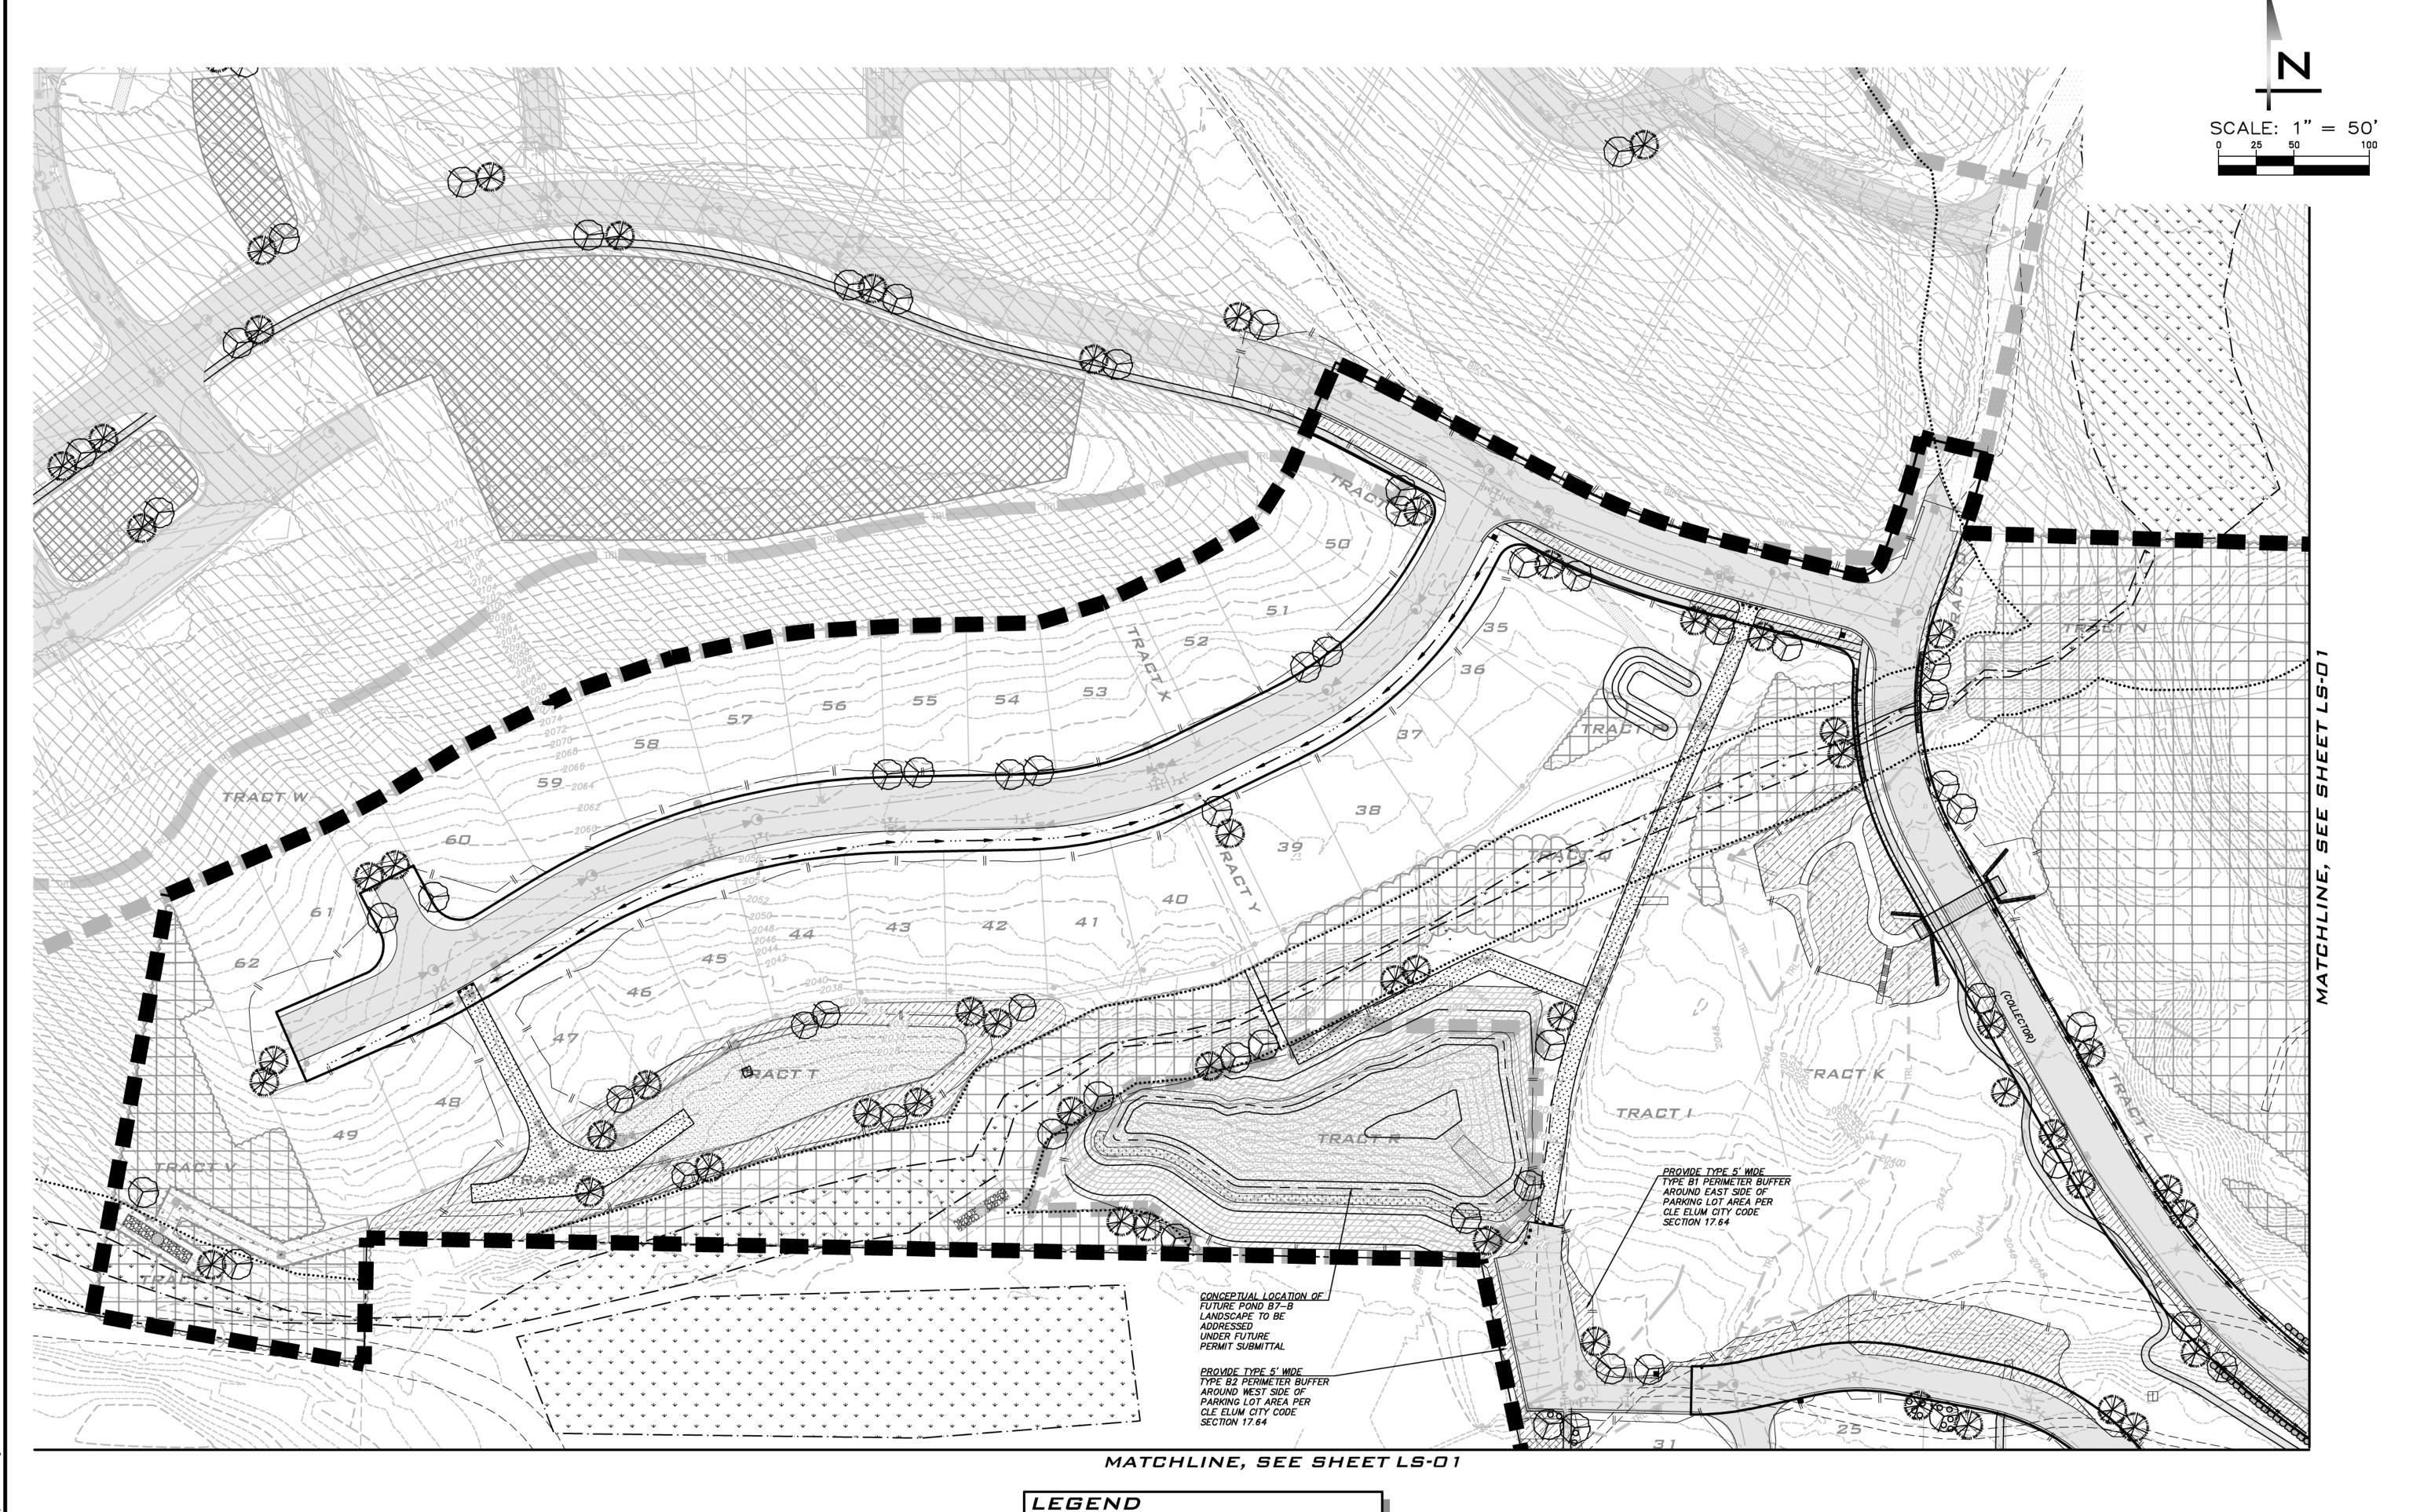

NATURAL BUFFER NOTE

TRACTS CC, D, E, F, AND G ARE TO BE MINIMUM 20' WIDE TO PROVIDE AN EXISTING NATURAL BUFFER ALONG THE SOUTH PROPERTY LINE. THESE TRACTS MAY BE AESTHETICALLY ENHANCED UTILIZING VEGETATION MANAGEMENT AND/OR INSTALLATION OF SUPPLEMENTAL LANDSCAPING AT APPLICANTS DISCRETION TRACTS A, B, BB, AND C ARE ALSO DESIGNATED AS OPEN SPACE AND WILL PROVIDE ADDITIONAL OPPORTUNITIES FOR SCREENING. TRACT DD IS DESIGNATED AS CRITICAL AREA AND WILL PROVIDE A NATURAL BUFFER.

EXISTING VEGETATION

AREA OF TREE RETENTION (TREES TO BE RETAINED WITH SELECT REMOVAL AND VEGETATION MANAGEMENT AS ALLOWED PER DA. SEE TREE NOTES ON SHEET TR-01.)

FUTURE PHASE (RETAIN TREES UNTIL FUTURE EVALUATION)

ENHANCED NATIVE GRASS SEED MIX ACCENT PLANTING ENHANCED NATIVE GROUNDCOVER X TO BE DESIGNED AS PART OF FUTURE PHASE

STABILIZATION

* SEE LS-03 FOR CONCEPTUAL PLANT SCHEDULE*

LANDSCAPE NOTES

- REFER TO DA APPENDIX B SECTION 9 FOR LANDSCAPING REQUIREMENTS. • CCR'S SHALL BE ESTABLISHED THAT PROVIDE FOR REVEGETATION OF
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- UTILITIES AND/OR ACCESS. SEE SHEETS TS-01 AND OS-01 FOR ADDITIONAL TRAILS AND OPEN SPACE INFORMATION.

• STREET TREE LOCATIONS ARE CONCEPTUAL AND MAY BE IMPACTED BY

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AS NOTED

PROJECT MANAGER: BRETT K. PUDISTS, PE

LANDSCAPE ARCHITECT: ALAN MCWAIN

RAYLEE MCKINLEY ISSUE DATE:

04/30/2021

11/15/21

19-349

LS-02

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CONCEPT PLANT SCHEDULE PHASE ONE

EVERGREEN TREES ABIES LASIOCARPA / SUBALPINE FIR LARIX OCCIDENTALIS / WESTERN LARCH PICEA ABIES / NORWAY SPRUCE PINUS CONTORTA VAR. LATIFOLIA / LODGEPOLE PINE PINUS PONDEROSA / PONDEROSA PINE



DECIDUOUS TREES
ACER CIRCINATUM / VINE MAPLE ACER GLABRUM / ROCKY MOUNTAIN MAPLE AMELANCHIER ALNIFOLIA / SERVICEBERRY CORNUS NUTTALLII / WESTERN FLOWERING DOGWOOD POPULUS TREMULOIDES / QUAKING ASPEN SORBUS AUCUPARIA / EUROPEAN MOUNTAIN ASH



SLOPE STABILIZATION PLANTING ARCTOSTAPHYLOS UVA—URSI / KINNIKINNICK CAREX GEYERI / ELK SEDGE CORNUS SERICEA / RED TWIG DOGWOOD CORYLUS CORNUTA / WESTERN HAZELNUT FESTUCA IDAHOENSIS / IDAHO FESCUE FESTUCA RUBRA / RED FESCUE HOLODISCUS DISCOLOR / OCEAN-SPRAY MAHONIA AQUIFOLIUM / OREGON GRAPE MAHONIA REPENS / CREEPING MAHONIA PENSTEMON FRUTICOSUS / SHRUBBY PENSTEMON PHILADELPHUS LEWISII / WILD MOCKORANGE PHYSOCARPUS CAPITATUS / PACIFIC NINEBARK RIBES SANGUINEUM / RED FLOWERING CURRANT ROSA NUTKANA / NOOTKA ROSE SYMPHORICARPOS ALBUS / COMMON WHITE SNOWBERRY



GRASS SEED MIX FESTUCA IDAHOENSIS / IDAHO FESCUE FESTUCA LONGIFOLIA / HARD FESCUE FESTUCA OVINA / SHEEP FESCUE FESTUCA RUBRA / RED FESCUE POA SECUNDA / CANBY BLUEGRASS



ENHANCED LANDSCAPE ACCENT PLANTING ARMERIA MARITIMA / SEA THRIFT CARYOPTERIS X CLANDONENSIS / BLUEBEARD CORNUS STOLONIFERA 'KELSEYI' / KELSEY'S DWARF RED TWIG DOGWOOD LUPINUS X 'BLACKSMITH' TM / WESTCOUNTRY BLACKSMITH LUPINE MAHONIA REPENS / CREEPING MAHONIA PHYSOCARPUS CAPITATUS 'SISKIYOU BEAUTY' / SISKIYOU BEAUTY PACIFIC POTENTILLA FRUTICOSA / BUSH CINQUEFOIL ROSA NUTKANA / NOOTKA ROSE



ENHANCED NATIVE GROUNDCOVER ARCTOSTAPHYLOS UVA—URSI / KINNIKINNICK ARMERIA MARITIMA / SEA THRIFT ASARUM CANADENSE / CANADIAN WILD GINGER CERASTIUM TOMENTOSUM / SNOW IN SUMMER CORNUS CANADENSIS / BUNCHBERRY DOGWOOD LUPINUS LATIFOLIUS / BROADLEAF LUPINE LUPINUS LAXIFLORUS / SILVERY LUPINE MAHONIA REPENS / CREEPING MAHONIA TRILLIUM OVATUM / COAST TRILLIUM

25 CENTRAL WAY, SUITE 400, KIRKLAND, WA 98033 P: 425.216.4051 F: 425.216.4052 WWW.THEBLUELINEGROUP.COM

SCALE: AS NOTED

PROJECT MANAGER: BRETT K. PUDISTS, PE

LANDSCAPE ARCHITECT: ALAN MCWAIN DESIGNER:

RAYLEE MCKINLEY

ISSUE DATE: 04/30/2021


REVISIONS	REVISED PER CITY COMMENT	ADDED COAL MINE PARK (CLEAR & GRADE)	ADDED COAL MINE PARK (REMAINING SHEETS)	REVISED PER CITY COMMENT / REVISED IPZS	REVISED PER CITY ENGR & PLANNING COMMENTS		
ВУ	CHW	CHW	CHW	CHW	CHW		
DATE	06/28/21	07/21/21	08/17/21	09/28/21	11/15/21		
ON	1	2	3	4	5		

EXISTING UTILITIES ARE SHOWN IN THE APPROXIMATE LOCATION. THERE IS NO GUARANTEE THAT ALL UTILITY LINES ARE SHOWN, OR THAT THE LOCATION, SIZE AND MATERIAL IS ACCURATE. THE CONTRACTOR SHALL UNCOVER ALL INDICATED PIPING WHERE CROSSING, INTERFERENCES, OR CONNECTIONS OCCUR PRIOR TO TRENCHING OR EXCAVATION FOR ANY PIPE OR STRUCTURES, TO DETERMINE ACTUAL LOCATIONS, SIZE AND MATERIAL. THE CONTRACTOR SHALL MAKE THE APPROPRIATE PROVISION FOR PROTECTION OF SAID FACILITIES. THE CONTRACTOR SHALL NOTIFY ONE CALL AT 8-1-1 (WASHINGTON811.COM) AND ARRANGE FOR FIELD LOCATION OF EXISTING FACILITIES BEFORE CONSTRUCTION.

LANDSCAPE PLANTING NOTE


- ALTERNATE SPECIES APPROPRIATE TO THE REGION MAY BE SUBSTITUTED PER THE APPLICANT'S DISCRETION. PLANT SELECTION SHALL CONSIDER ADAPTABILITY TO CLIMATE, GEOLOGIC AND TOPOGRAPHICAL CHARACTERISTICS OF THE SITE.
- ALTERNATE SPECIES TO BE LOCATED IN PUBLIC TRACTS OR ROW TO BE PROVIDED TO THE CITY FOR APPROVAL PRIOR TO INSTALLATION. APPROVAL OF SPECIES SHALL BE LIMITED TO SUITABILITY OF SPECIES FOR USE IN PUBLIC AREAS AND NOT AN ATTEMPT TO GOVERN AESTHETICS.


EXISTING UTILITY NOTE

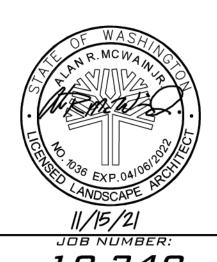



19-349 SHEET NAME: LS-03


sнт <u>41</u> ог <u>48</u>

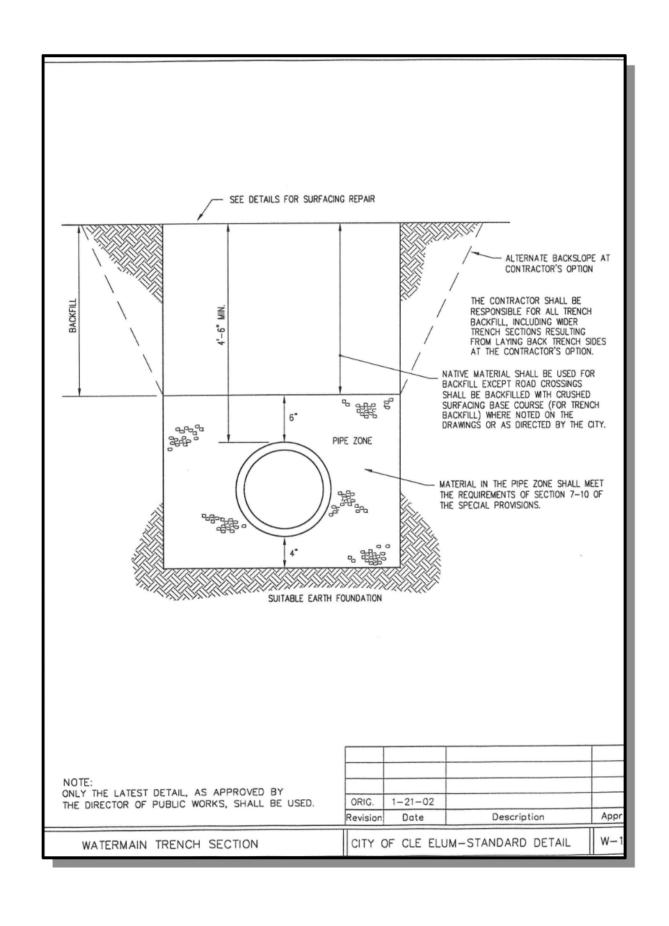


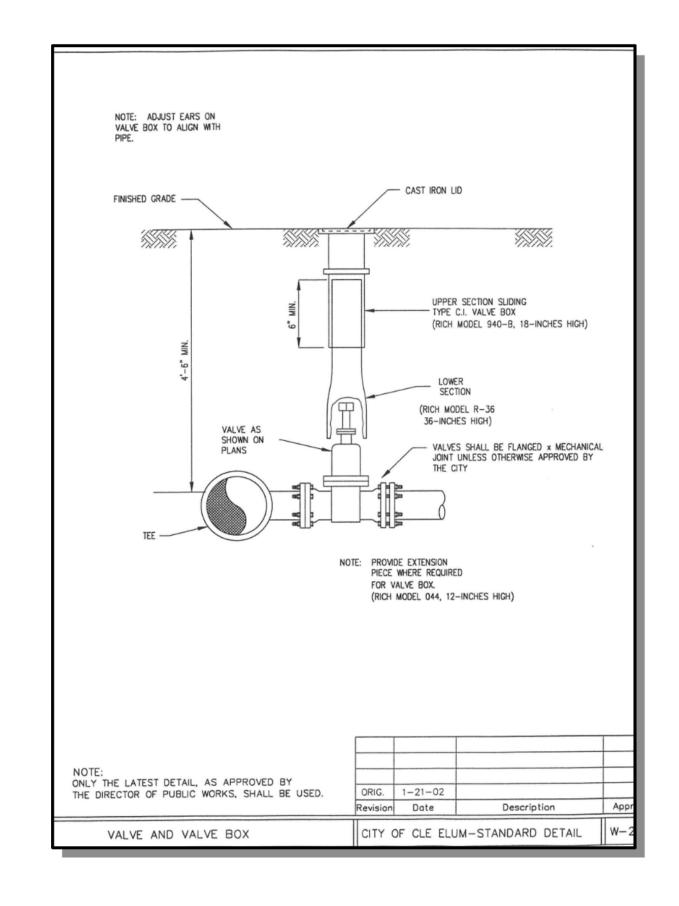


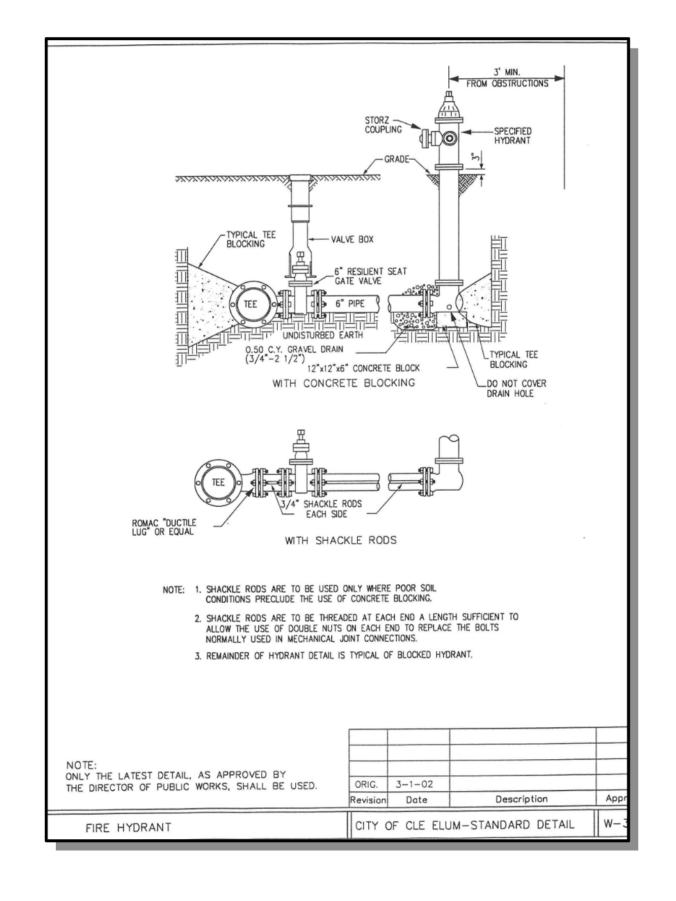


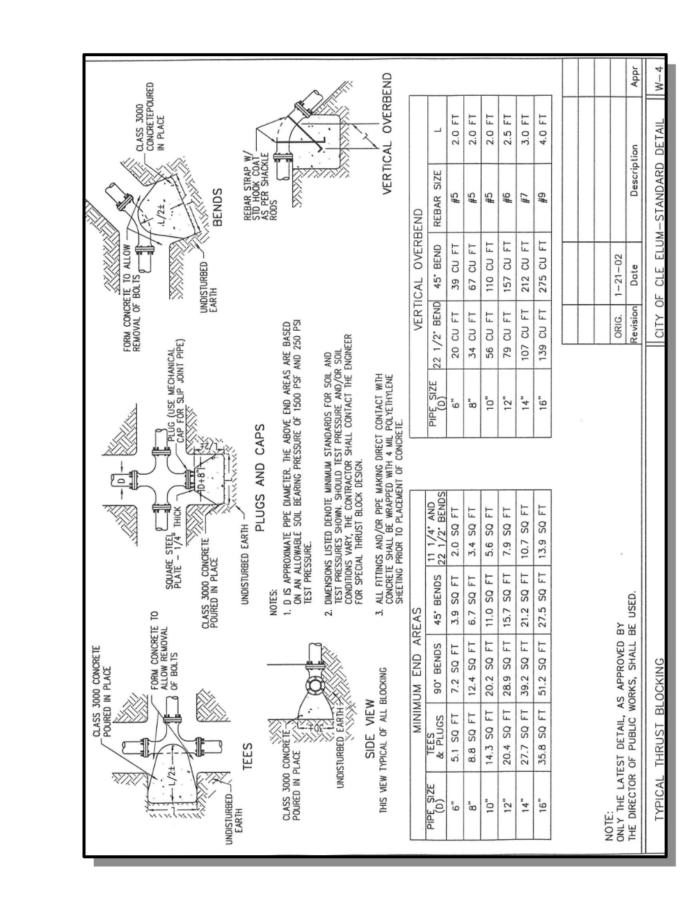

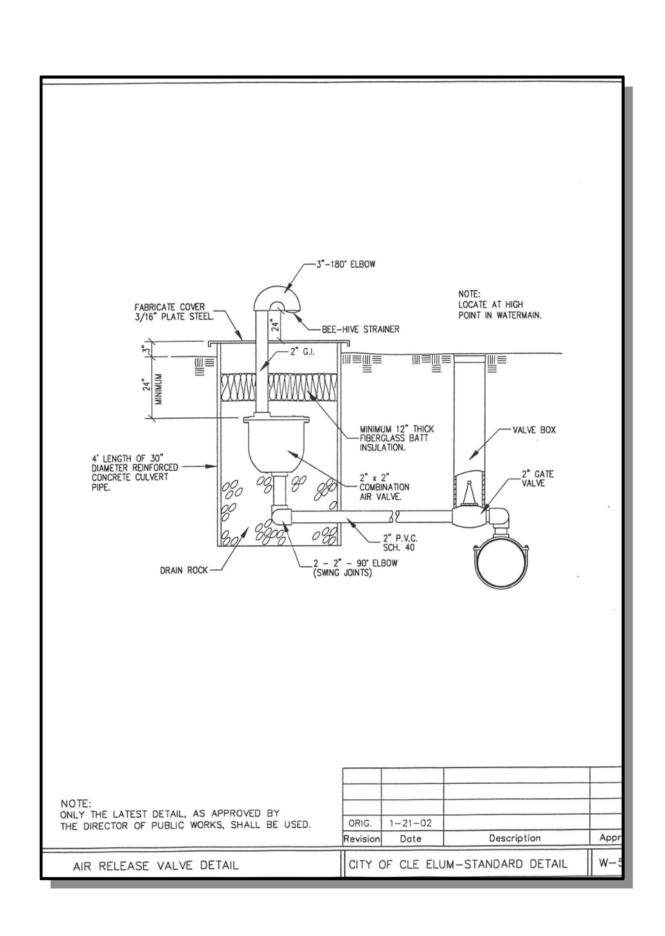

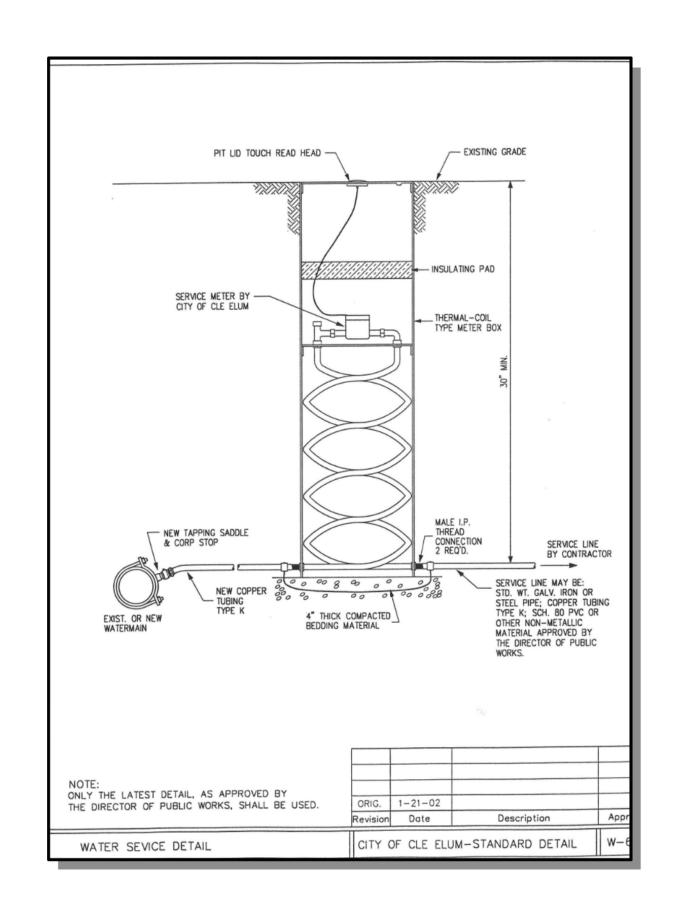


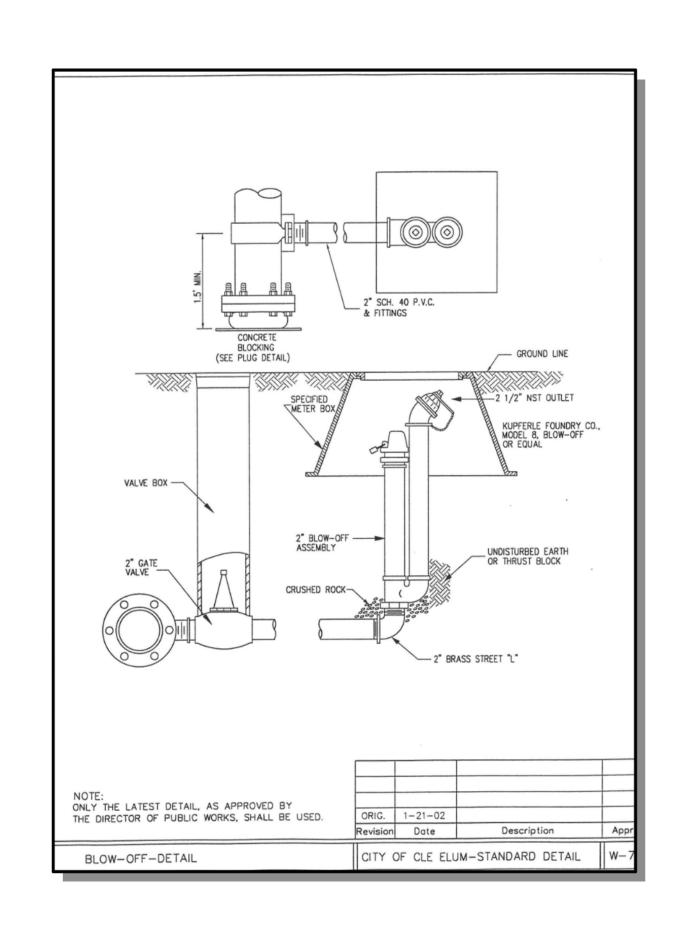


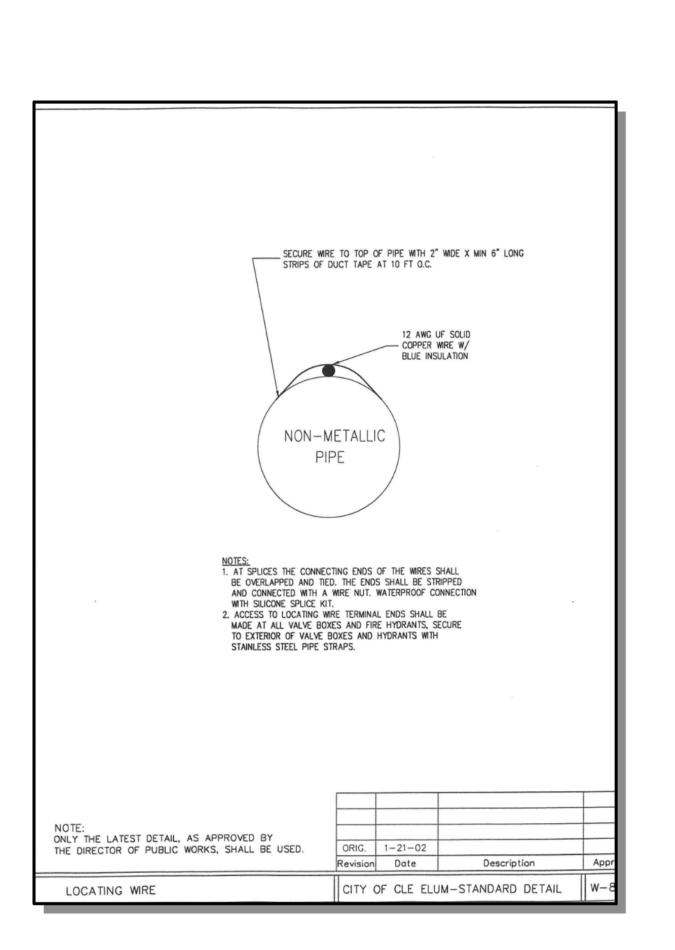

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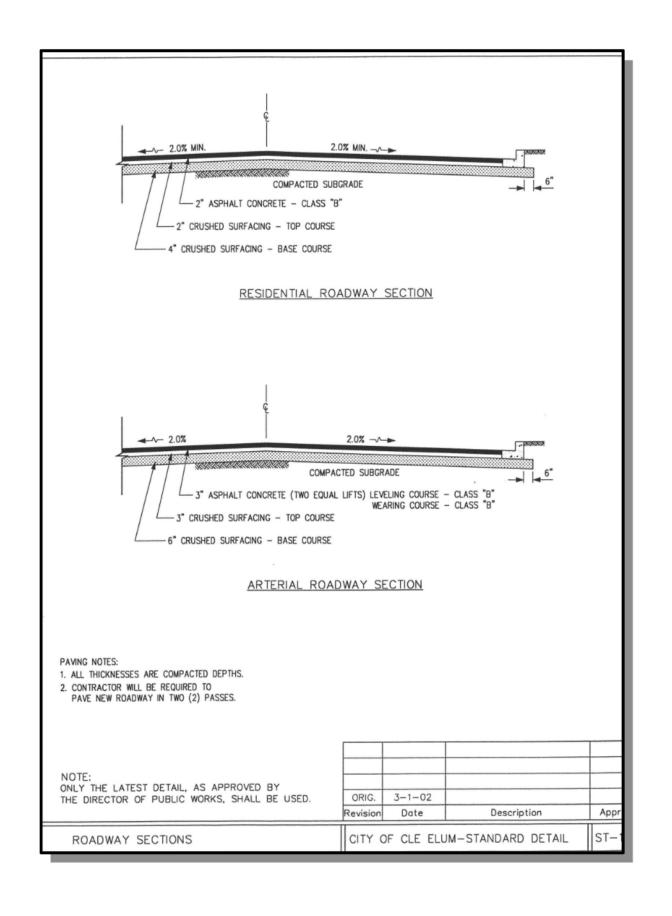


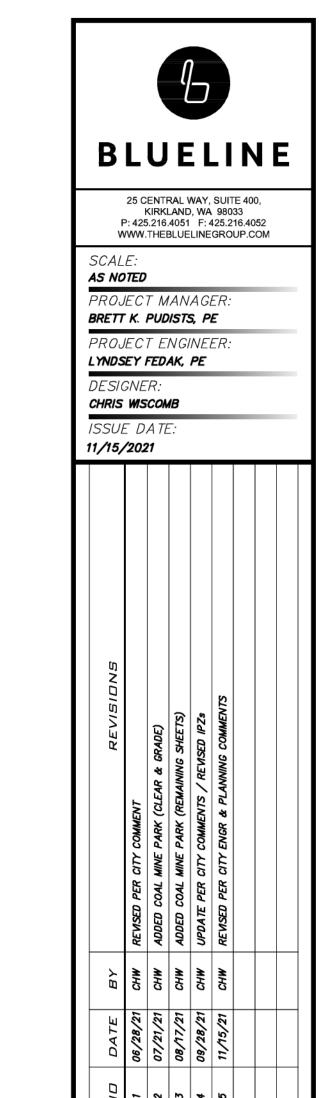



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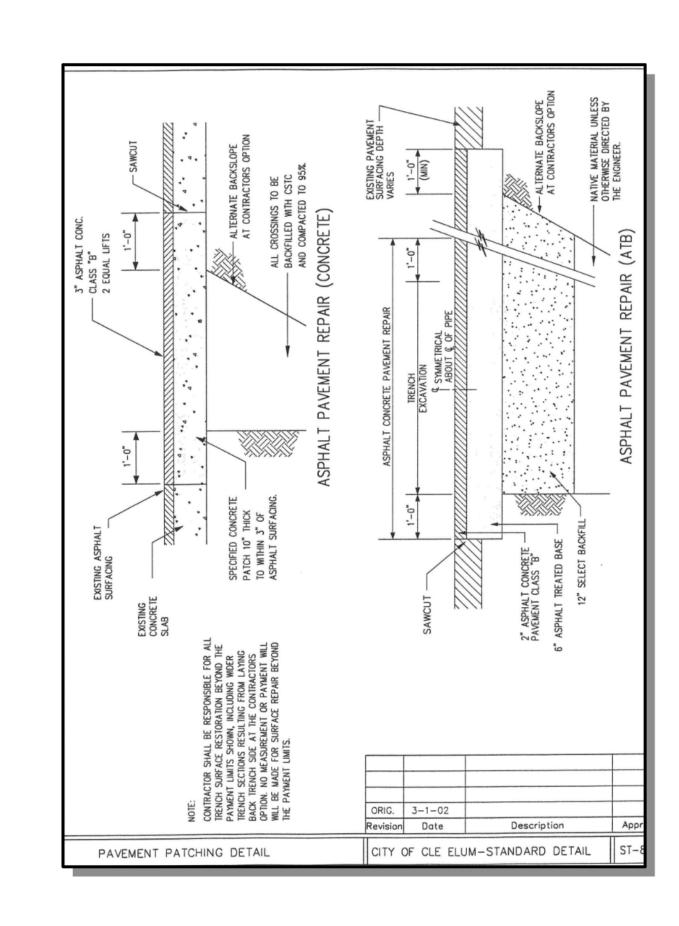
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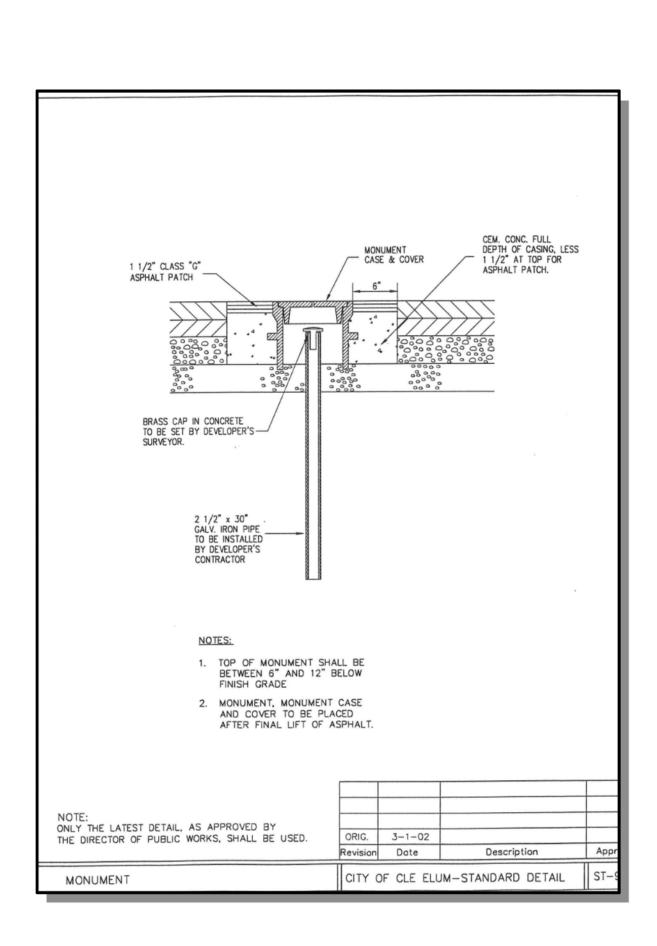
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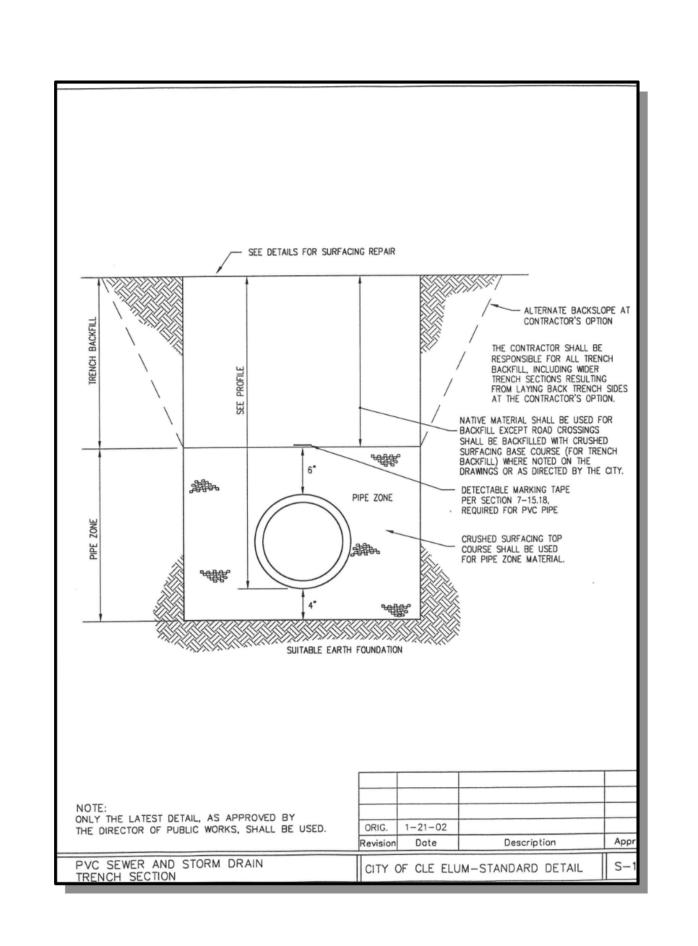


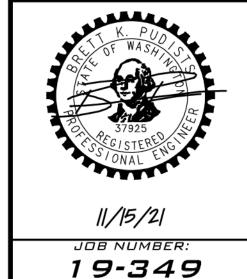







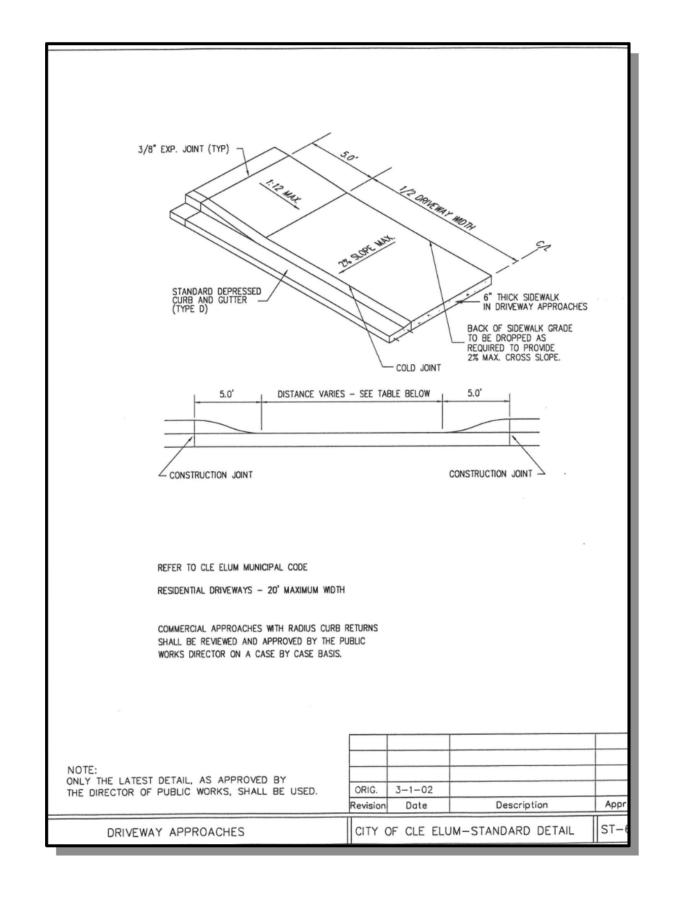

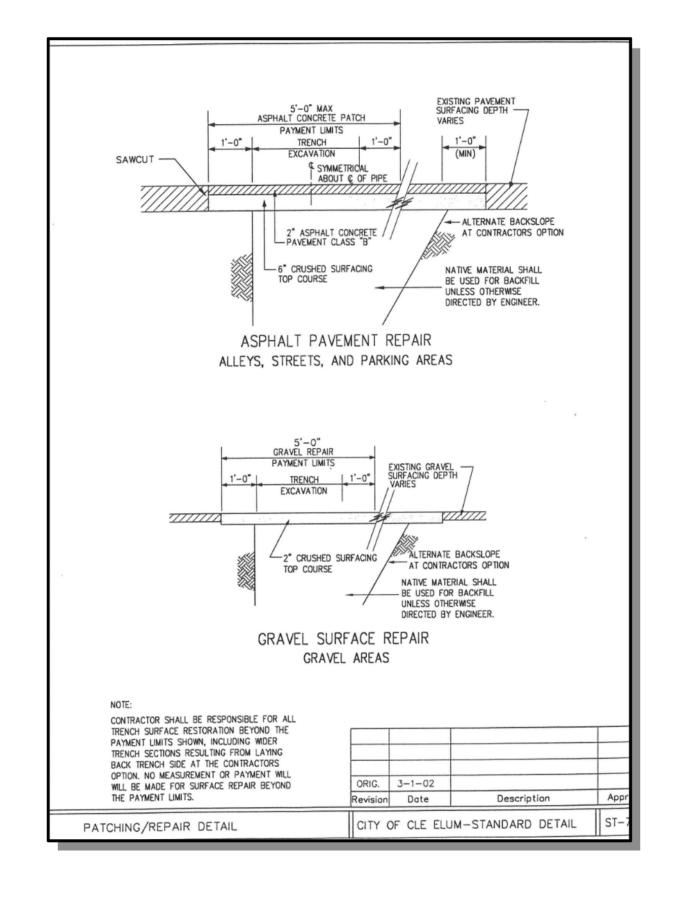


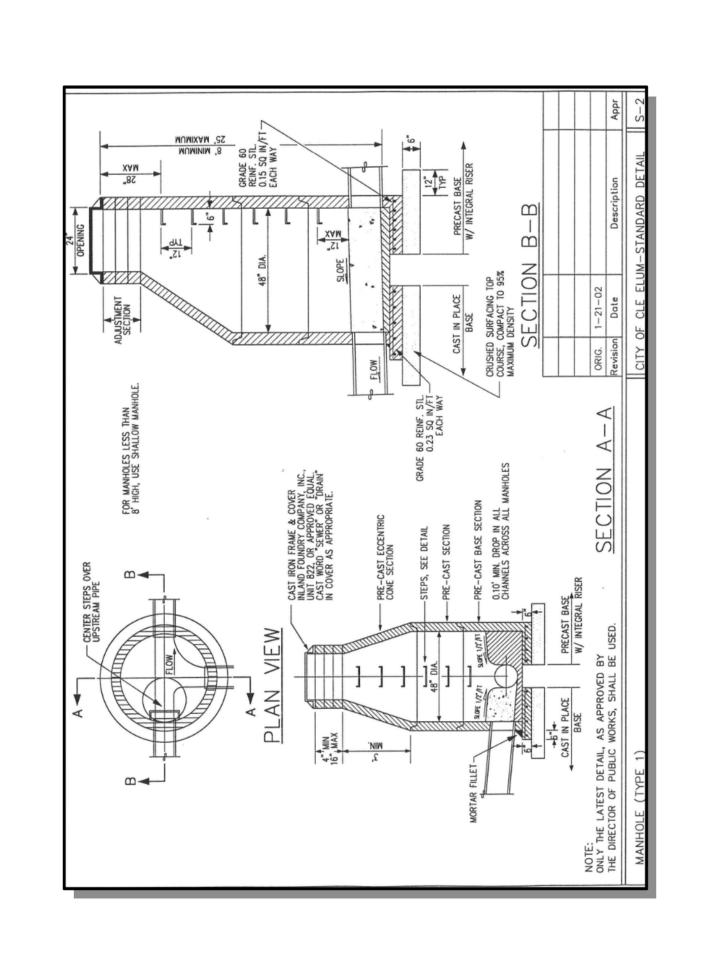

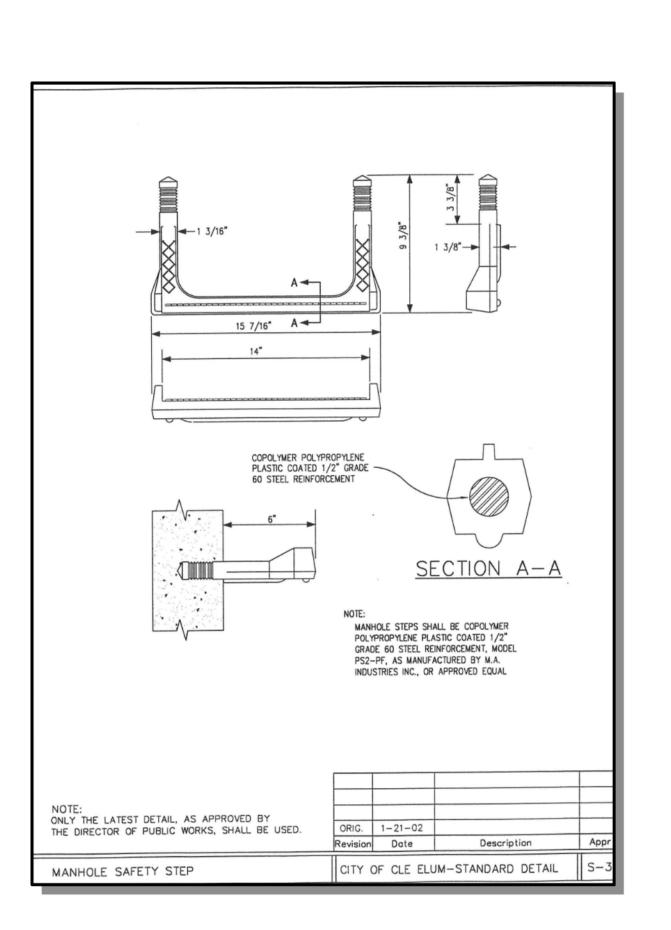

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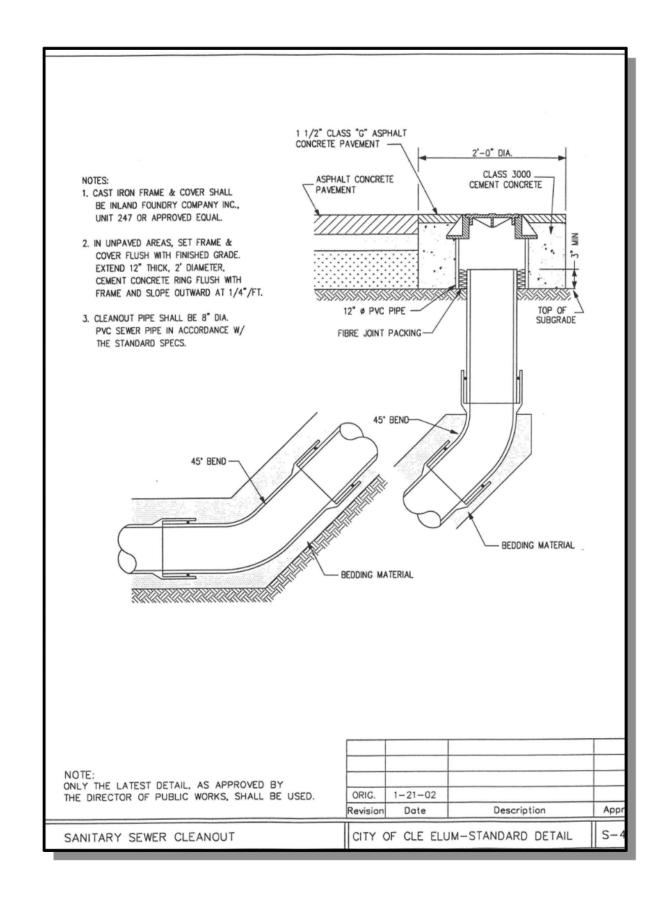
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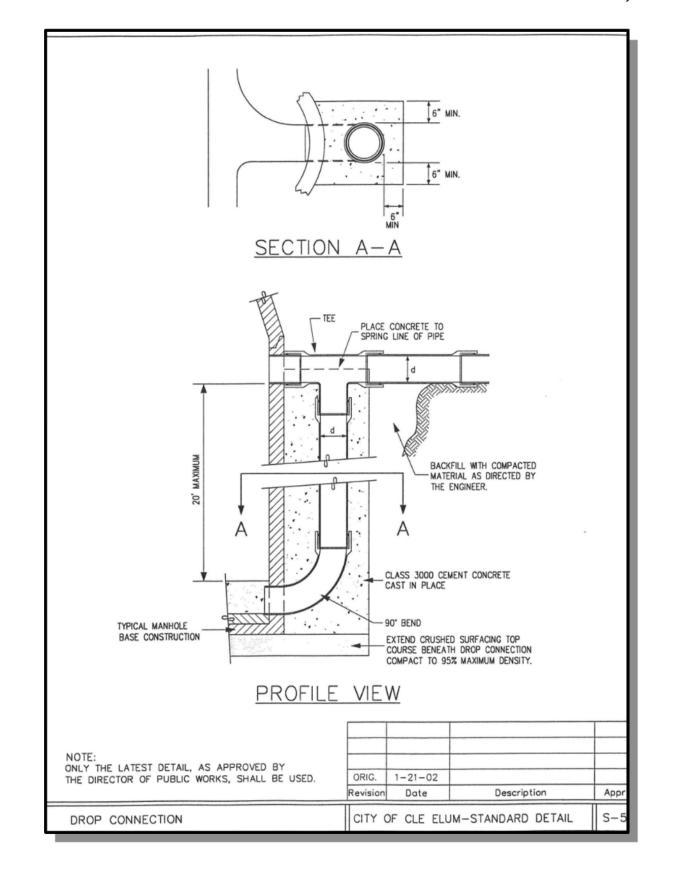
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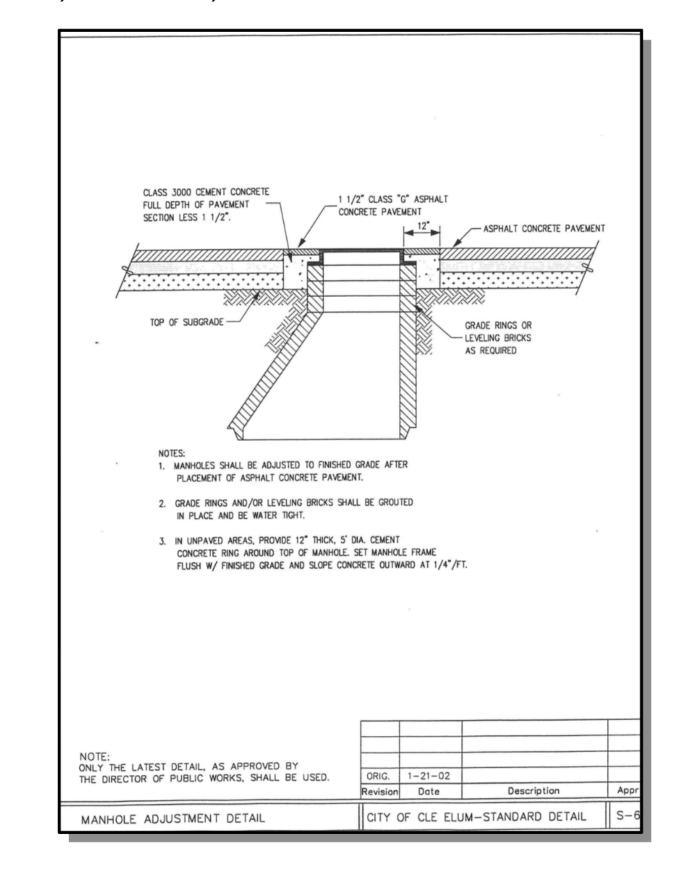
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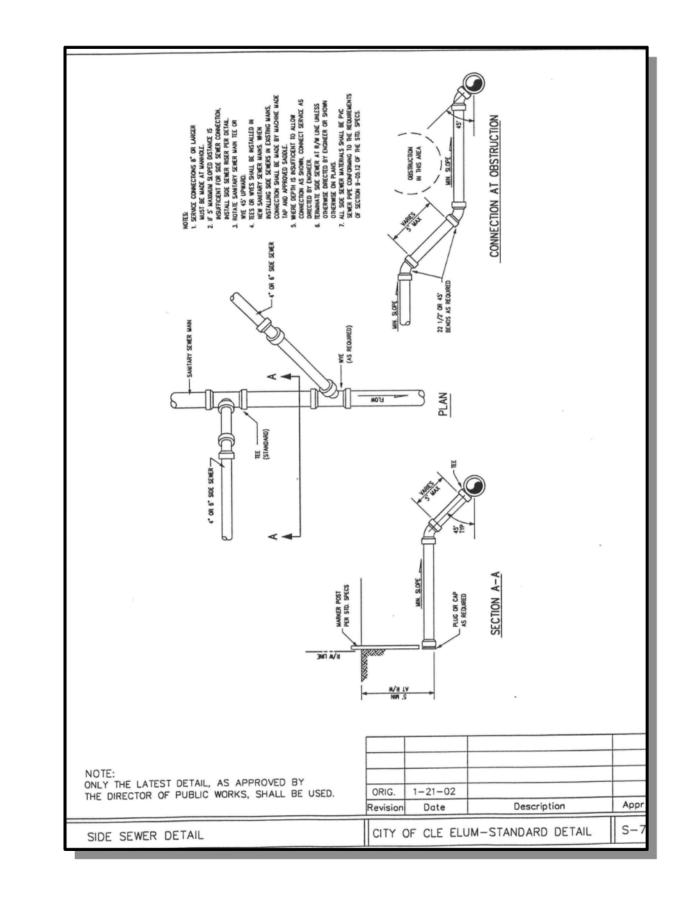
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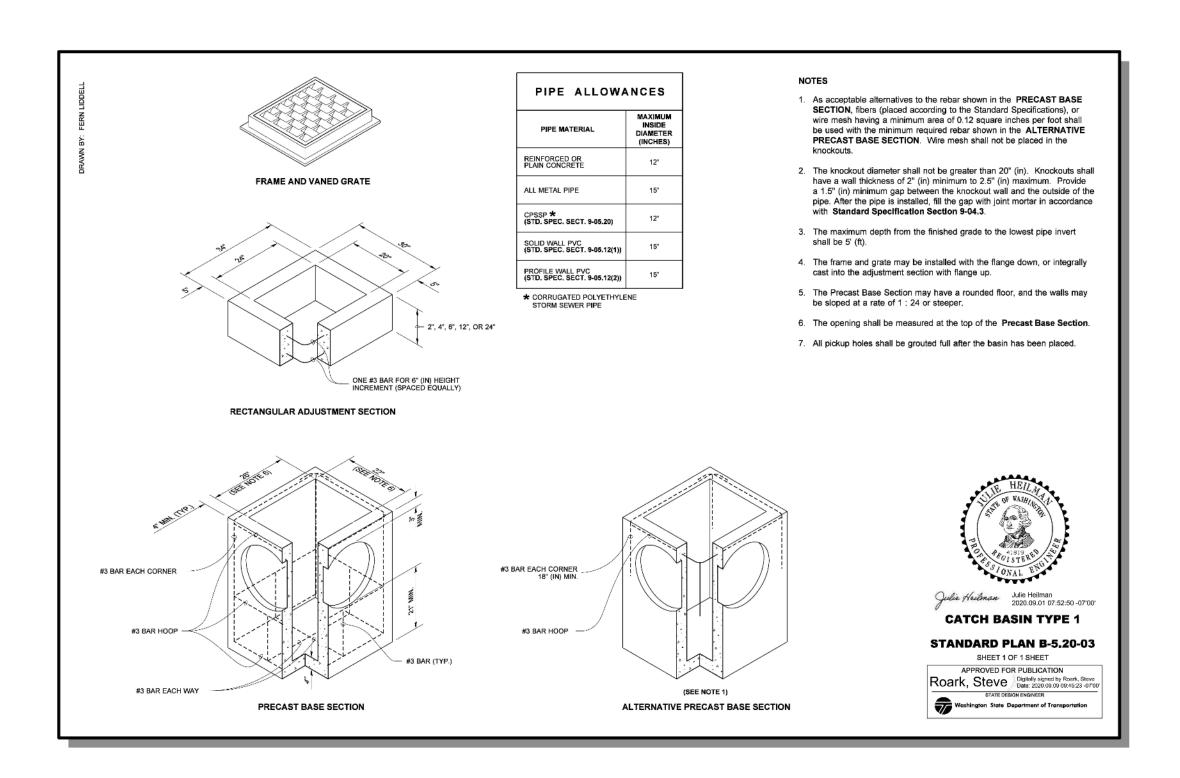
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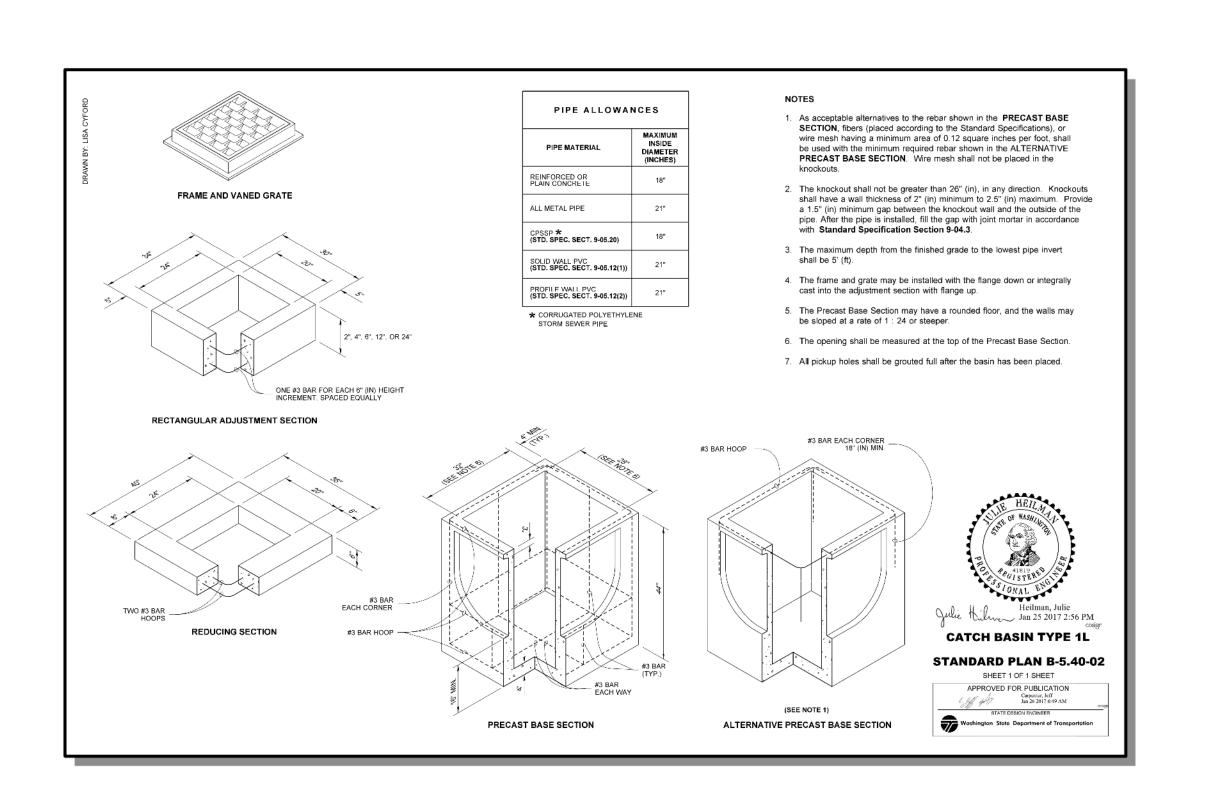




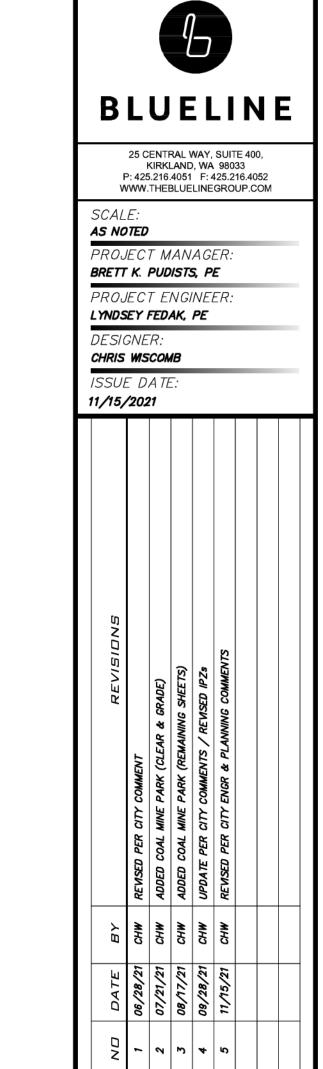








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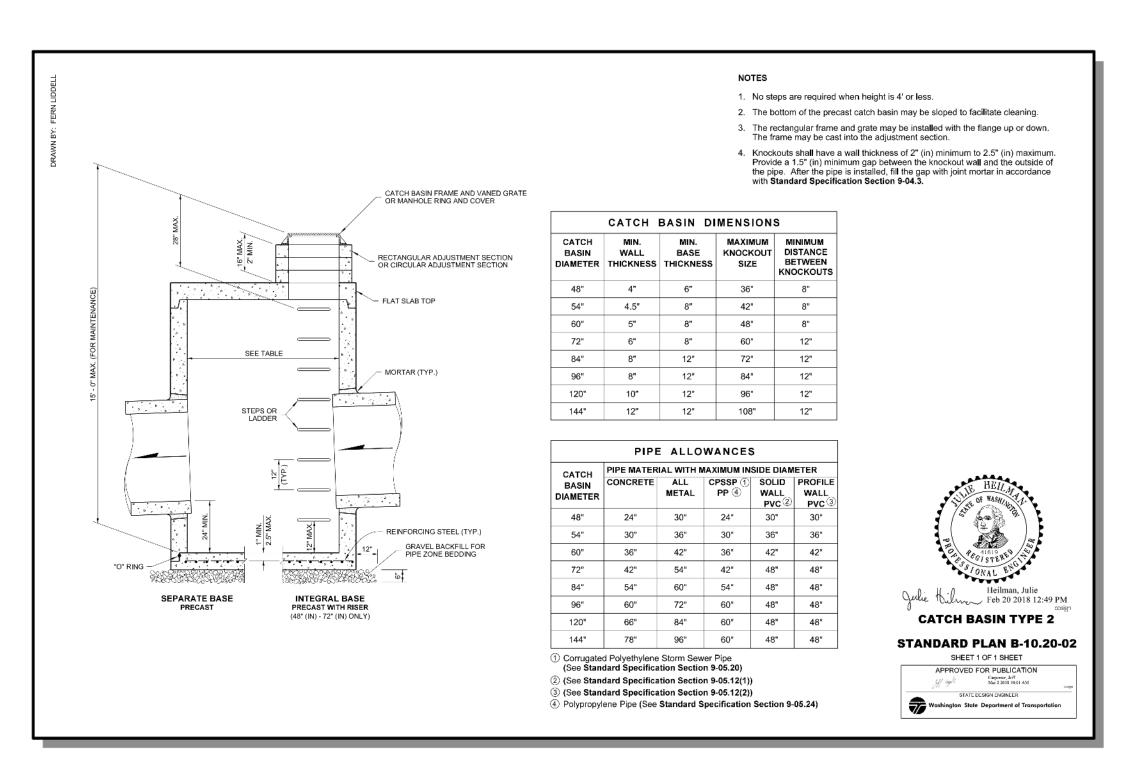
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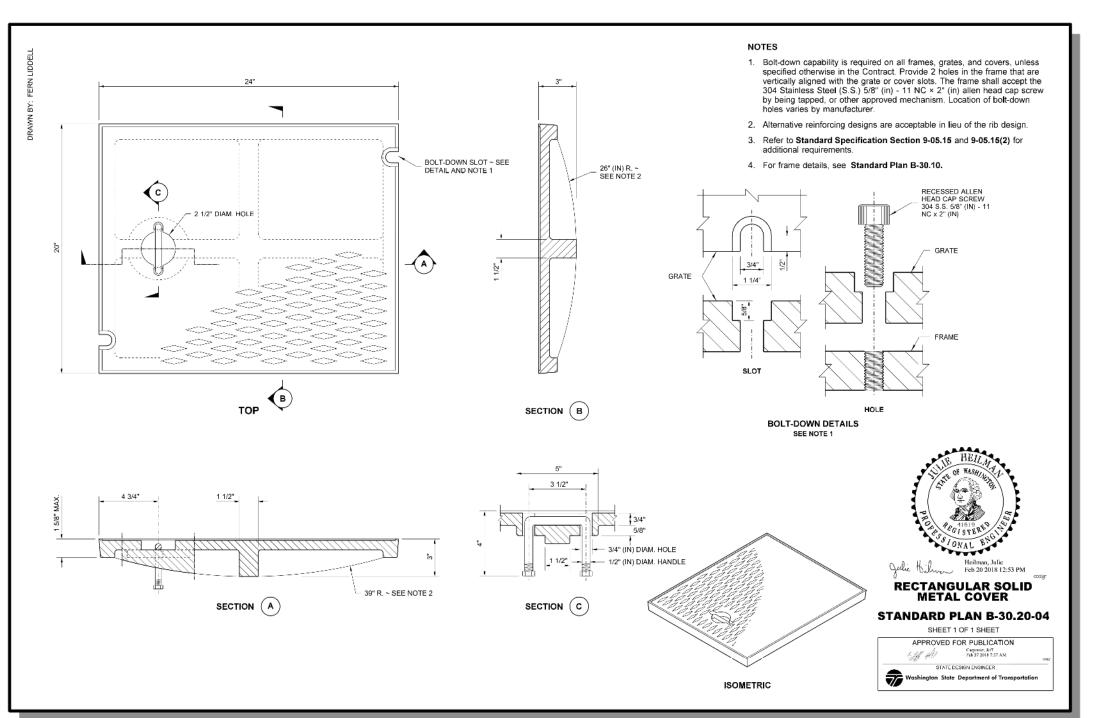



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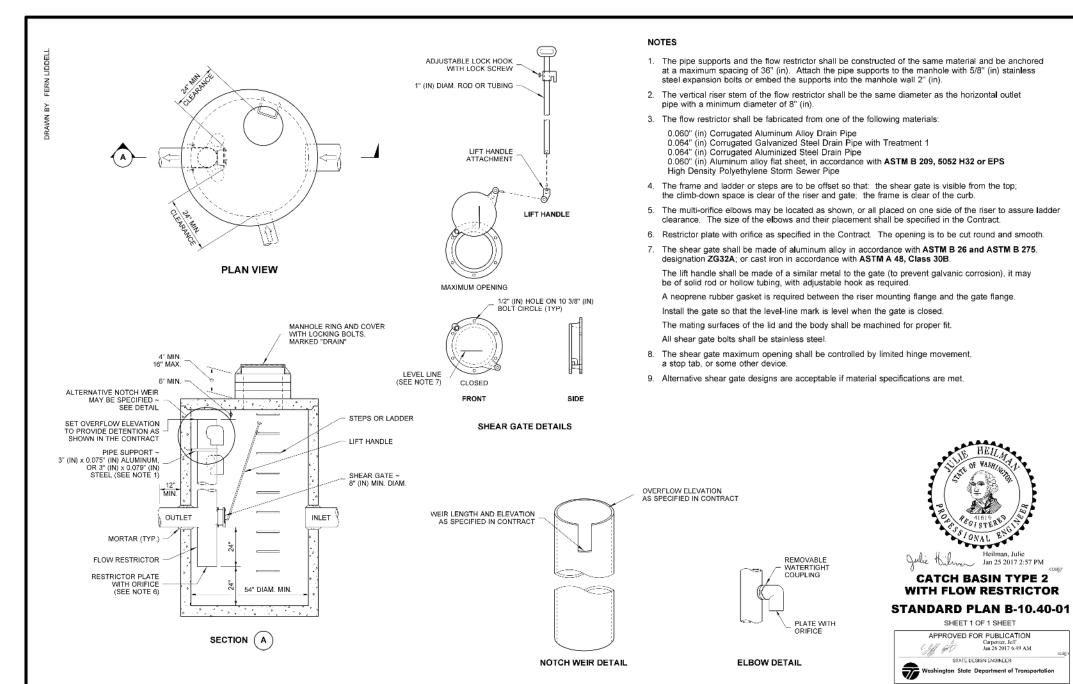
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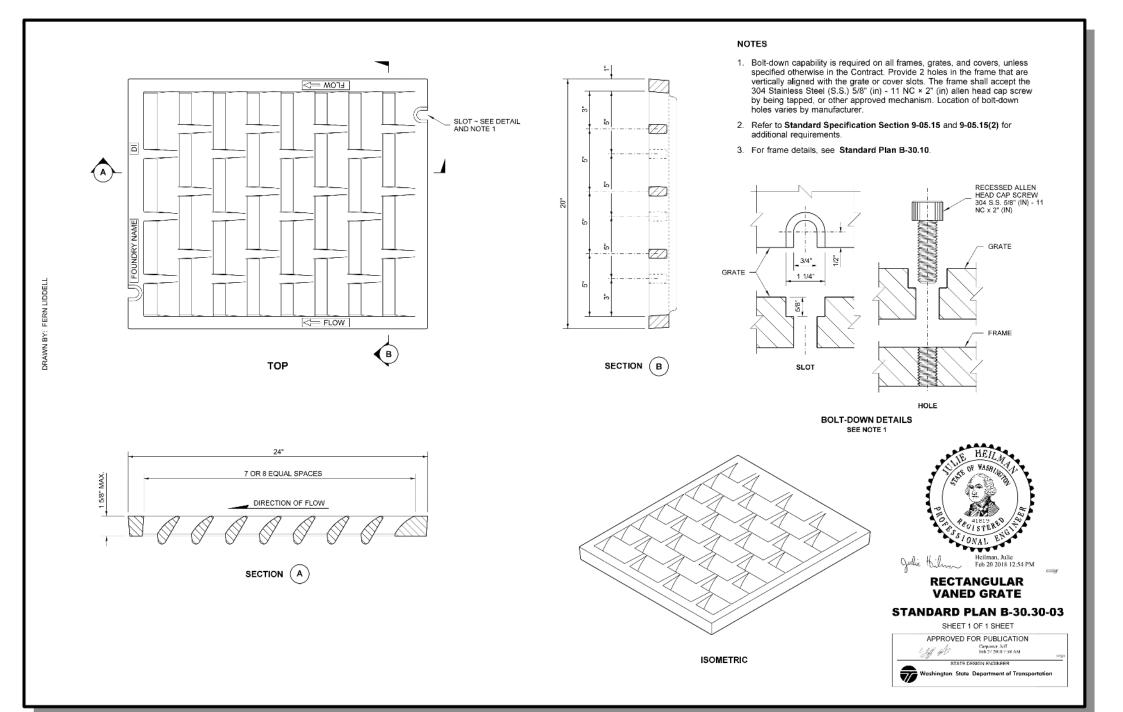
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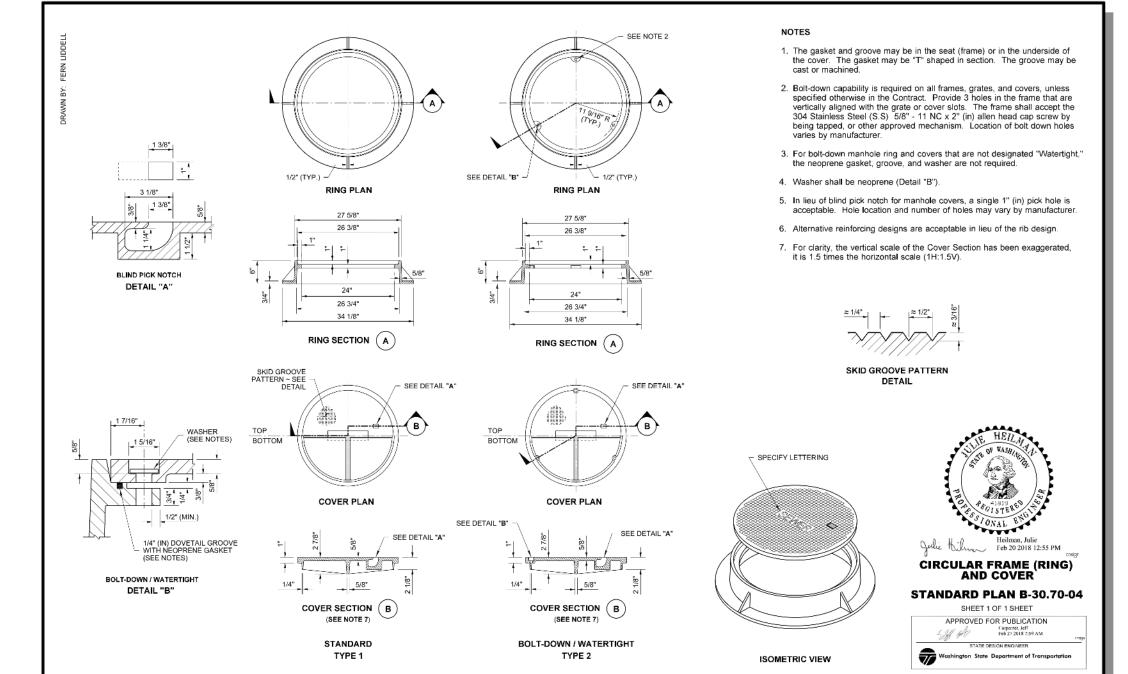


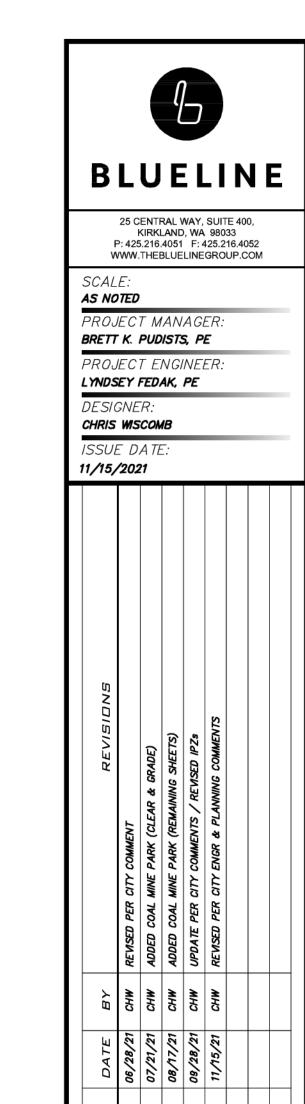










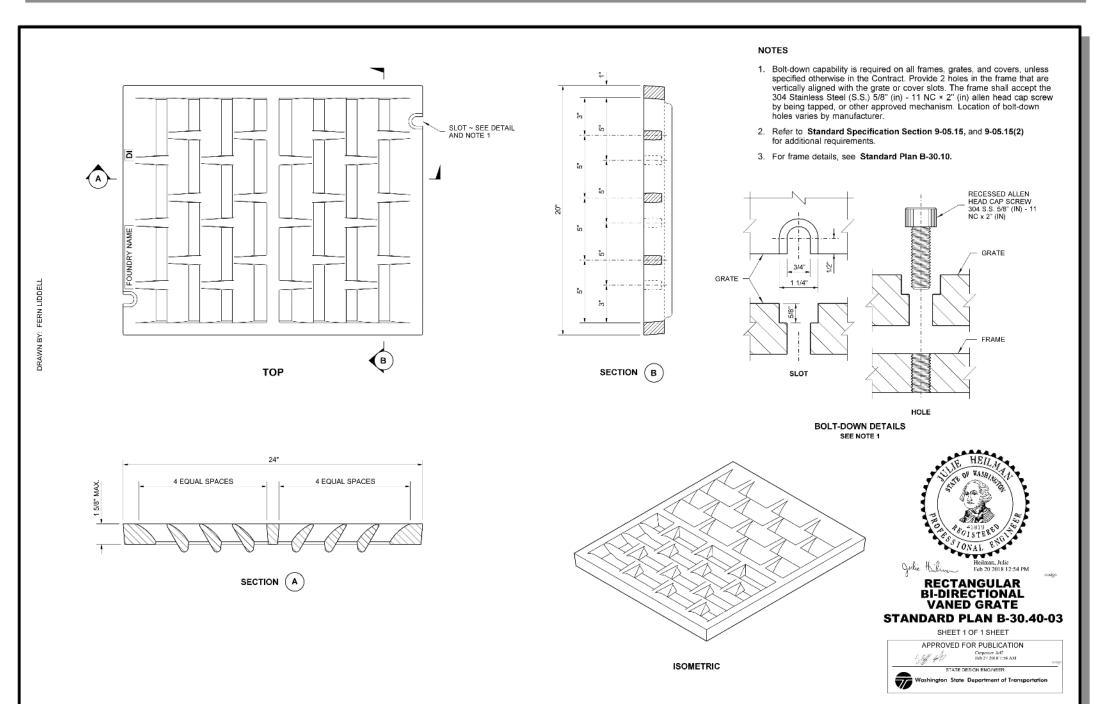

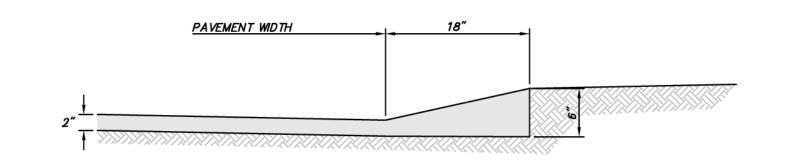

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DISPERSION TRENCH W/ LEVEL SPREADER
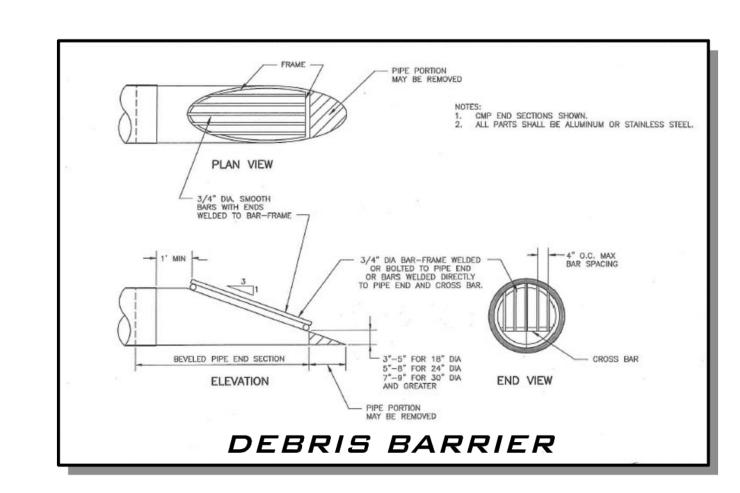
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25 CENTRAL WAY, SUITE 400, KIRKLAND, WA 98033 P: 425.216.4051 F: 425.216.4052 WWW.THEBLUELINEGROUP.COM

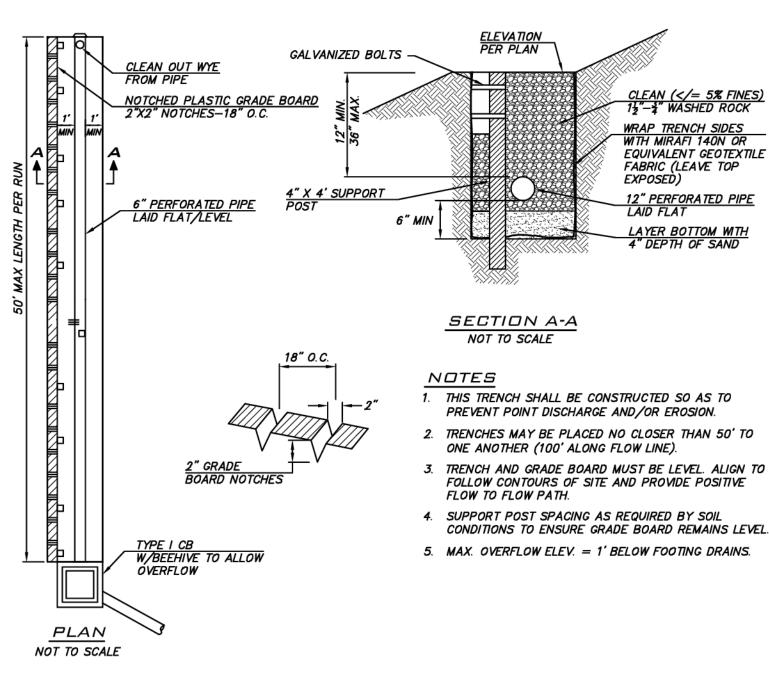AS NOTED PROJECT MANAGER: BRETT K. PUDISTS, PE


PROJECT ENGINEER: LYNDSEY FEDAK, PE


CHRIS WISCOMB 11/15/2021


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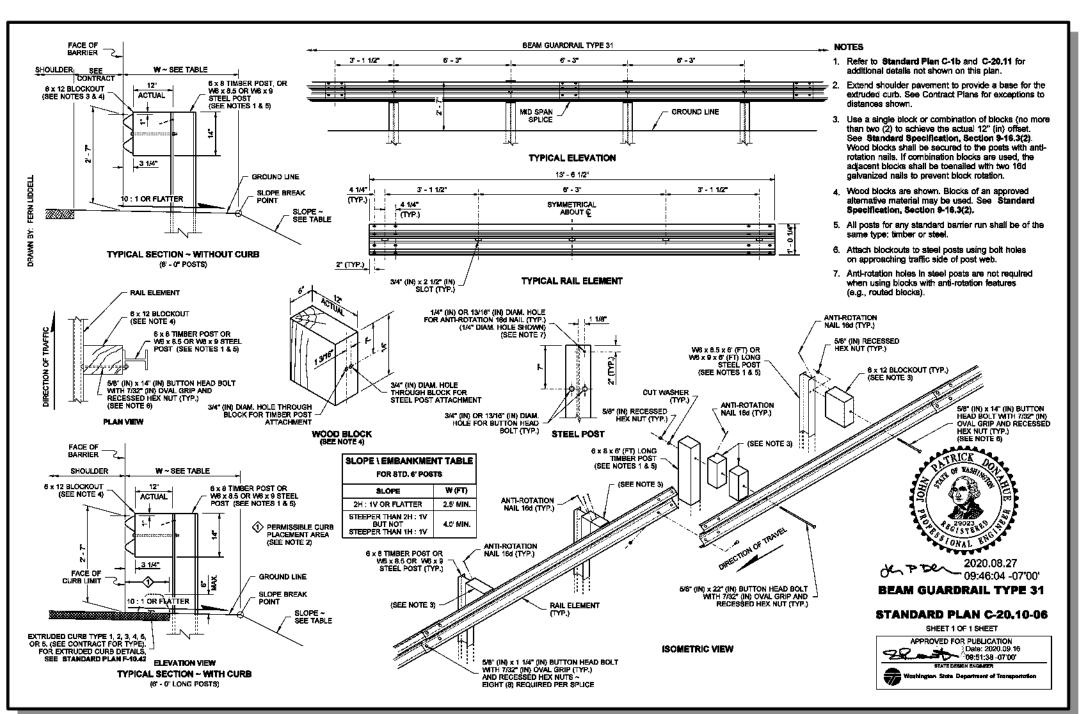
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<u>45</u> of <u>48</u>





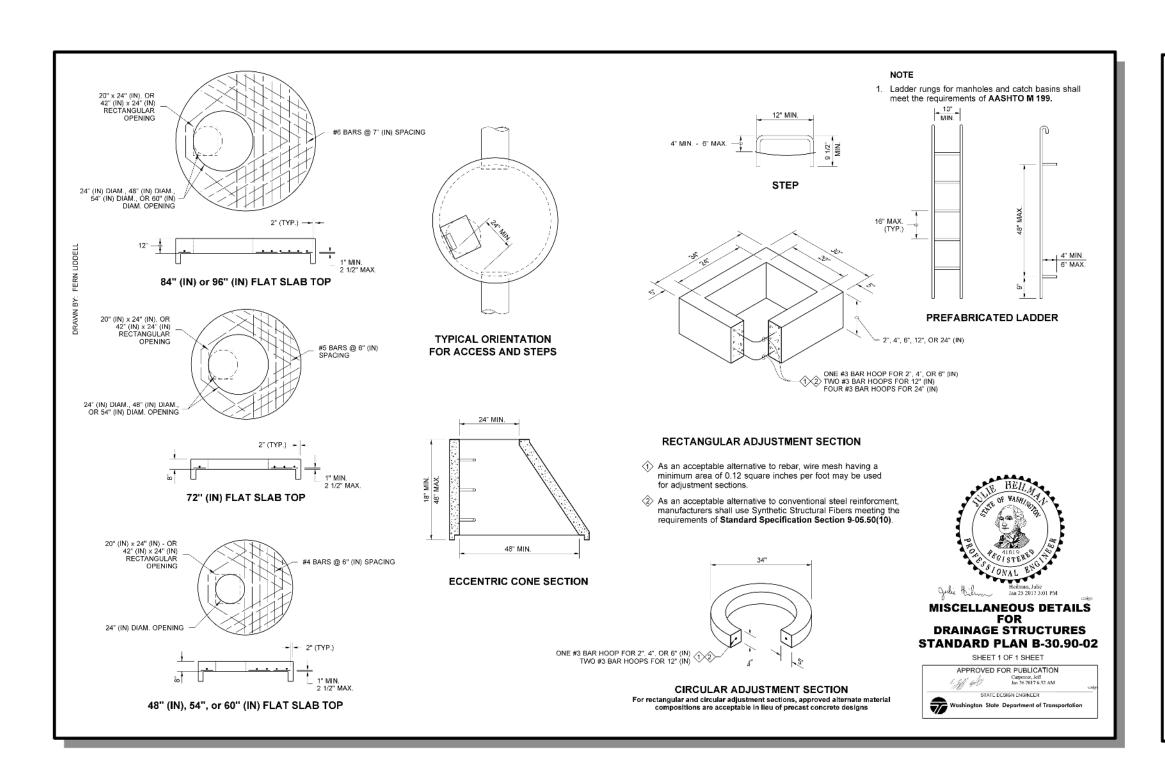

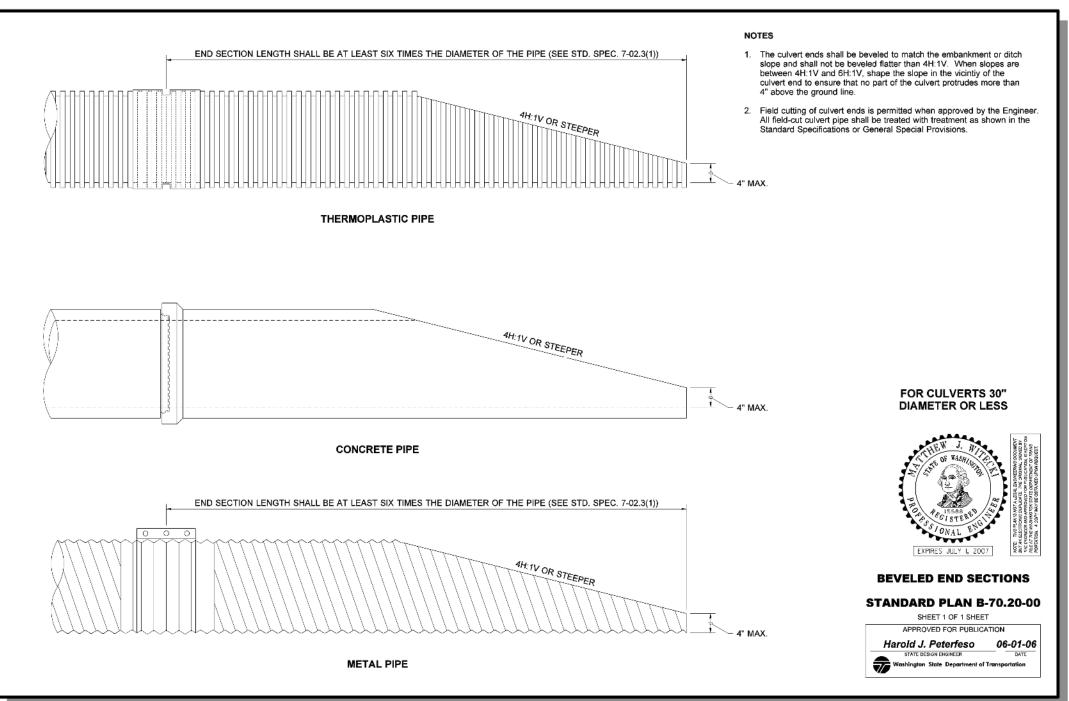

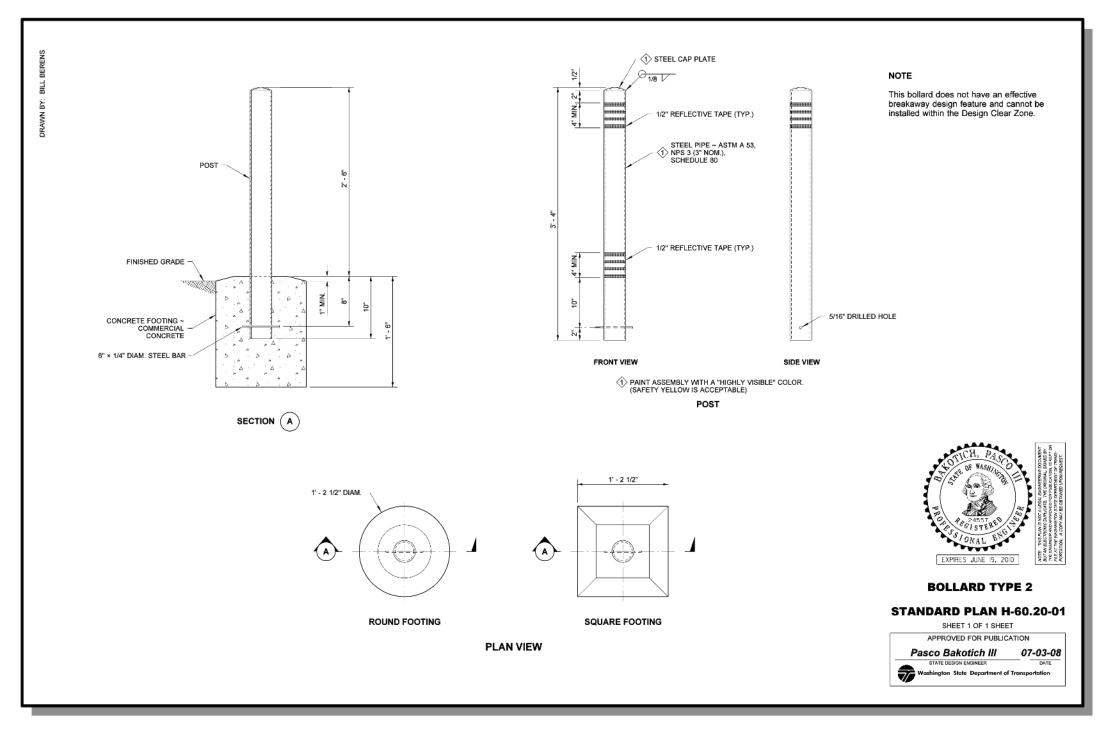

25 CENTRAL WAY, SUITE 400, KIRKLAND, WA 98033 P: 425.216.4051 F: 425.216.4052 WWW.THEBLUELINEGROUP.COM

SCALE:

AS NOTED PROJECT MANAGER: BRETT K. PUDISTS, PE

PROJECT ENGINEER: LYNDSEY FEDAK, PE

DESIGNER: CHRIS WISCOMB

11/15/2021


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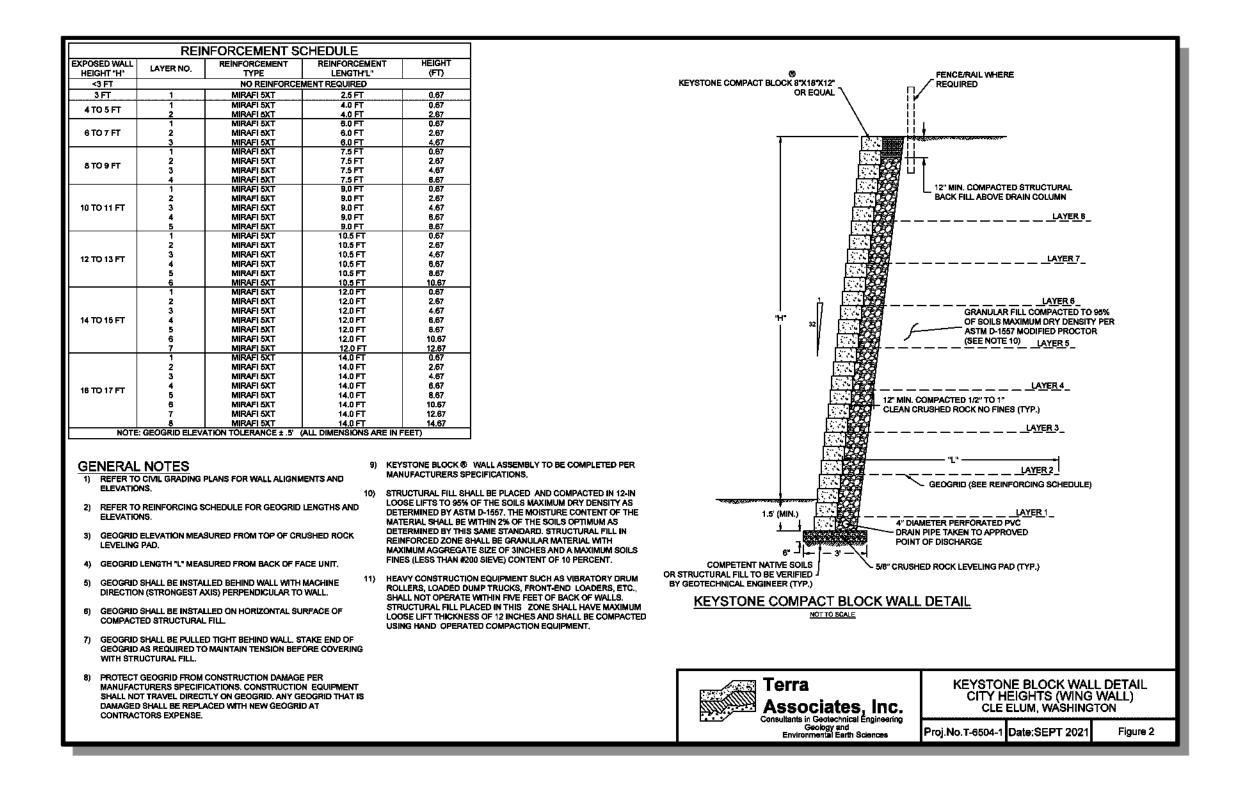
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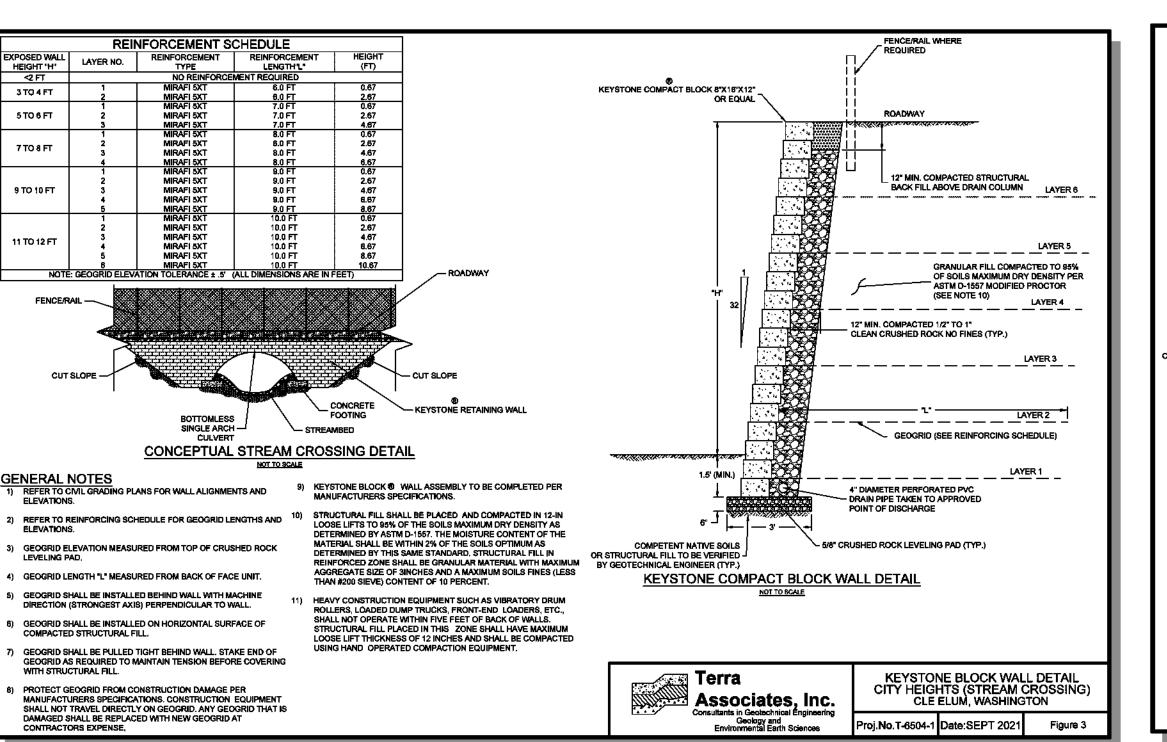
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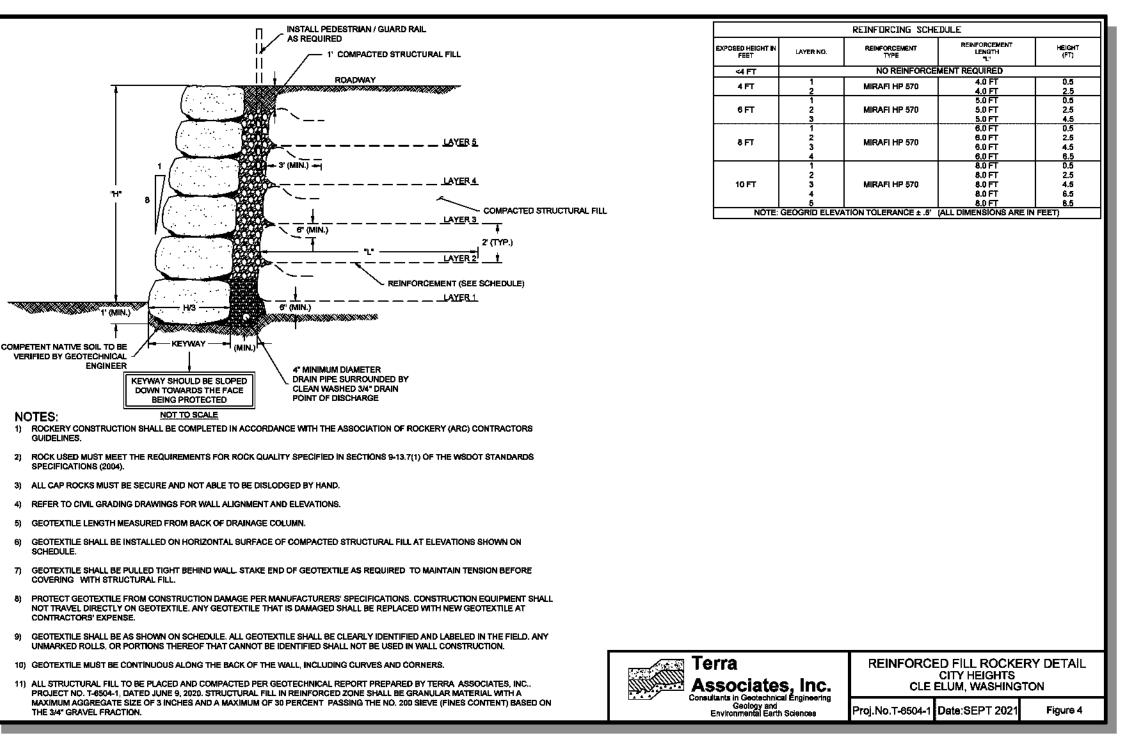
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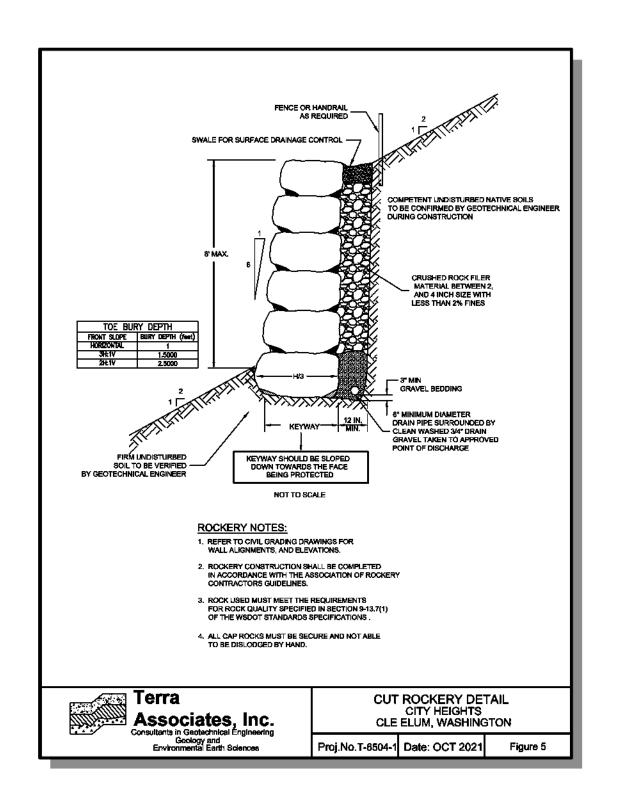
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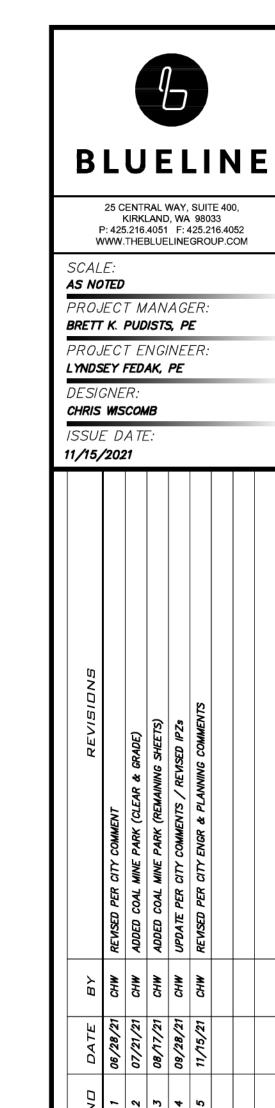






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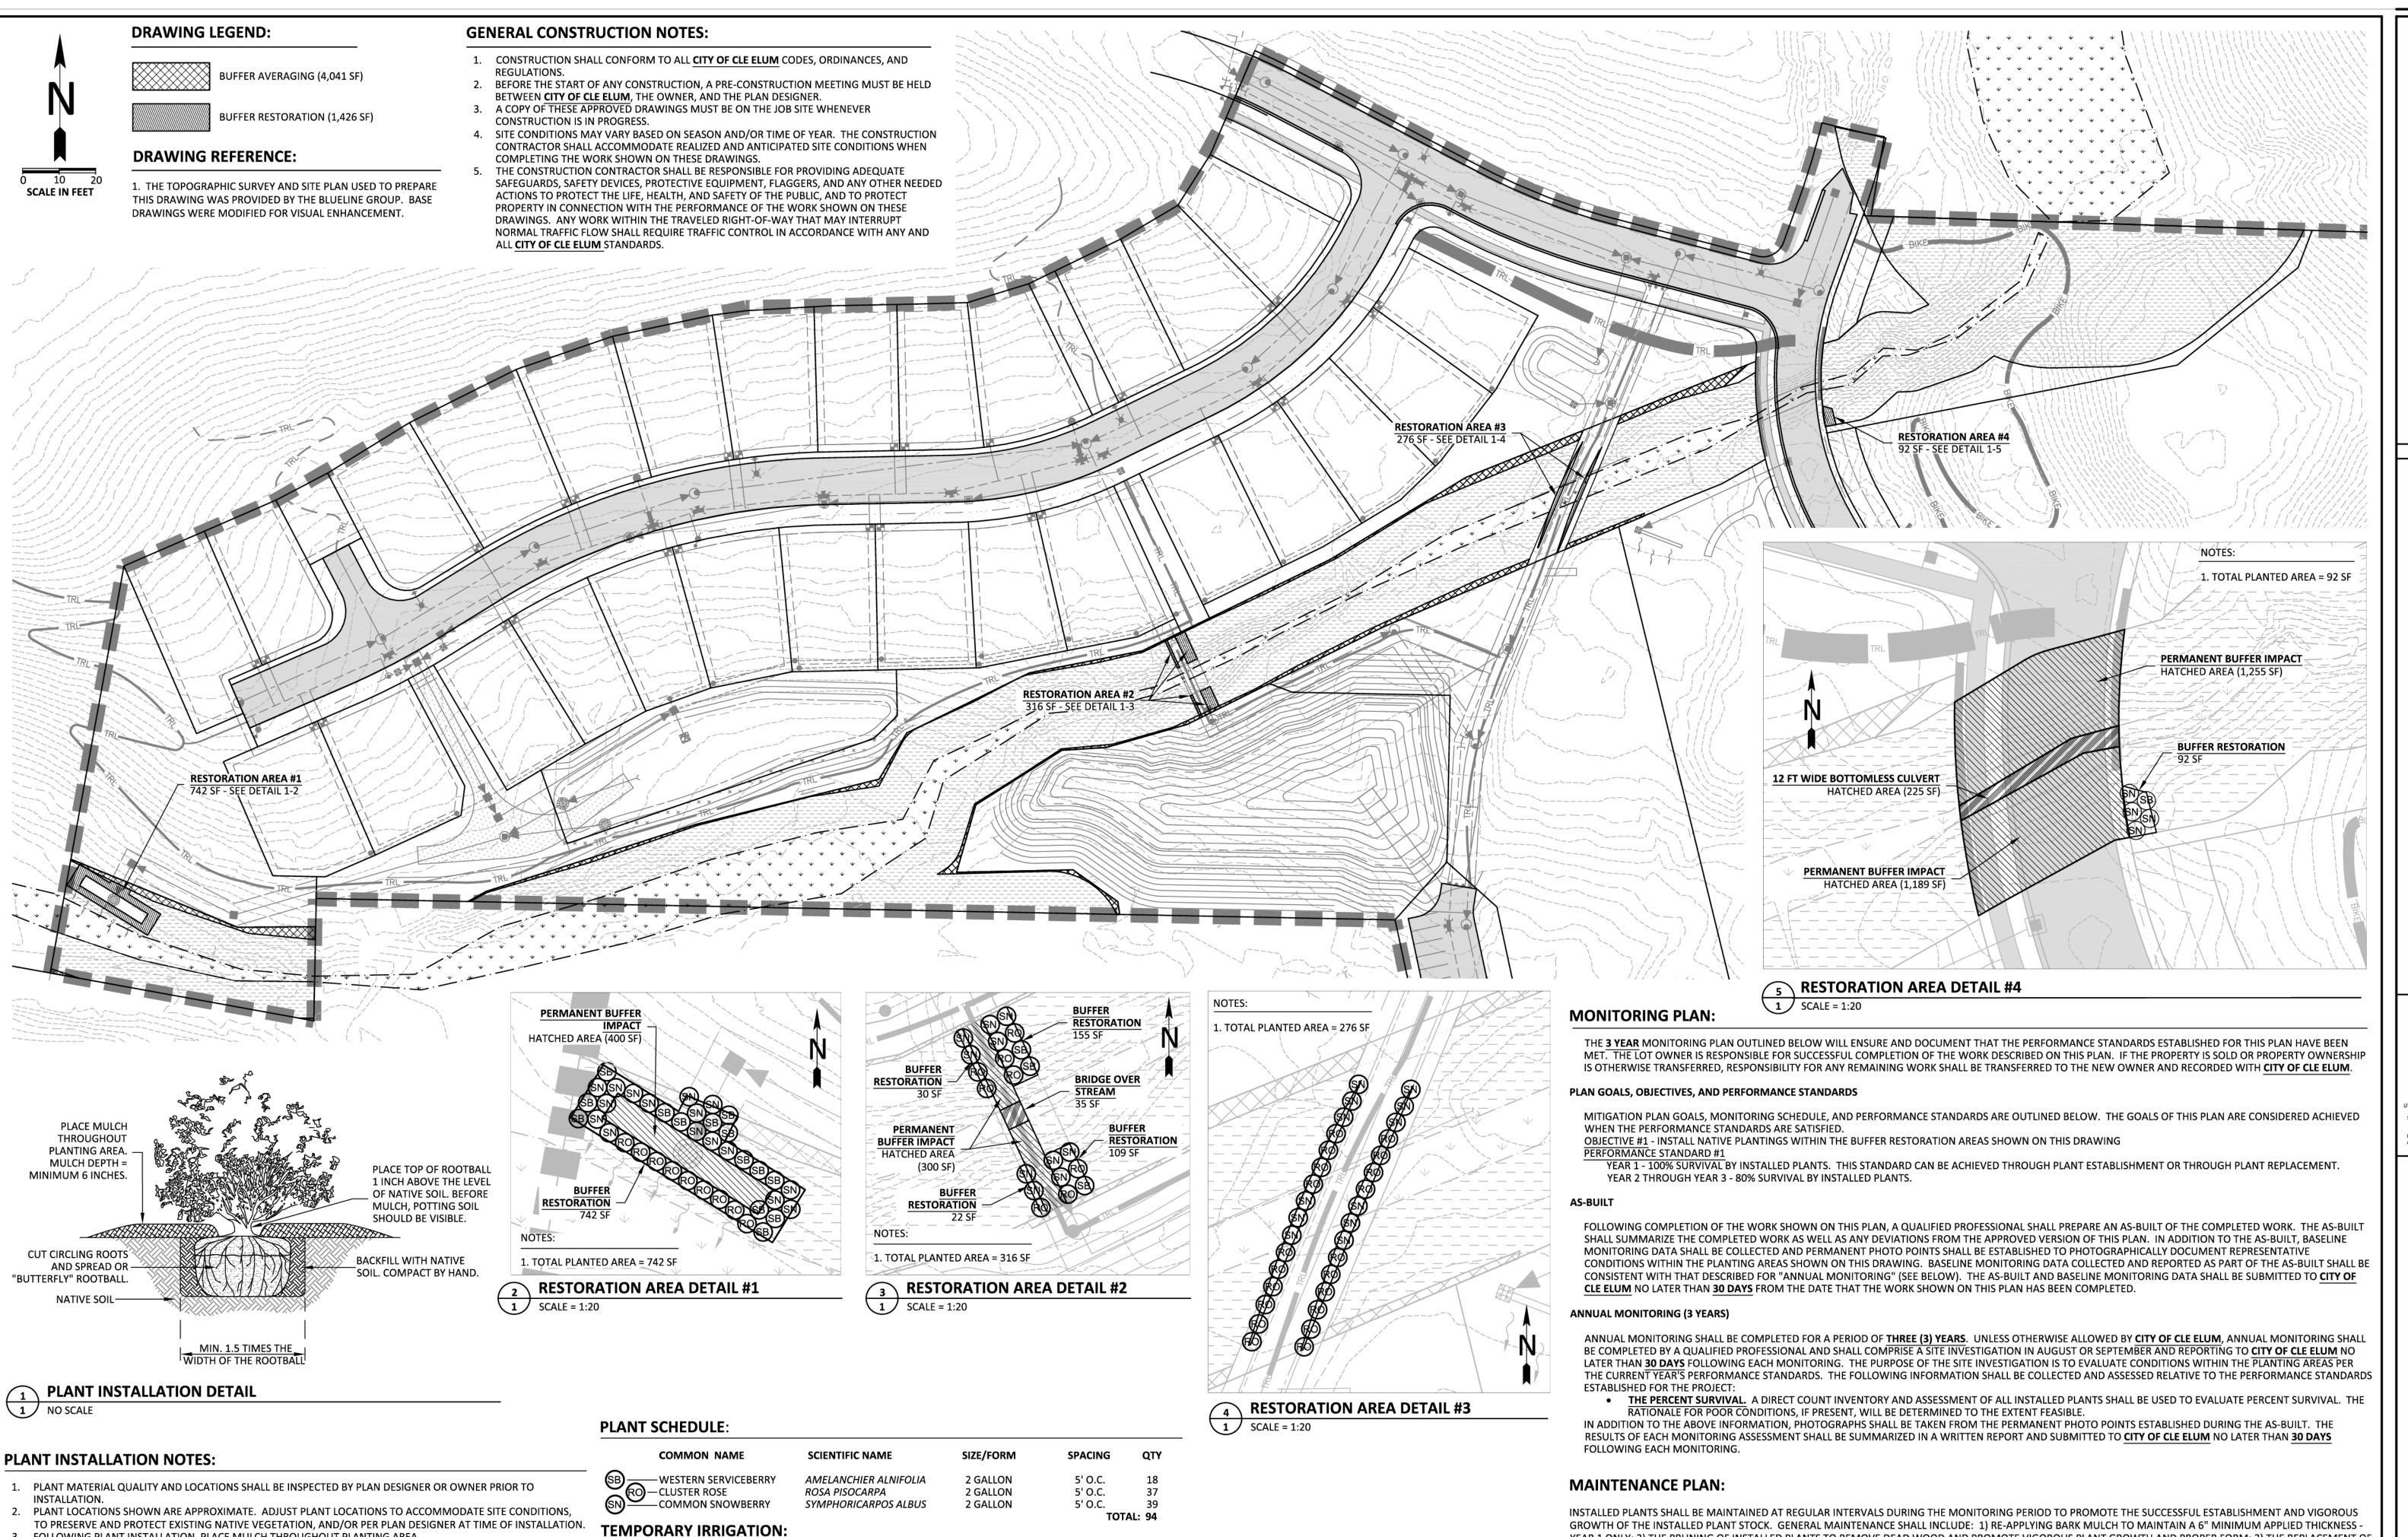
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19-349 SHEET NAME: DT-06

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TEMPORARY IRRIGATION SHALL BE PROVIDED FOR TWO (2) GROWING SEASONS FOLLOWING PLANT INSTALLATION.

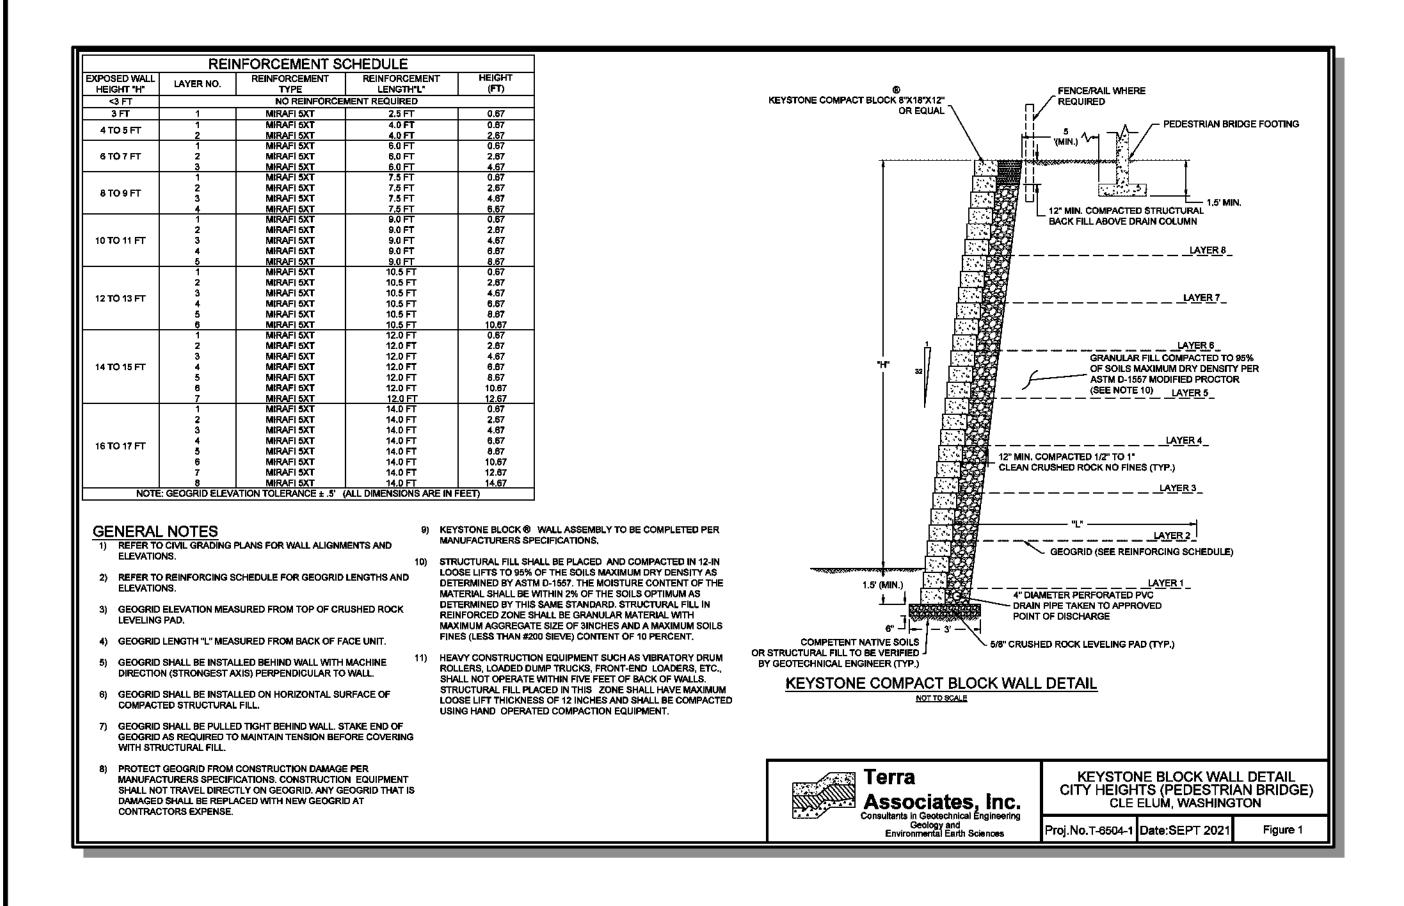SEPTEMBER 15. IRRIGATION SHALL BE APPLIED IN A MANNER THAT MAINTAINS PLANT HEALTH, PREVENTS WILTING, AND

MULCH SHALL BE COMMERCIALLY AVAILABLE "MEDIUM MULCH", ARBORIST CHIPS, OR APPROVED EQUAL. MULCH SHALL

NOT CONTAIN RESIN, TANNIN, OR OTHER COMPOUNDS IN QUANTITIES THAT WOULD BE DETRIMENTAL TO PLANT LIFE.

MULCH SHALL NOT BE DERIVED FROM STUMP GRINDINGS AND SHALL NOT CONTAIN SOIL. HOG FUEL OR EQUAL IS NOT

ACCEPTABLE. SUBJECT TO REVIEW BY THE PLAN DESIGNER, LOCAL ARBORIST AND/OR COMMERCIAL TREE TRIMMING

IRRIGATION SHALL PROVIDE A MINIMUM RAINFALL EQUIVALENT OF 1 INCH PER WEEK FROM JUNE 15 THROUGH

PROMOTES DEEP PLANT ROOT SYSTEMS.

COMPANIES MAY BE ALTERNATIVE ACCEPTABLE MATERIAL SOURCES.

MULCH SPECIFICATION:

FOLLOWING PLANT INSTALLATION, PLACE MULCH THROUGHOUT PLANTING AREA.

PLANTS SHALL BE DERIVED FROM STOCK ACCLIMATED TO WESTERN WASHINGTON ENVIRONMENTAL CONDITIONS,

PLANTS SHALL BE NORMAL IN PATTERN OF GROWTH, HEALTHY, WELL-BRANCHED AND HAVE ALL LEADERS AND BUDS

INTACT. TREES SHALL NOT HAVE SUNSCALDS, DISFIGURING KNOTS, FRESH CUTS OF LIMBS, DAMAGED LEADERS,

CONTAINERIZED PLANT STOCK SHALL BE GROWN IN A CONTAINER LONG ENOUGH TO DEVELOP A ROOT SYSTEM

THAT REACHES THE EDGES OF THE CONTAINER IN WHICH IT HAS GROWN. TREES AND SHRUBS SHALL BE WELL

ROOTED AND SHALL HAVE SUFFICIENT ROOT MASS TO HOLD TOGETHER THE SOIL, IN WHICH PLANT IS GROWING,

PLANTS SHALL BE NATIVE TO THE PACIFIC NORTHWEST, PREFERABLY THE EASTERN CASCADE SLOPE REGION OF WASHINGTON STATE. PLANTS SHALL BE PROPAGATED FROM NATIVE STOCK. SALVAGED PLANTS ARE ACCEPTABLE.

PLANT MATERIAL SPECIFICATIONS:

AND/OR DEFORMED TRUNKS.

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GROWTH OF THE INSTALLED PLANT STOCK. GENERAL MAINTENANCE SHALL INCLUDE: 1) RE-APPLYING BARK MULCH TO MAINTAIN A 6" MINIMUM APPLIED THICKNESS -YEAR 1 ONLY; 2) THE PRUNING OF INSTALLED PLANTS TO REMOVE DEAD WOOD AND PROMOTE VIGOROUS PLANT GROWTH AND PROPER FORM; 3) THE REPLACEMENT OF PLANTS THAT APPEAR TO BE IN DISTRESS AND/OR DISEASED; 4) THE REMOVAL OF TRASH, LITTER, AND/OR OTHER NON-DECOMPOSING DEBRIS. GENERAL MAINTENANCE WORK SHALL OCCUR MONTHLY DURING THE GROWING SEASON AND/OR AT A FREQUENCY OTHERWISE NECESSARY TO ENSURE THE SUCCESSFUL ESTABLISHMENT AND VIGOROUS GROWTH OF THE INSTALLED PLANTS.

CONTINGENCY PLAN:

SHOULD ANY MONITORING ASSESSMENT REVEAL THAT THE PERFORMANCE STANDARDS FOR THE RESPECTIVE YEAR ARE NOT SATISFIED, THE PERMITTEE SHALL WORK WITH CITY OF CLE ELUM TO DEVELOP A CONTINGENCY PLAN TO ADDRESS THE DEFICIENCY(IES). CONTINGENCY PLANS CAN INCLUDE, BUT ARE NOT LIMITED TO, THE FOLLOWING ACTIONS: 1) ADDITIONAL PLANT INSTALLATION; 2) EROSION CONTROL; 3) HERBIVORY PROTECTION; 4) MODIFICATION TO THE IRRIGATION REGIME; AND/OR 5) PLANT SUBSTITUTIONS OF TYPE, SIZE, QUANTITY, AND LOCATION. SUCH CONTINGENCY PLAN SHALL BE SUBMITTED TO CITY OF CLE ELUM WITHIN 30 DAYS OF WHEN DEFICIENCIES ARE DISCOVERED. UNLESS OTHERWISE APPROVED BY CITY OF CLE ELUM, ACTIONS SPECIFIED ON AN APPROVED CONTINGENCY PLAN MUST BE COMPLETED WITHIN 60 DAYS. IF THE FAILURE IS SUBSTANTIAL, CITY OF CLE ELUM MAY EXTEND THE COMPLIANCE MONITORING PERIOD FOR THE ENHANCEMENT WORK.

DATE: 10/26/2020 JOB NUMBER: A9-121

PLANTING PLAN, NOTES & DETAILS

SHEET: 1 OF 1

CIVIL SET: 48 OF 48